



222 EAST 4TH AVENUE

PLANNING APPLICATION RESUBMITTAL SET
06/15/22



ISSUES AND REVISIONS

No.	Date	Description
A	05/05/20	Pre-Application Set
B	10/21/20	Pre-App Resubmittal
C	03/19/21	Pre-App Resubmittal
D	10/15/21	Planning Application Set
E	02/04/22	Planning Resubmittal

PROJECT NUMBER
16010.00

SHEET TITLE
SHEET INDEX





SCALE

SHEET NUMBER

A-001

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EP-3	LIGHT FIXTURE CUT SHEETS
TOTAL SHEETS: 73	

PROJECT DIRECTORY			ABBREVIATIONS			FLOOR AREA*			SCOPE OF WORK		
OWNER LANE PARTNERS 644 MENLO AVENUE, 2ND FLOOR MENLO PARK, CA 94025			MARCUS GILMOUR	MARCUS@LANE-PARTNERS.COM	650-665-7085				<div>DEMOLISH THE EXISTING BUILDING AT 222 E. 4TH AVENUE BETWEEN ELLSWORTH AVENUE AND B STREET. CONSTRUCT A NEW FIVE-STORY BUILDING WITH TWO LEVELS OF BELOW-GRADE PARKING. THE BUILDING HOUSES 104,554 SF OF OFFICE SPACE, 17,658 SF OF RETAIL SPACE, AND 8,997 SF OF RESIDENTIAL SPACE (INCLUDING 10 RESIDENTIAL UNITS). THE PARKING GARAGE INCLUDES 12,392 SF ABOVE GRADE AND 89,519 SF BELOW GRADE, AND PROVIDES A TOTAL OF 221 PHYSICAL PARKING SPACES. THERE ARE TWO OUTDOOR TERRACES AT LEVEL 3, TWO TERRACES AT LEVEL 4, AND A ROOF DECK TOTALING 14,821 SF. THERE IS ALSO 1,515 SF OF COMMON USABLE OPEN SPACE ON THE ROOF LEVEL FOR THE RESIDENTIAL TENANTS.</div>		
CONSTRUCTION MANAGEMENT COMPASS SOLUTIONS			JASON SCHLUTT	JSCHLUTT@COMPASSSOLUTIONSINC.COM	408-718-9614						
ARCHITECT KORTH SUNSERI HAGEY ARCHITECTS 349 SUTTER ST SAN FRANCISCO, CA 94108			TED KORTH	TKORTH@KSHA.COM	415-954-1960 X 230	JORDAN BLUM	JBLUM@KSHA.COM	415-954-1960 X 234			
GEOTECHNICAL ENGINEER CORNERSTONE EARTH GROUP 1259 OAKMEAD PARKWAY SUNNYVALE, CA 94085			NICHOLAS DEVLIN	NDEVLIN@CORNERSTONEEARTH.COM	408-245-4600						
CIVIL ENGINEER KIER AND WRIGHT 3350 SCOTT BLVD, BLDG 22 SANTA CLARA, CA 95054			MARK KNUDSEN	MKNUDSEN@KIERWRIGHT.COM	408-727-6665						
LANDSCAPE ARCHITECT ANDREA COCHRAN LANDSCAPE ARCH 2325 THIRD STREET, #210 SAN FRANCISCO, CA 94107			EMILY RYLANDER	EMILY@ACOCHRAN.COM	415-503-0060						
TRASH MANAGEMENT CONSULTANT AMERICAN TRASH MANAGEMENT 1900 POWELL STREET, SUITE 220 EMERYVILLE, CA 94608			SCOTT BROWN	SBROWN@TRASHMANAGE.COM	415-292-5401						

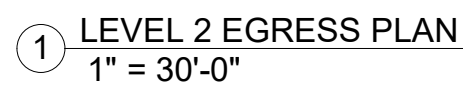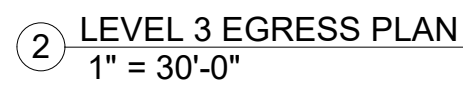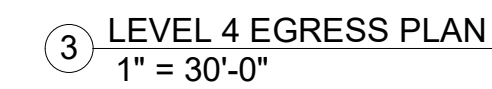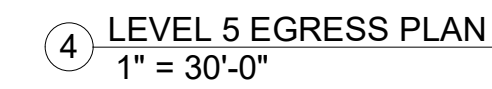

CBC TABLE 1004.5
MAXIMUM FLOOR AREA ALLOWANCES PER OCCUPANT

LEVEL 3			
A-3	6,030 SF	15	403
A-3*	5,778 SF	15	386
B	25,018 SF	150	170
S-2	291 SF	300	2
	37,117 SF		961

LEVEL 2			
A-3*	7,254 SF	15	484
B	33,318 SF	150	224
S-2	291 SF	300	2
	40,863 SF		710

*NOTE: THIS A-3 OCCUPANCY ALLOWANCE IS A PLACEHOLDER FOR CONFERENCE ROOMS, BREAK ROOMS, ETC THAT MAY BE PART OF A FUTURE TI. IT IS INCLUDED HERE TO ENSURE THAT ALL EGRESS COMPONENTS ARE SIZED APPROPRIATELY FOR THIS FUTURE USE. IT HAS NOT BEEN USED TO DETERMINE OCCUPANCY SEPARATIONS.



ISSUES AND REVISIONS

No.	Date	Description
A	04/22/22	Planning Resubmittal

PROJECT NUMBER
16010.00

SHEET TITLE
PLUMBING FIXTURE
CALCULATIONS

SCALE
1/16" = 1'-0"

SHEET NUMBER

A-004

PLUMBING FIXTURE SUMMARY

Plumbing Fixture Occupant Load				
Occupancy	Area	P Load Factor	P Occupant Load	P Occupant Load Per Sex
LEVEL 5				
A-3	3,367 SF	30	113	56.5
	3,367 SF		113	56.5
LEVEL 4				
A-3*	4,391 SF	30	147	73.5
B	382 SF	30	13	6.5
B	23,351 SF	200	117	58.5
	28,123 SF		277	138.5
LEVEL 3				
A-3	6,030 SF	30	202	101
A-3*	5,778 SF	30	193	96.5
B	22,621 SF	200	114	57
	34,429 SF		509	254.5
LEVEL 2				
A-3*	7,254 SF	30	242	121
B	31,017 SF	200	156	78
	38,271 SF		398	199
LEVEL 1				
B	1,751 SF	200	9	4.5
	1,751 SF		9	4.5

CPC TABLE 422.1 MINIMUM PUMBING FACILITIES

	Level 5 + 4	Level 3	Level 2	Level 1
A-3 Occupancy				
Occupant Load Per Sex	130.00	198.00	121.00	0.00
Water Closet (M)	1.30	1.98	1.21	0.00
Water Closet (F)	3.30	3.98	3.21	0.00
Urinal	1.30	1.98	1.21	0.00
Lavatory (M)	0.65	0.99	0.61	0.00
Lavatory (F)	1.30	1.98	1.21	0.00
Drinking Fountain	1.04	1.58	0.97	0.00
B Occupancy Terrace				
Occupant Load Per Sex	7.00	0.00	0.00	0.00
Water Closet (M)	0.07	0.00	0.00	0.00
Water Closet (F)	0.28	0.00	0.00	0.00
Urinal	0.07	0.00	0.00	0.00
Lavatory (M)	0.04	0.00	0.00	0.00
Lavatory (F)	0.07	0.00	0.00	0.00
Drinking Fountain	0.06	0.00	0.00	0.00
B Occupancy				
Occupant Load Per Sex	59.00	57.00	78.00	5.00
Water Closet (M)	1.18	1.14	1.56	0.10
Water Closet (F)	3.18	3.14	3.56	0.33
Urinal	0.59	0.57	0.78	0.05
Lavatory (M)	0.79	0.76	1.04	0.07
Lavatory (F)	1.18	1.14	1.56	0.10
Drinking Fountain	0.79	0.76	1.04	0.07
Total				
Water Closet (M)	3.00	4.00	3.00	1.00
Water Closet (F)	7.00	8.00	7.00	1.00
Urinal	2.00	3.00	2.00	1.00
Lavatory (M)	2.00	2.00	2.00	1.00
Lavatory (F)	3.00	4.00	3.00	1.00
Drinking Fountain	2.00	3.00	3.00	1.00

PLUMBING FIXTURES PROVIDED

LEVEL 1	
1 SINGLE OCCUPANCY RESTROOM*	
*PER CPC 422.2 EXCEPTION 2, ONE TOILET FACILITY FOR USE BY NO MORE THAN ONE PERSON AT A TIME SHALL BE PERMITTED FOR USE BY BOTH SEXES IN OCCUPANCIES WITH AN OCCUPANT LOAD OF 10 OR LESS.	
NOTE: RESTROOMS FOR M-OCCUPANCY ARE NOT PROVIDED IN BASE BUILDING AND WILL BE INCLUDED UNDER SEPERATE TI PERMIT.	
LEVEL 2	
WATER CLOSETS (M):	4 FIXTURES
WATER CLOSETS (F):	8 FIXTURES
URINALS:	4 FIXTURES
LAVATORIES (M):	4 FIXTURES
LAVATORIES (F):	4 FIXTURES
DRINKING FOUNTAINS:	3 FIXTURES
LEVEL 3	
WATER CLOSETS (M):	4 FIXTURES
WATER CLOSETS (F):	8 FIXTURES
URINALS:	4 FIXTURES
LAVATORIES (M):	4 FIXTURES
LAVATORIES (F):	4 FIXTURES
DRINKING FOUNTAINS:	3 FIXTURES
LEVEL 4	
WATER CLOSETS (M):	4 FIXTURES
WATER CLOSETS (F):	8 FIXTURES
URINALS:	4 FIXTURES
LAVATORIES (M):	4 FIXTURES
LAVATORIES (F):	4 FIXTURES
DRINKING FOUNTAINS:	3 FIXTURES
LEVEL 5	
WATER CLOSETS (M):	NONE
WATER CLOSETS (F):	NONE
URINALS:	NONE
LAVATORIES (M):	NONE
LAVATORIES (F):	NONE
DRINKING FOUNTAINS:	NONE
*PER CBC 2902.3.3, THE REQUIRED TOILET FACILITIES SHALL BE LOCATED NOT MORE THAN ONE STORY ABOVE OR BELOW THE SPACE REQUIRED TO BE PROVIDED WITH TOILET FACILITIES. THE TOILET FACILITIES FOR THE OFFICE ROOF DECK ARE PROVIDED ON LEVEL 4, AND THE CALCULATIONS FOR THE REQUIRED NUMBER OF FIXTURES ON LEVEL 4 INCLUDE THE COMBINED OCCUPANT LOADS OF LEVELS 4 AND 5.	

			<div></div> <div>② STALL CLEARANCES - COMPACT 1/8" = 1'-0"</div>
			<div></div> <div>① STALL CLEARANCES - STANDARD 1/8" = 1'-0"</div>

ISSUES AND REVISIONS

No.	Date	Description
A	03/19/21	Pre-App Resubmittal

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SHEET TITLE

PARKING DETAILS

SCALE

1/8" = 1'-0"

SHEET NUMBER



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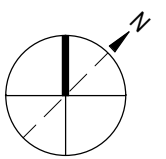
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PROJECT NUMBER
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SHEET TITLE
SITE PLAN

SCALE
1/16" = 1'-0"



SHEET NUMBER

A-101

GENERAL NOTES


- ACCESSIBLE PATHS OF TRAVEL:
 - ARE CONTINUOUSLY ACCESSIBLE
 - HAVE MAX. 1/2" CHANGES IN ELEVATION WITH A 1/2 BEVEL OR A RAMP PER CBC 11B-405
 - 48" MIN. WIDE
 - HAVE A MAX. RUNNING SLOPE OF 1:20 (5%) AND A MAX. CROSS SLOPE OF 1:50 (2%) PER CBC 403.3
 - SHALL COINCIDE WITH OR BE LOCATED IN THE SAME AREA AS GENERAL CIRCULATION PATHS. WHERE CIRCULATION PATHS ARE INTERIOR, REQUIRED ACCESSIBLE ROUTES SHALL ALSO BE INTERIOR.
- PER CBC 11B-502.4 MAX. PERMITTED SLOPE OF ACCESSIBLE PARKING SPACE AND ACCESS AISLES IS 2% IN ANY DIRECTION

LEGEND

- ACCESSIBLE PATH OF TRAVEL
- APPROXIMATE EXTENT OF LIMITED PARKING ZONE

SHEET NOTES

Key Value	Keynote Text
1	THE PROJECT PROPOSES A LOT TIE AGREEMENT BETWEEN THE PROPERTY OWNERS OF THE FOUR LOTS THAT MAKE UP THE PROJECT SITE. THEREFORE, THE INTERIOR LOT LINES SHALL NOT BE USED TO DETERMINE THE FIRE SEPARATION REQUIREMENTS OF THE CALIFORNIA BUILDING CODE.
2	EXTENT OF CANOPY (ABOVE)
3	EXTENT OF FLOOR (ABOVE)
4	AUDIO/VISUAL PEDESTRIAN WARNING SIGN MOUNTED TO FACE OF BUILDING COLUMN, CALIBRATED TO NOT DISTURB RESIDENTIAL TENANTS ACROSS 5TH AVENUE.
5	BIKE RACK, S.L.D.

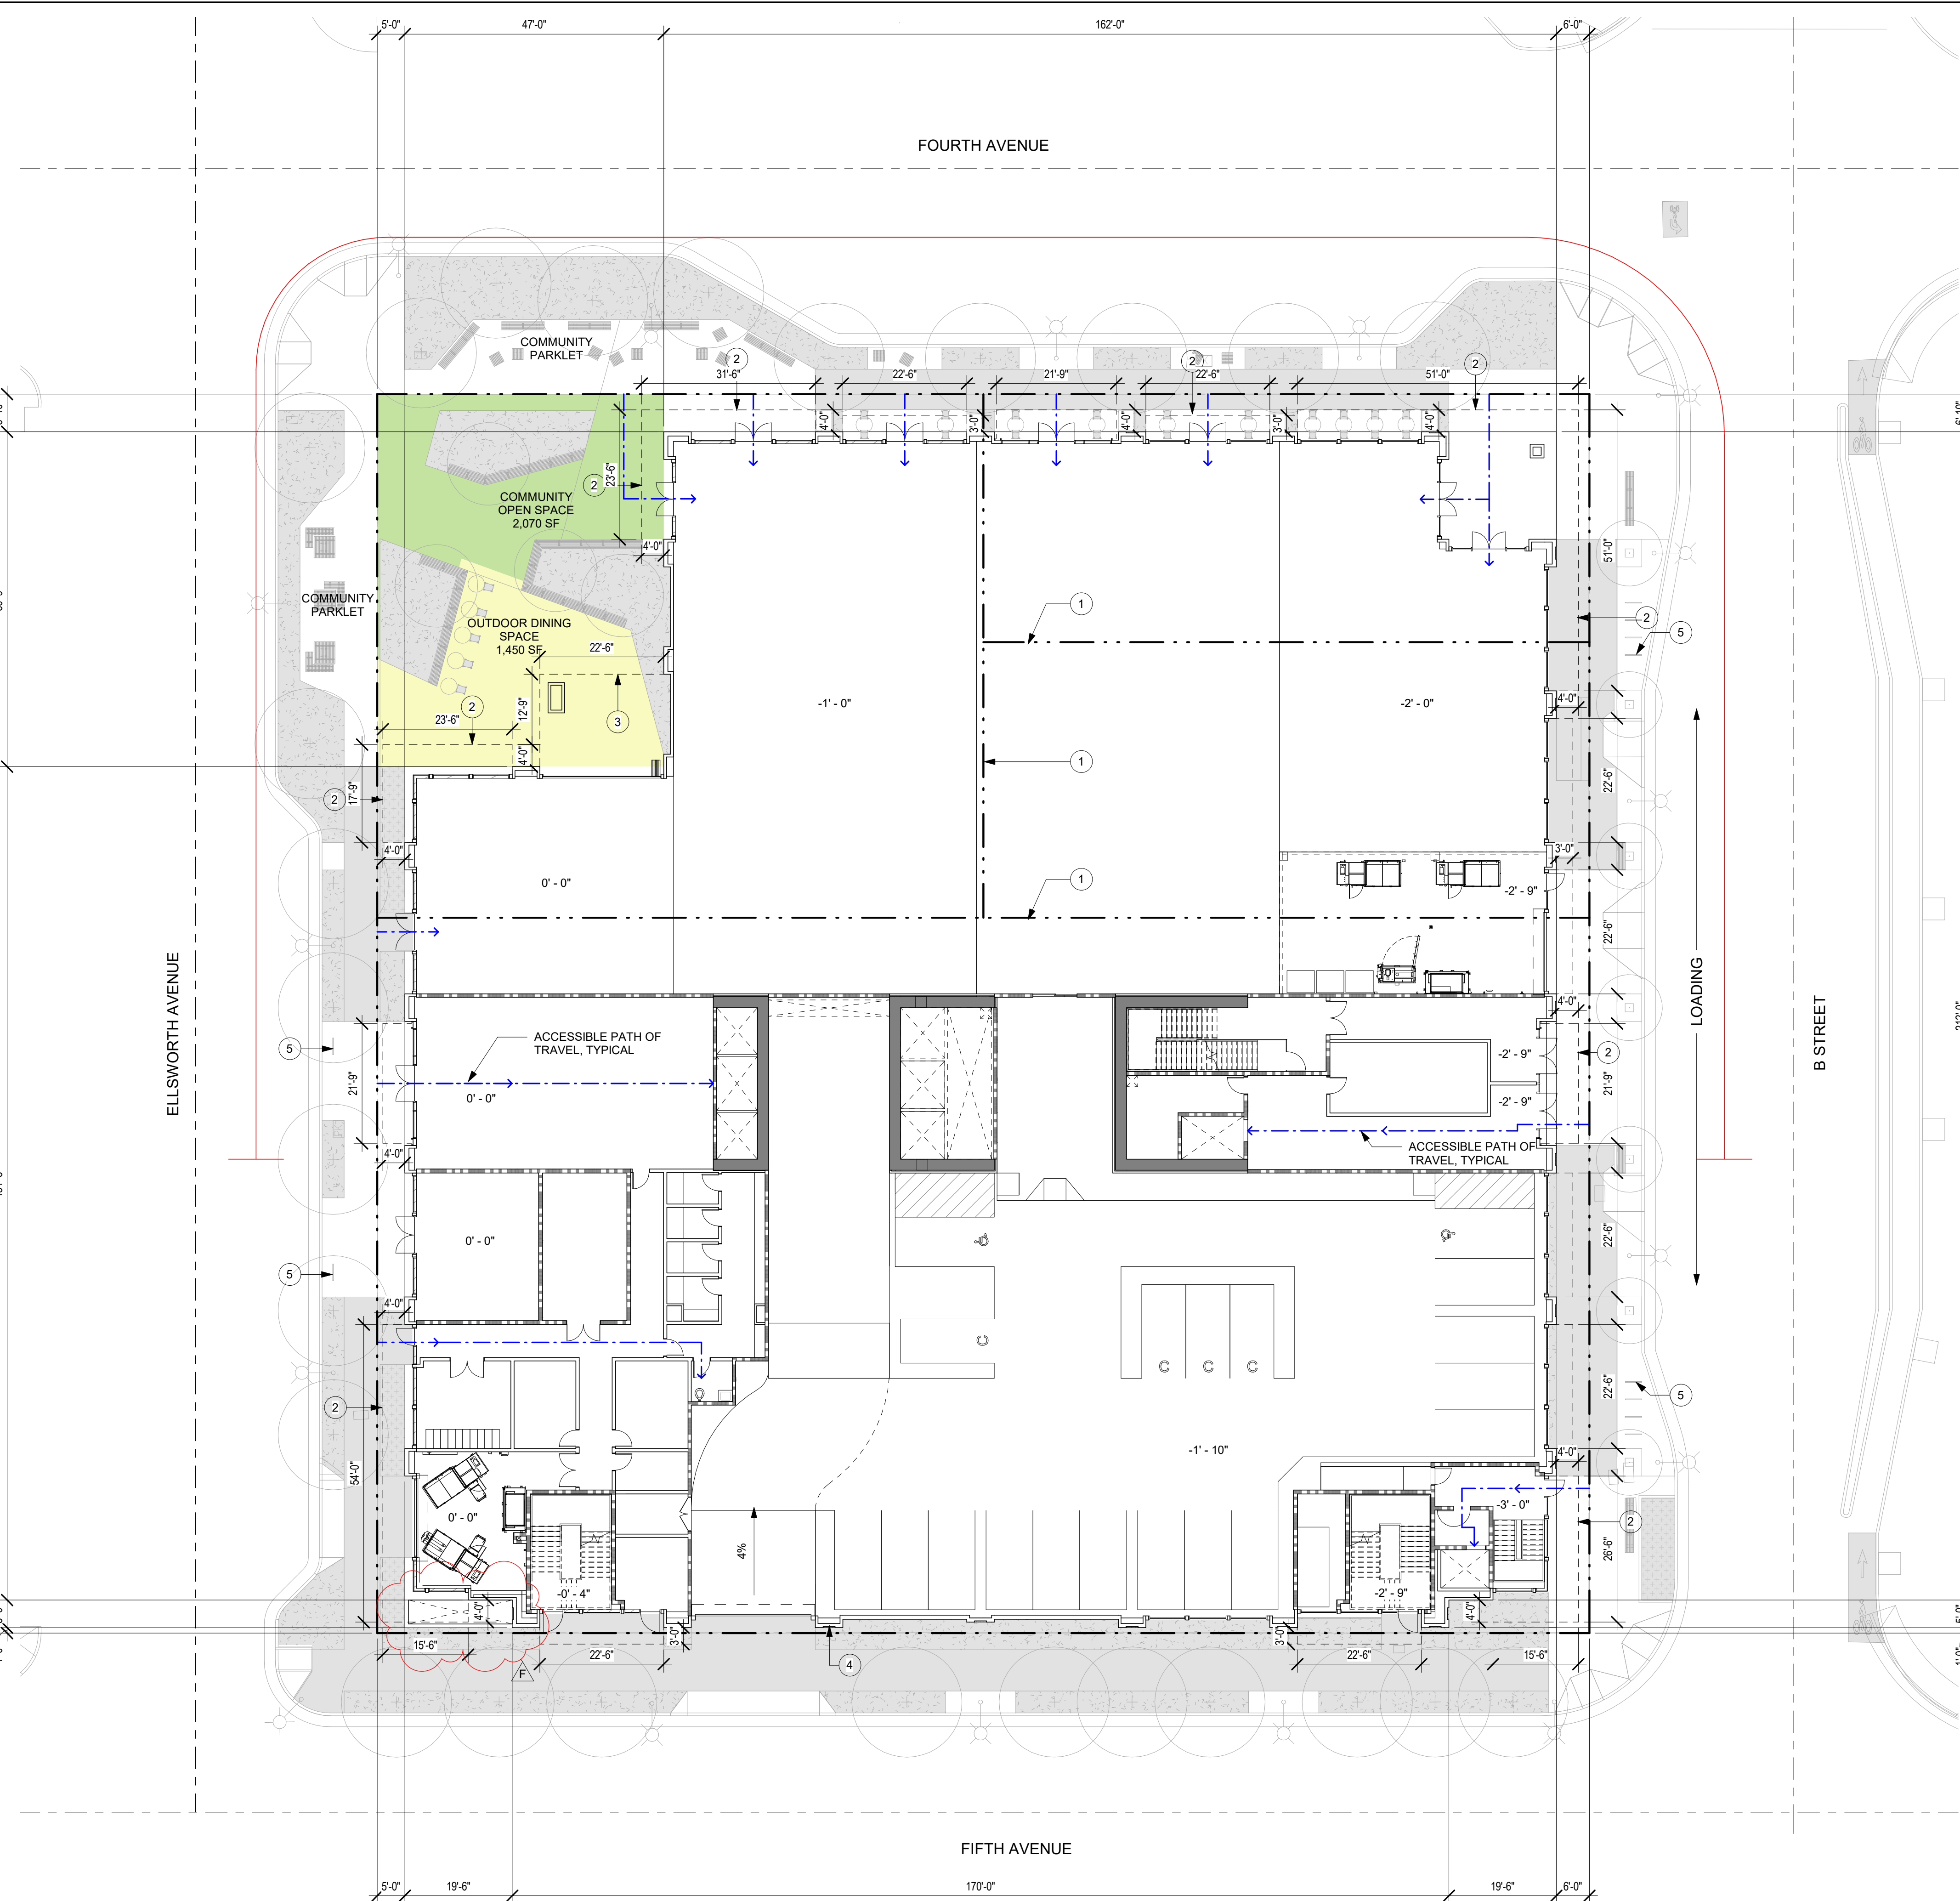

1 LEVEL 1 SITE PLAN
1/16" = 1'-0"



5



4




3



2



6

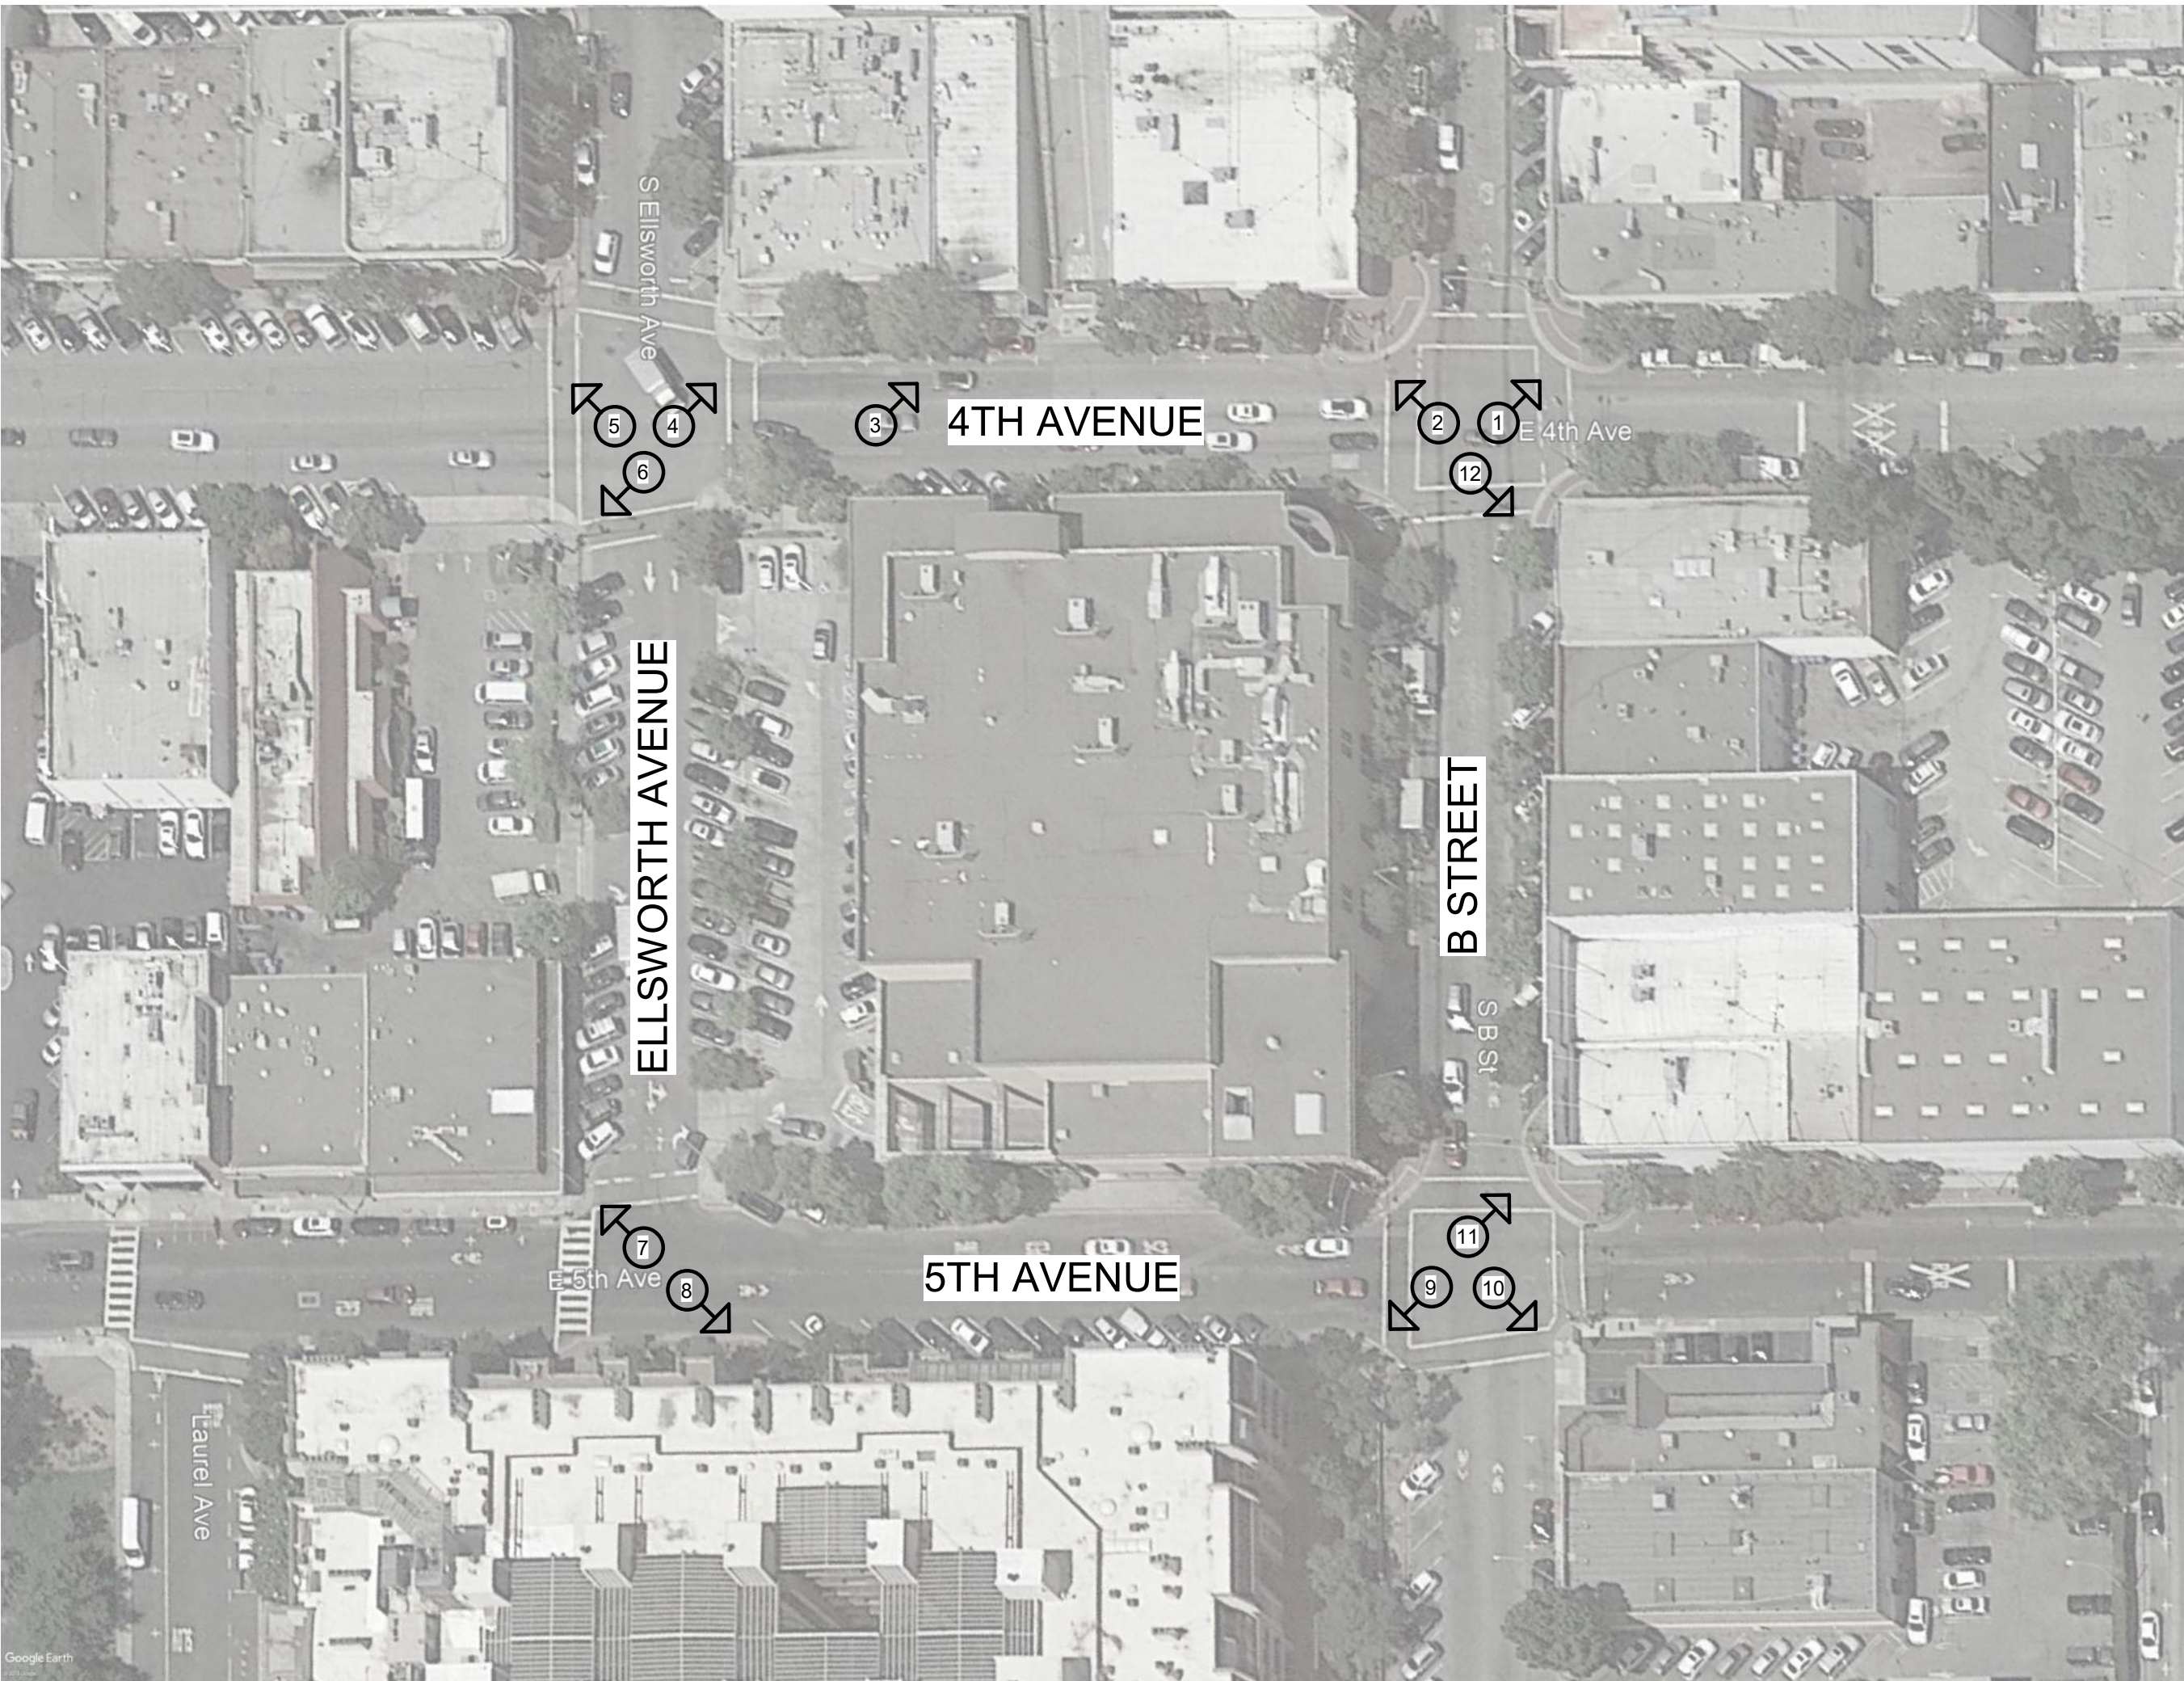

7



1



12



8



9



10



11

222 EAST 4TH LANE PARTNERS

LANE PARTNERS

KSH
ARCHITECTS
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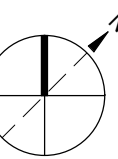
ISSUES AND REVISIONS

No.	Date	Description
A	05/05/20	Pre-Application Set

PROJECT NUMBER
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SHEET TITLE
CONTEXT IMAGES

SCALE



SHEET NUMBER

A-102



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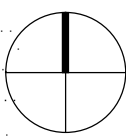
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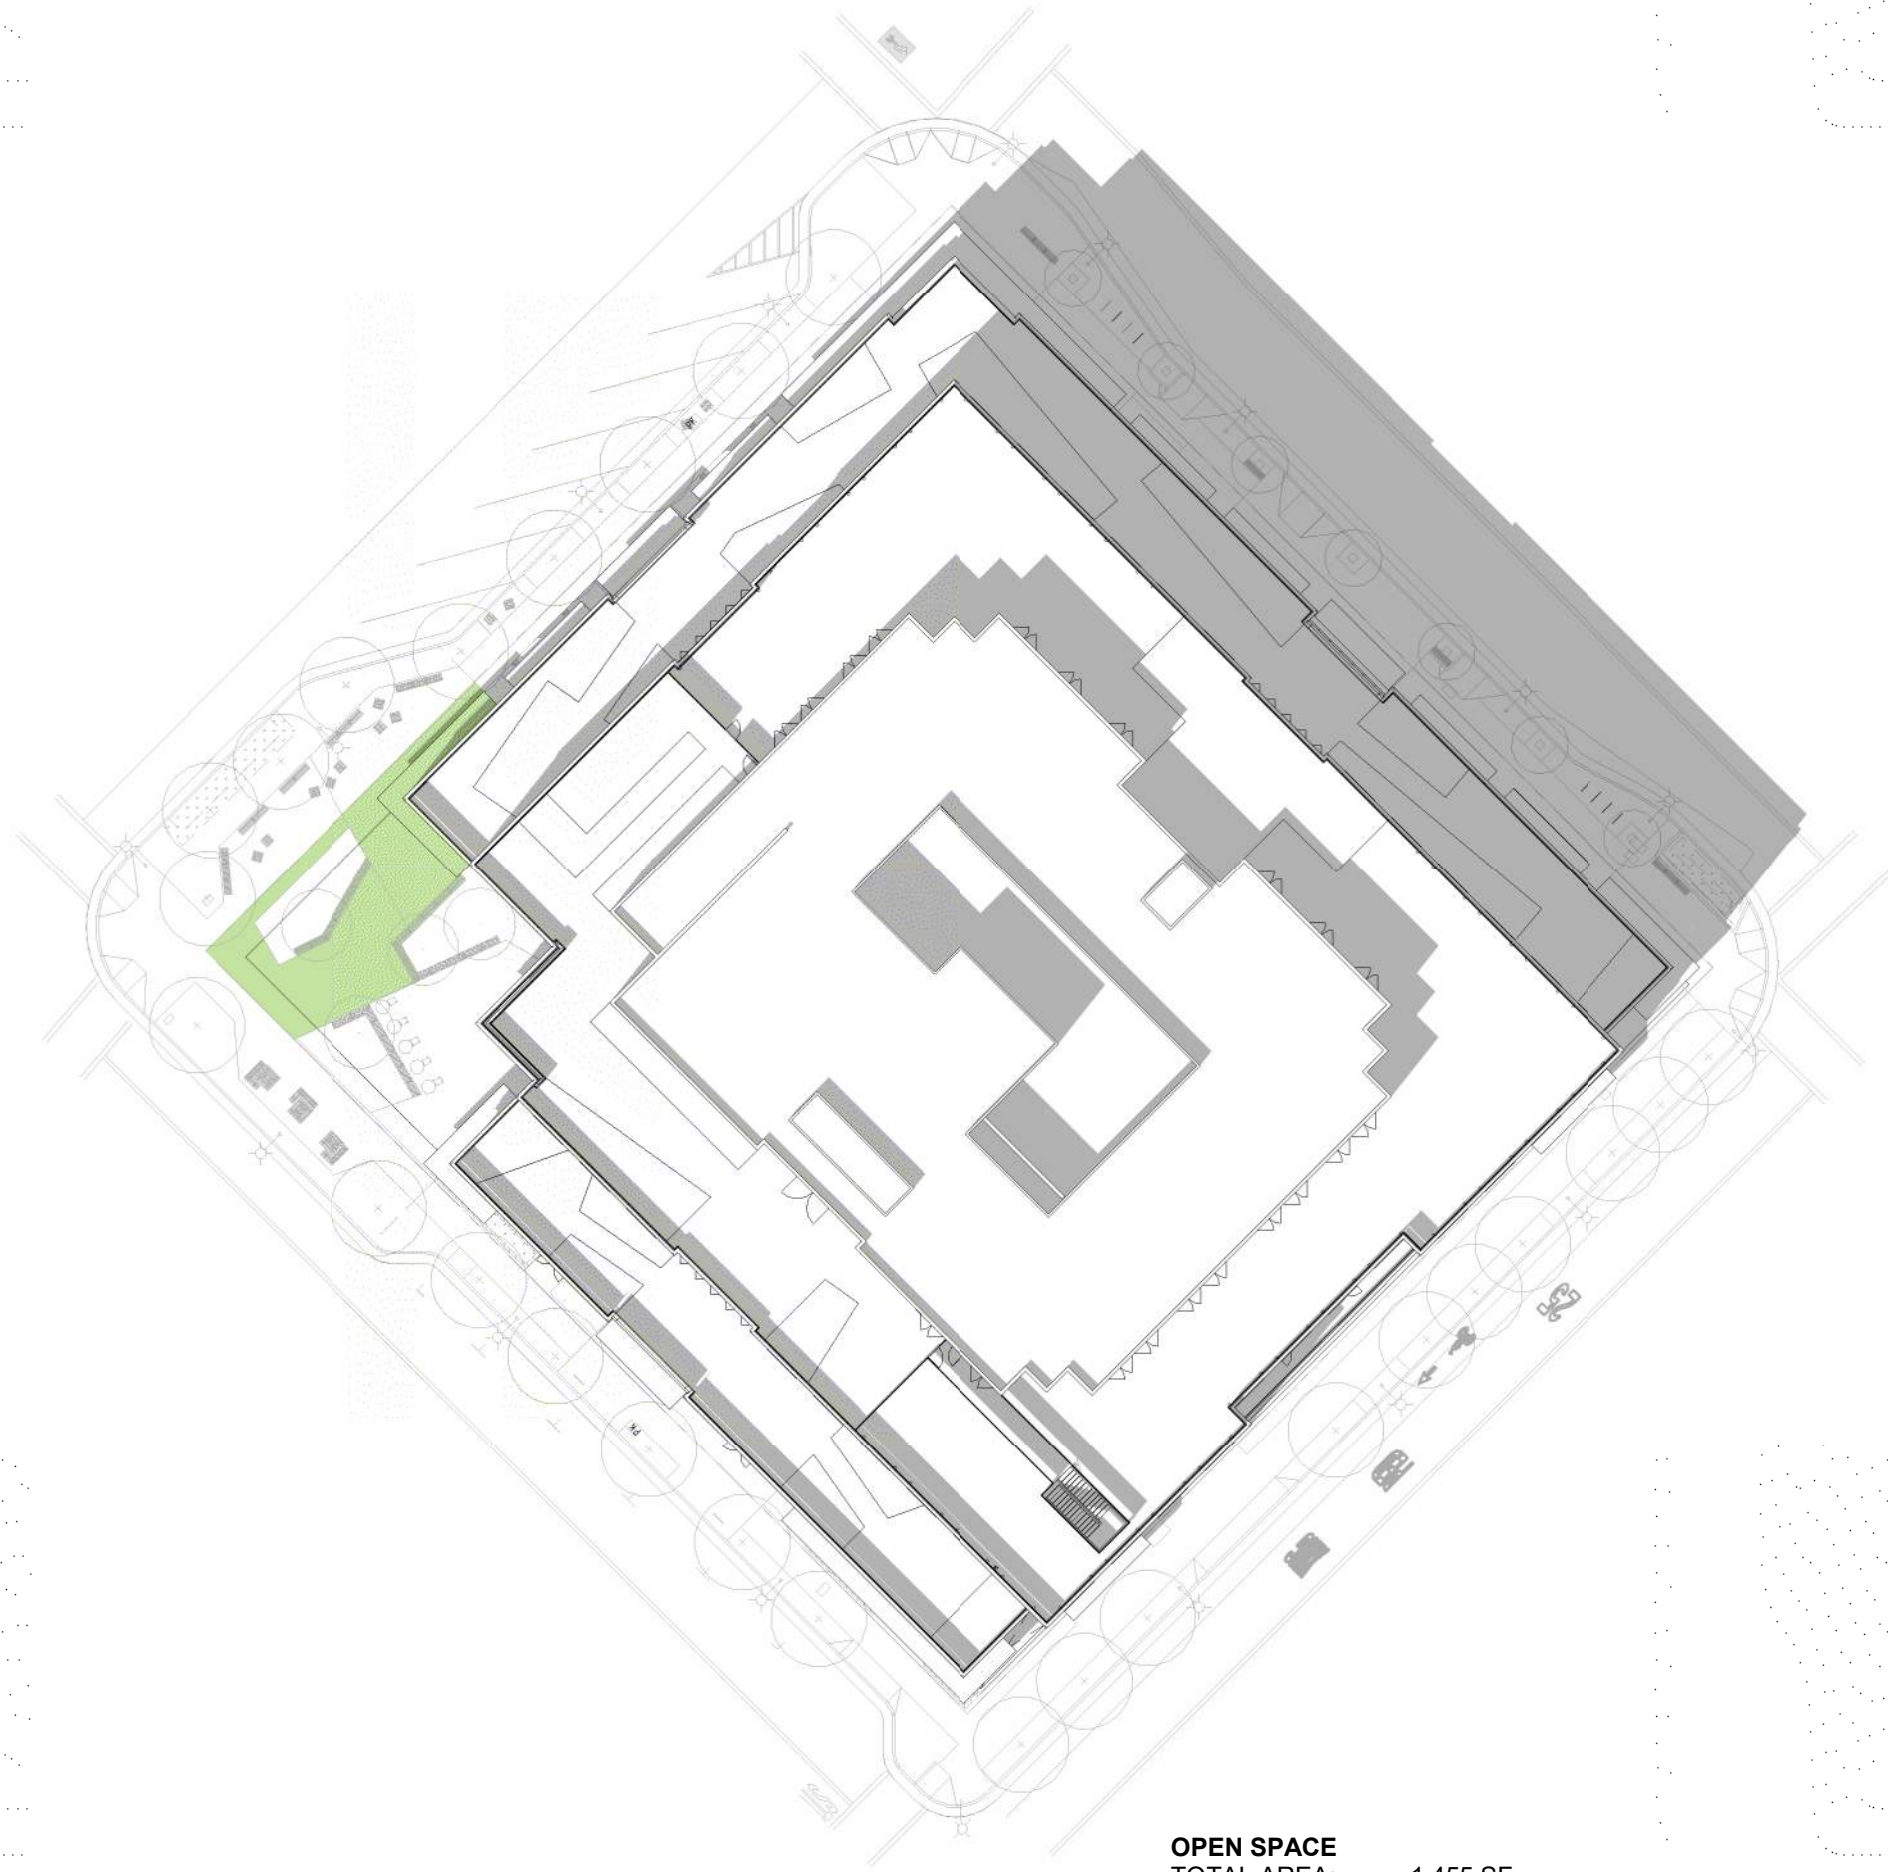
SHEET TITLE
SHADOW STUDIES

SCALE
1" = 40'-0"




SHEET NUMBER

A-103




OPEN SPACE
TOTAL AREA: 1,455 SF
UNSHADED AREA: 1,455 SF
UNSHADED %: 100%

④ Spring, 2PM
1" = 40'-0"

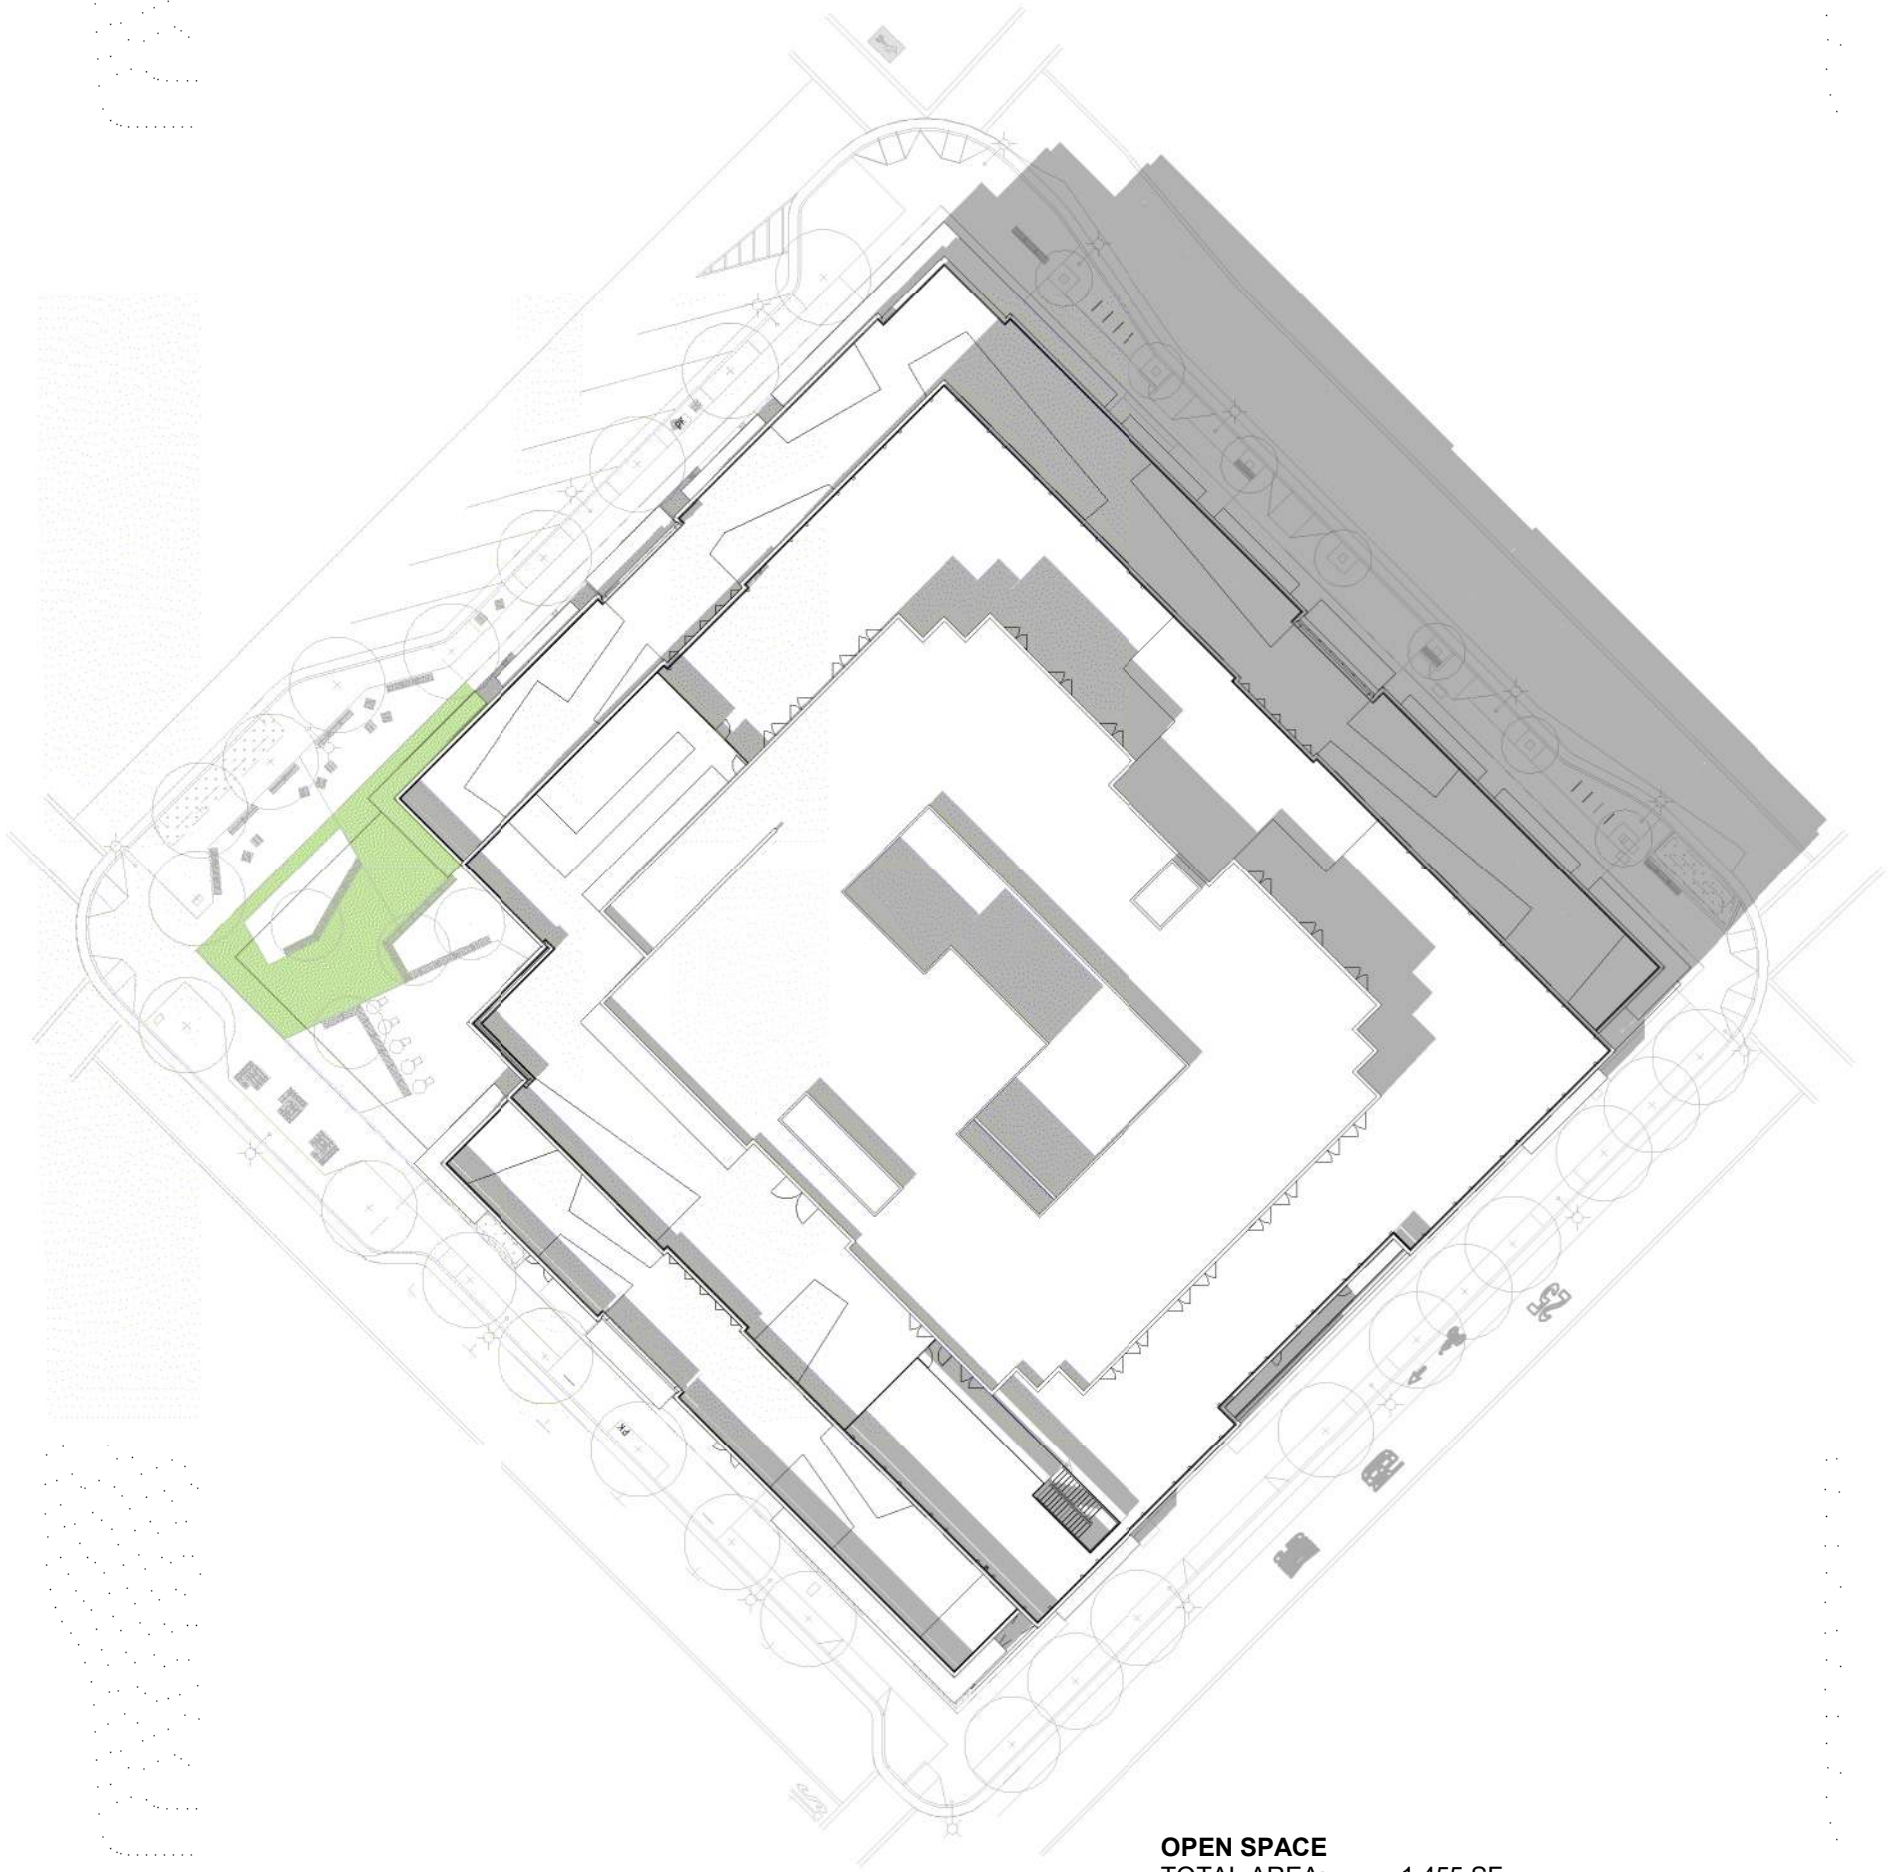


OPEN SPACE
TOTAL AREA: 1,455 SF
UNSHADED AREA: 1,455 SF
UNSHADED %: 100%

② Fall, 2PM
1" = 40'-0"

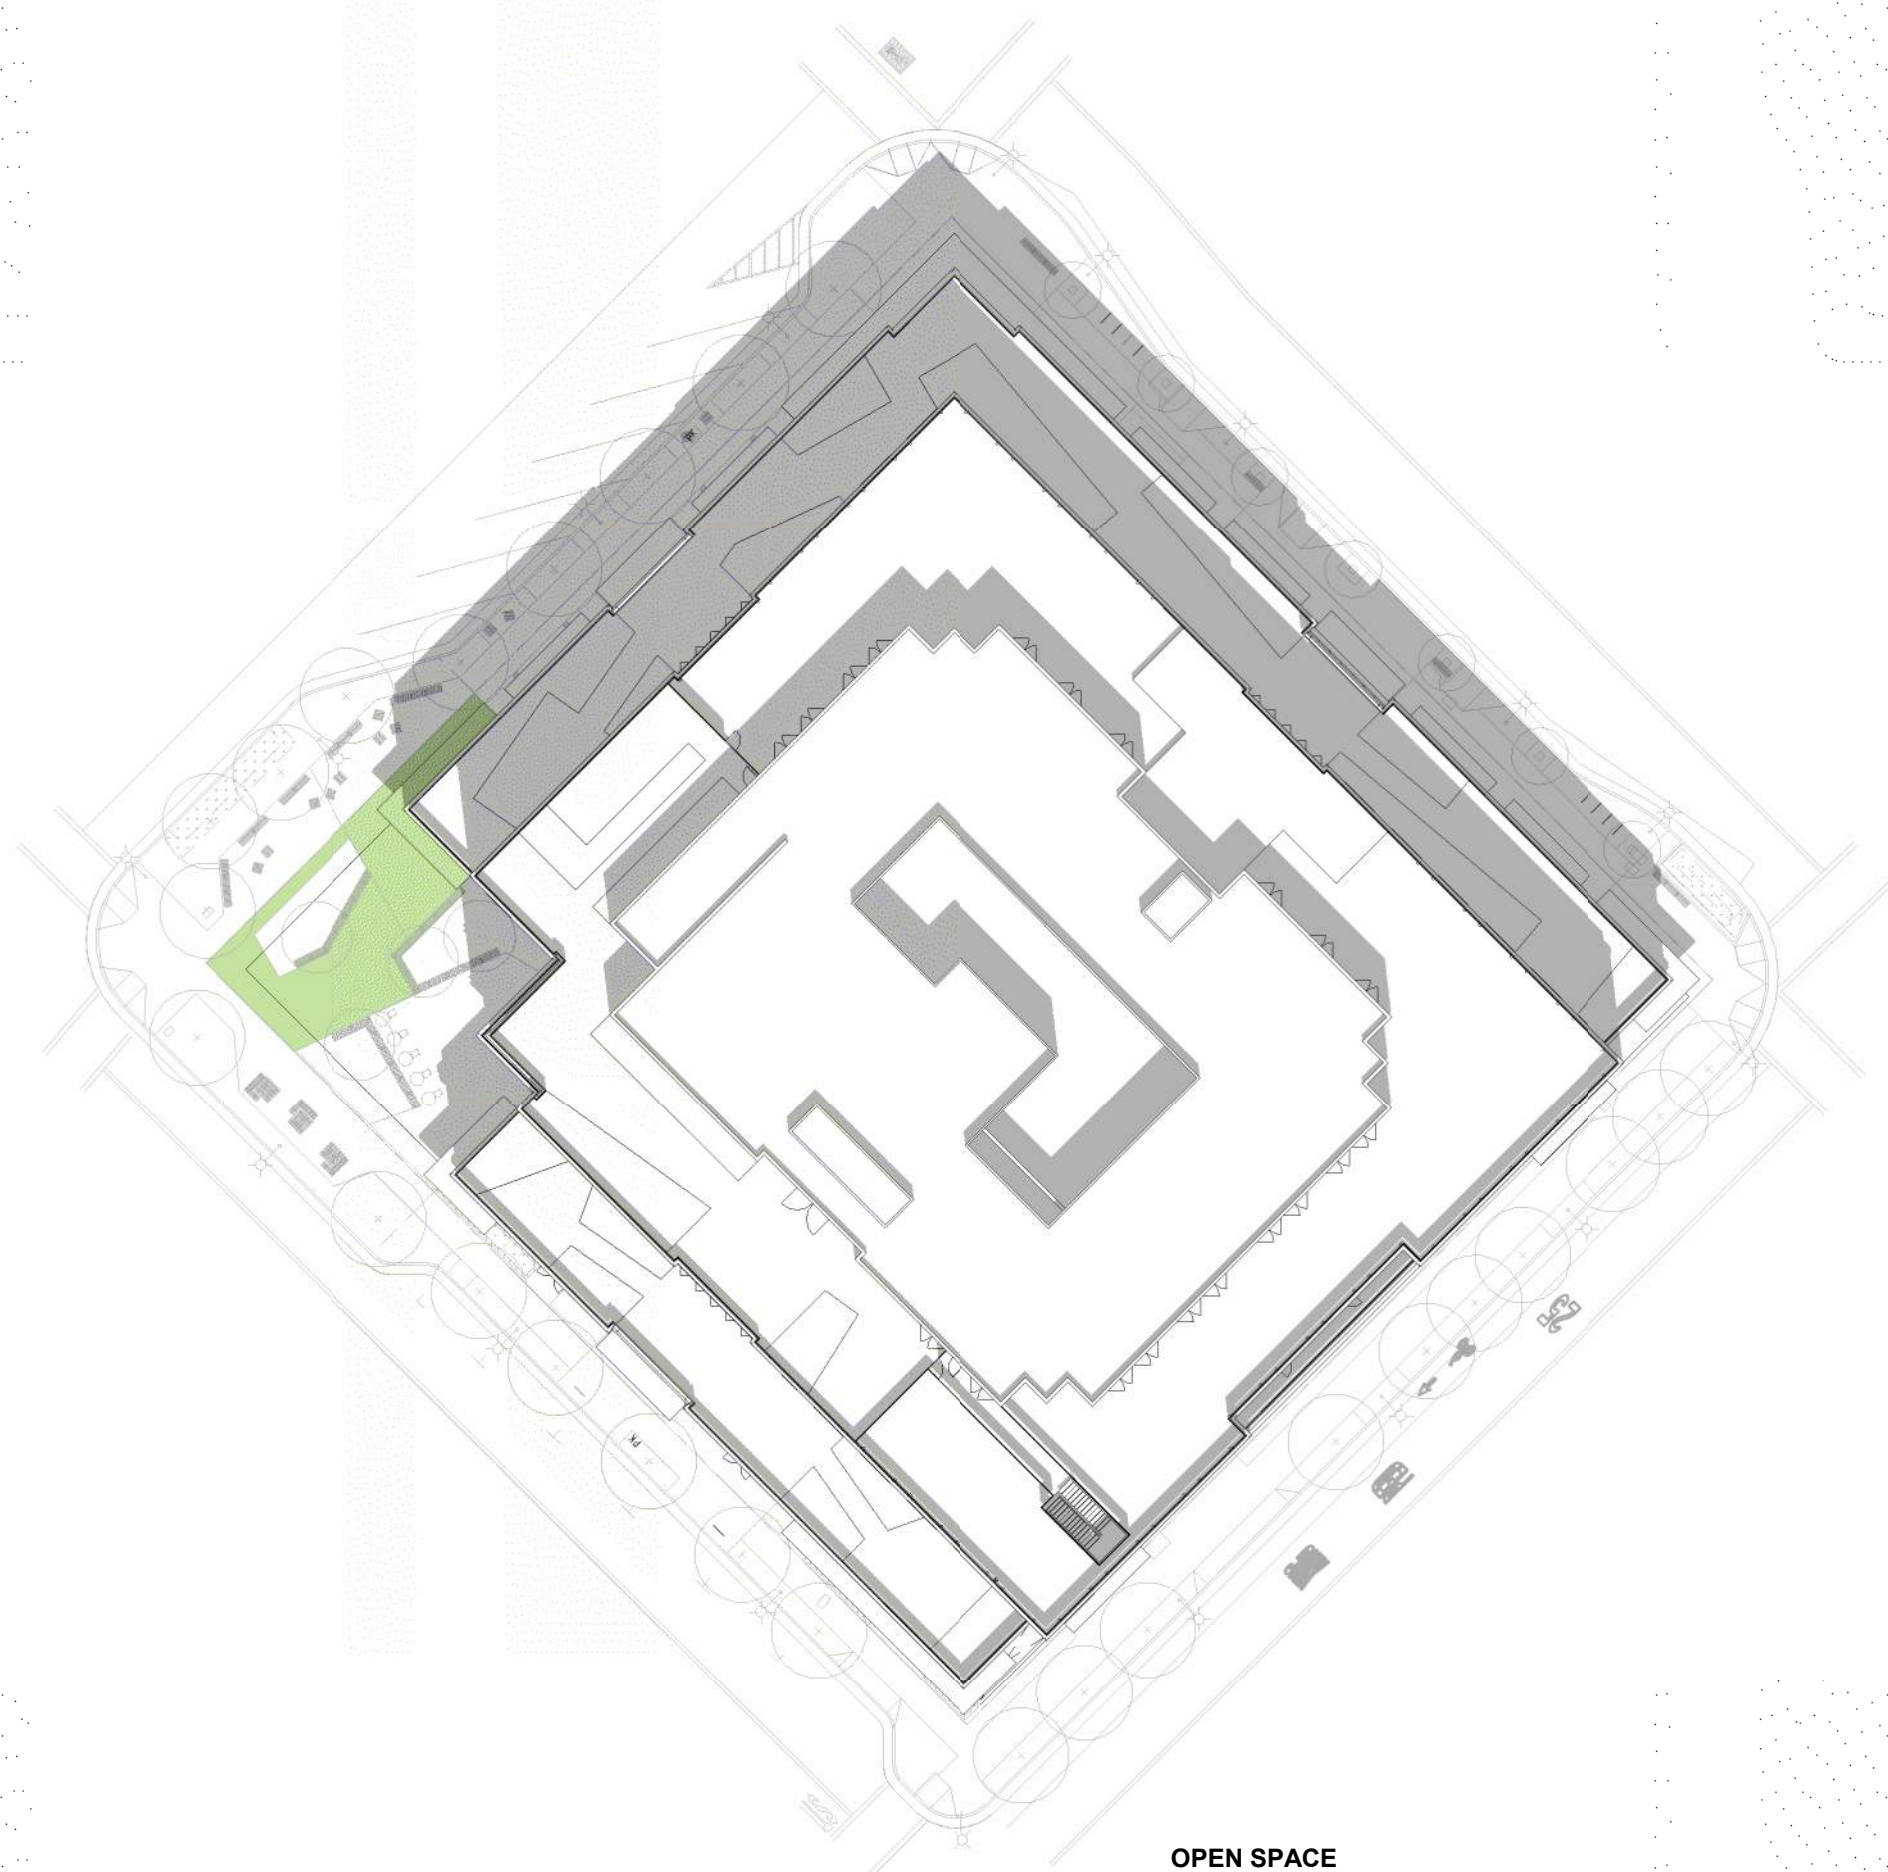

OPEN SPACE
TOTAL AREA: 1,455 SF
UNSHADED AREA: 1,280 SF
UNSHADED %: 88%

③ Spring, 12PM
1" = 40'-0"

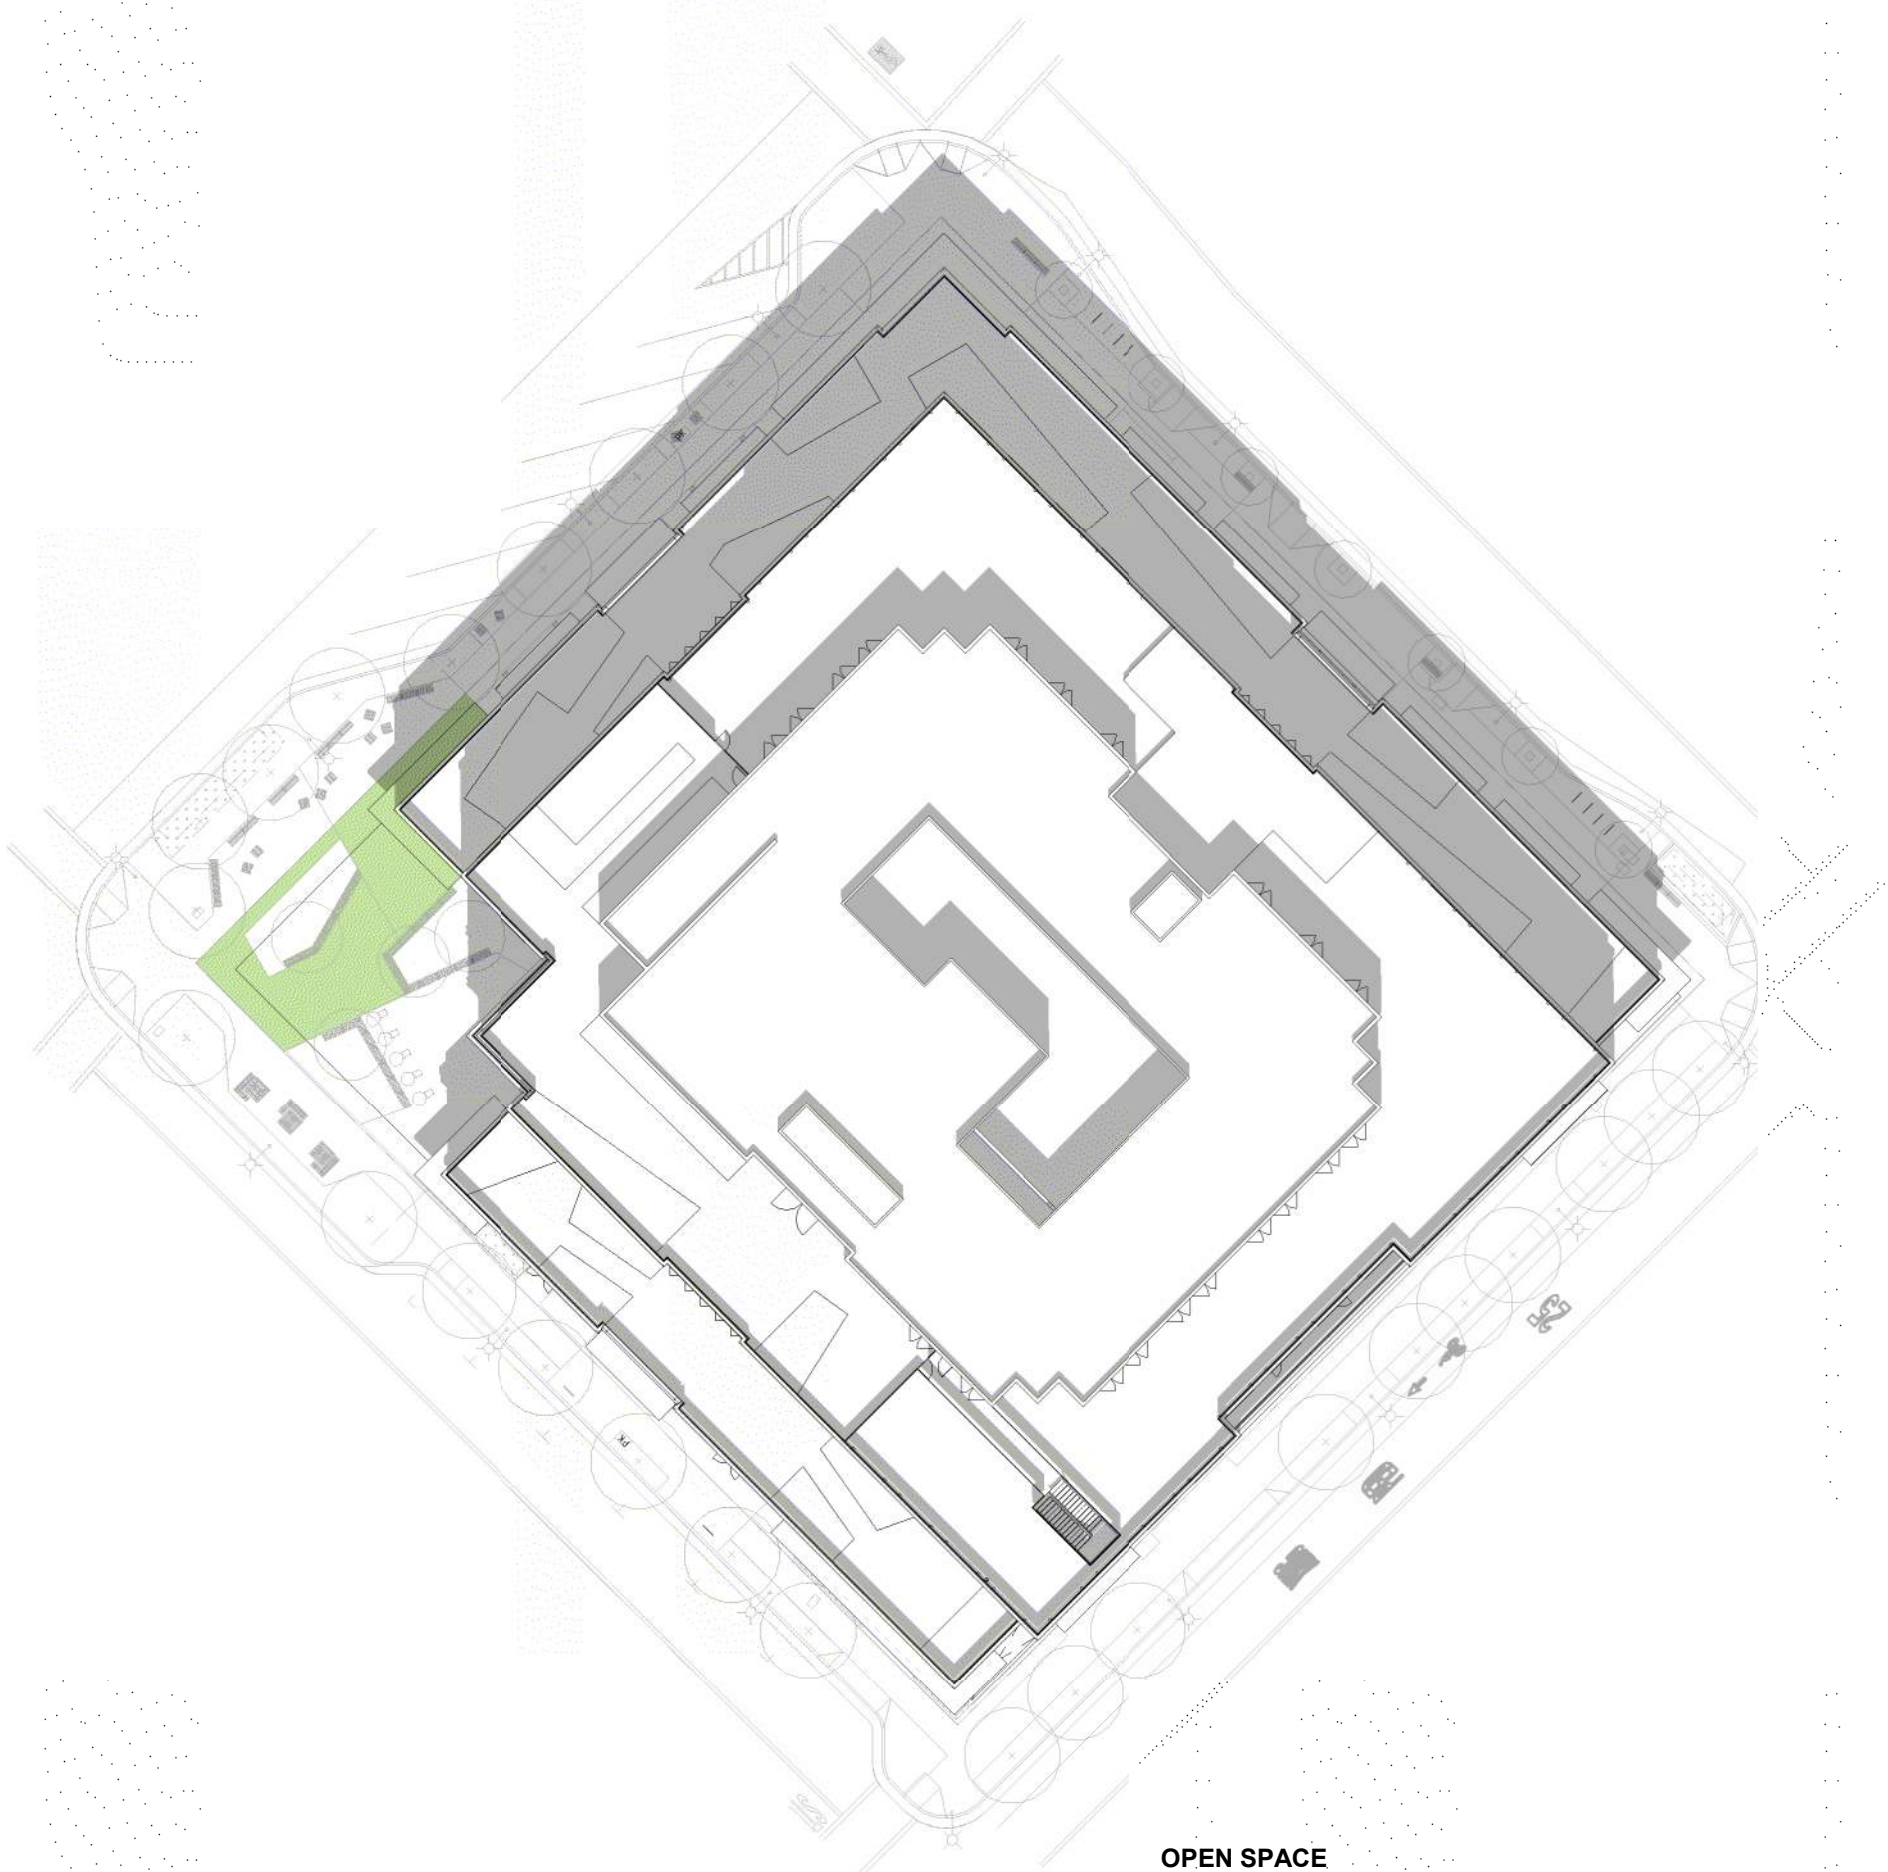

OPEN SPACE
TOTAL AREA: 1,455 SF
UNSHADED AREA: 1,290 SF
UNSHADED %: 89%


① Fall, 12PM
1" = 40'-0"

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G	06/15/22	Planning Resubmittal

PROJECT NUMBER
16010.00

SHEET TITLE
LEVEL 1 FLOOR PLAN

SCALE
3/32" = 1'-0"

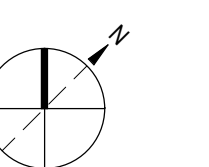

ET NUMBER

A-201





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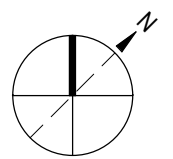
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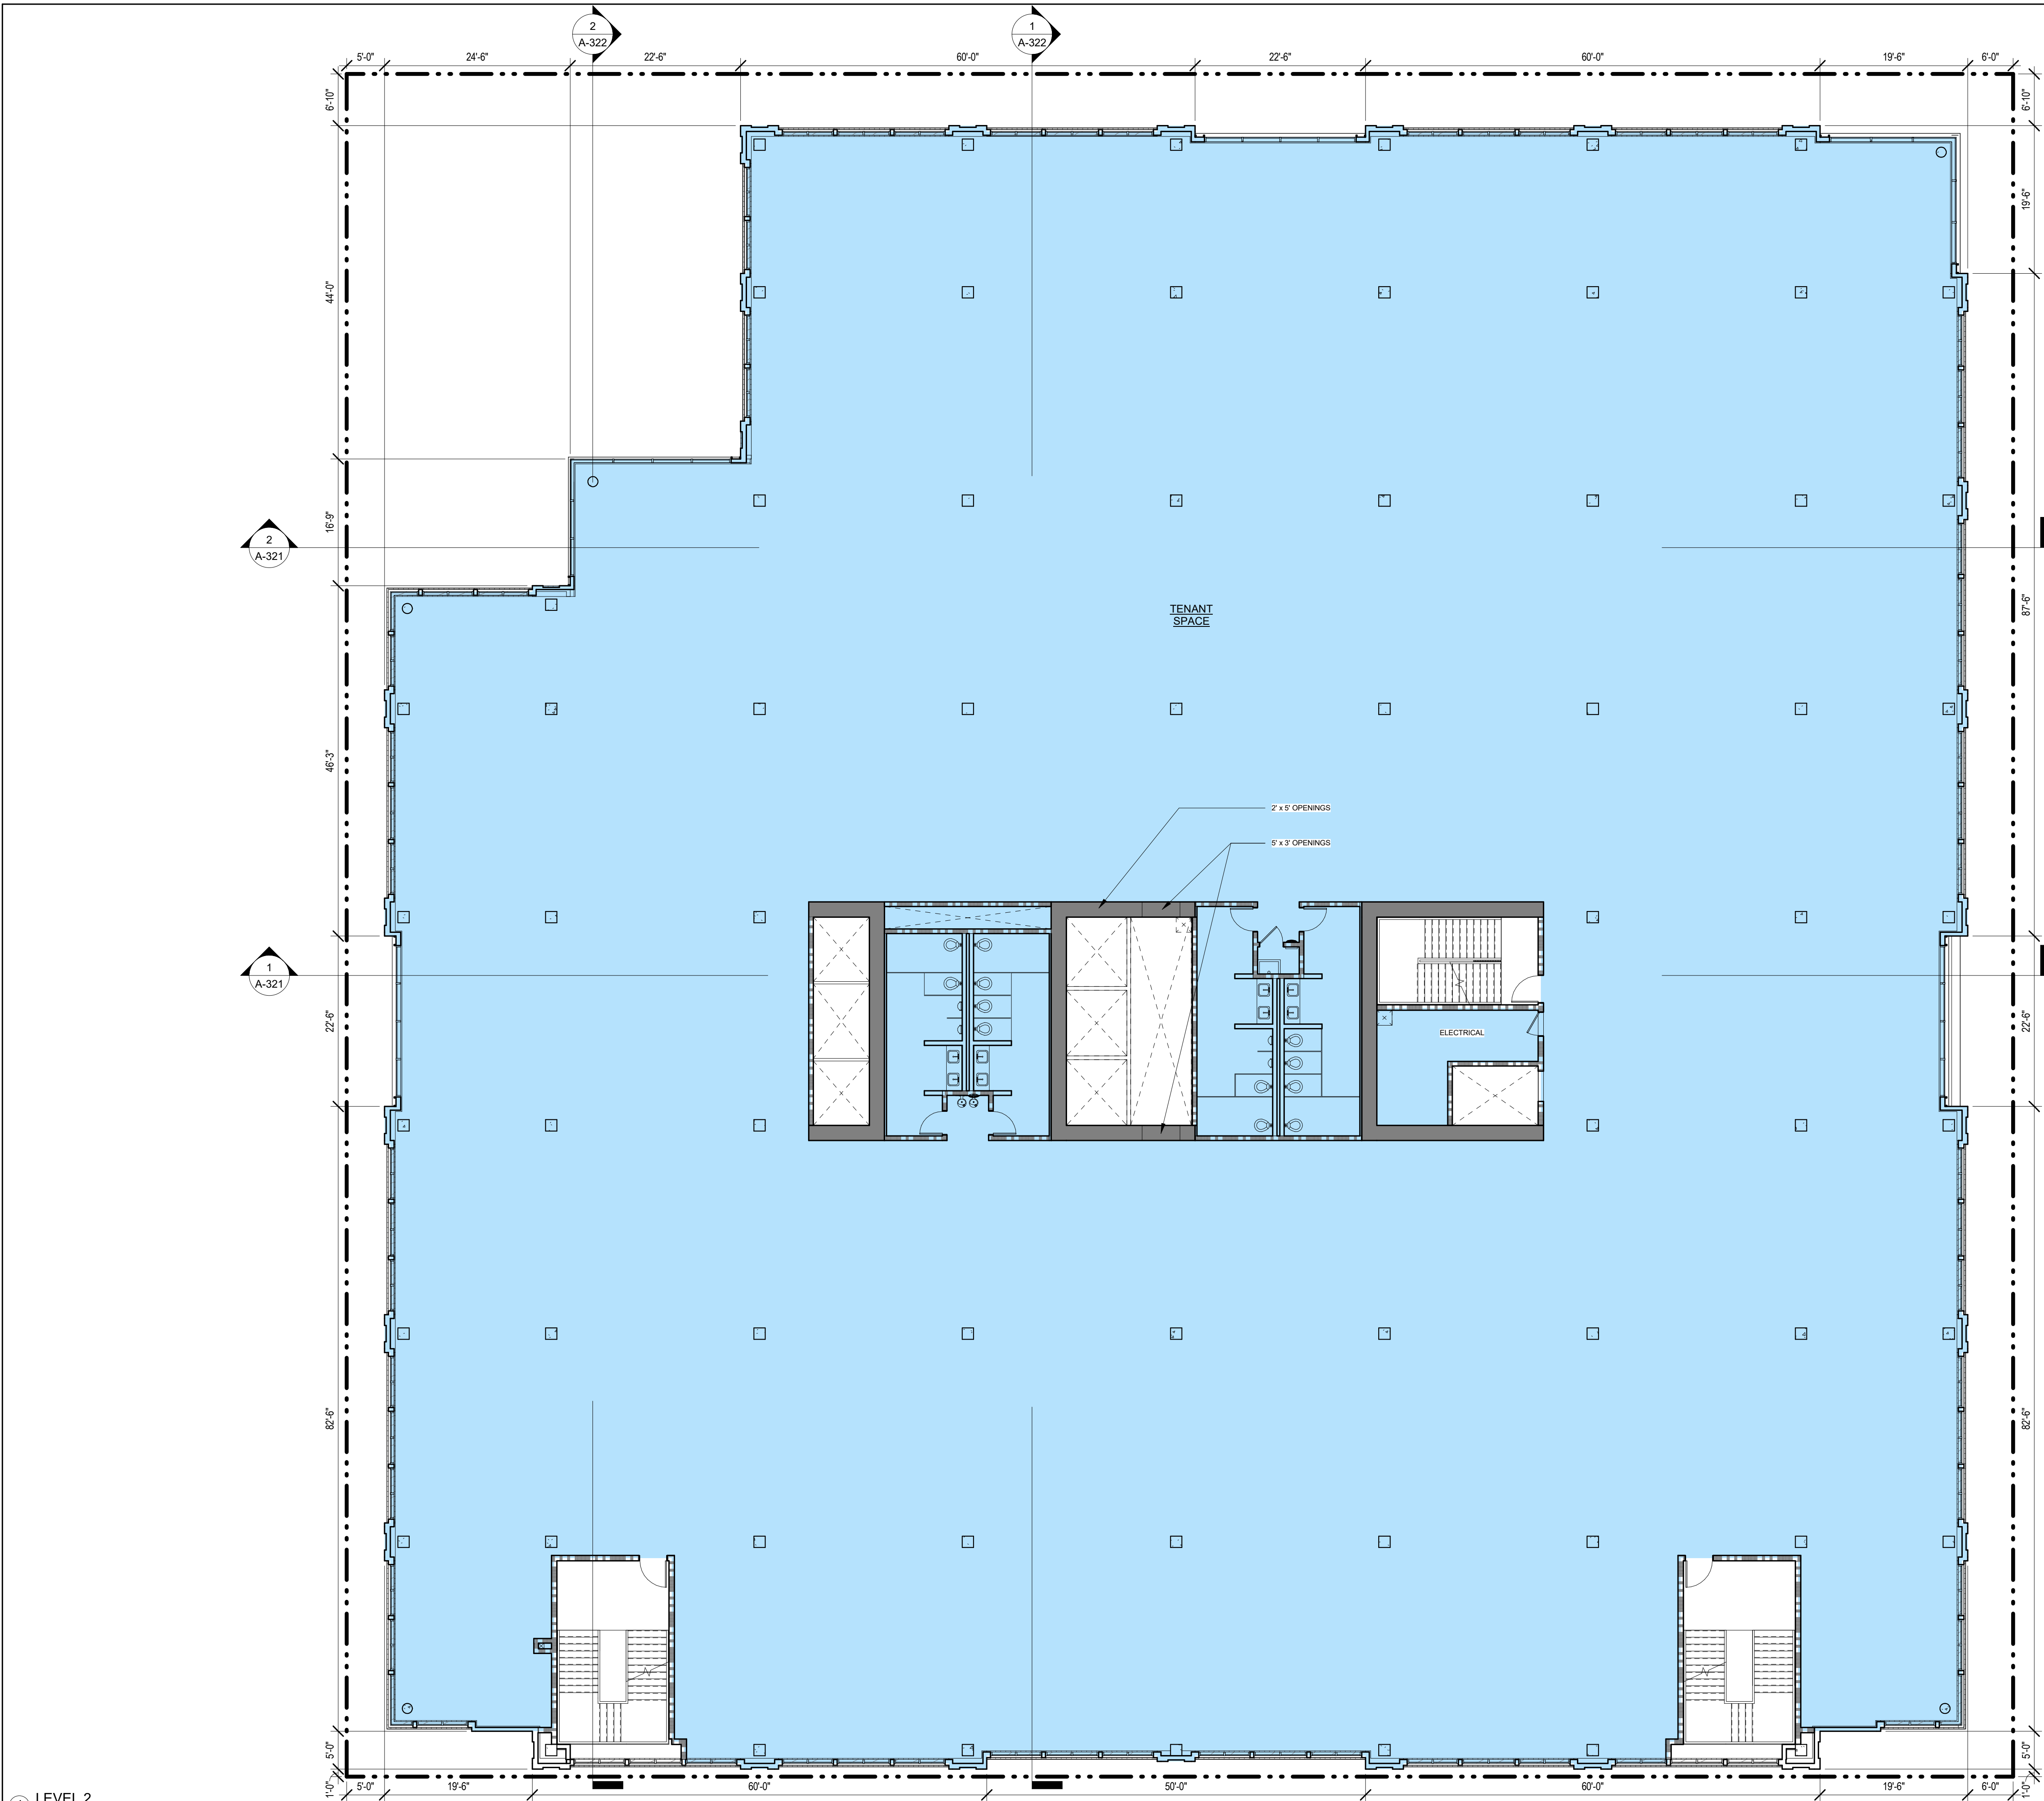
SHEET TITLE
LEVEL 2 FLOOR PLAN

SCALE
3/32" = 1'-0"



SHEET NUMBER

A-202



1 LEVEL 2
3/32" = 1'-0"

OFFICE
* NOT INCLUDED IN GROSS FLOOR AREA



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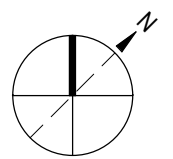
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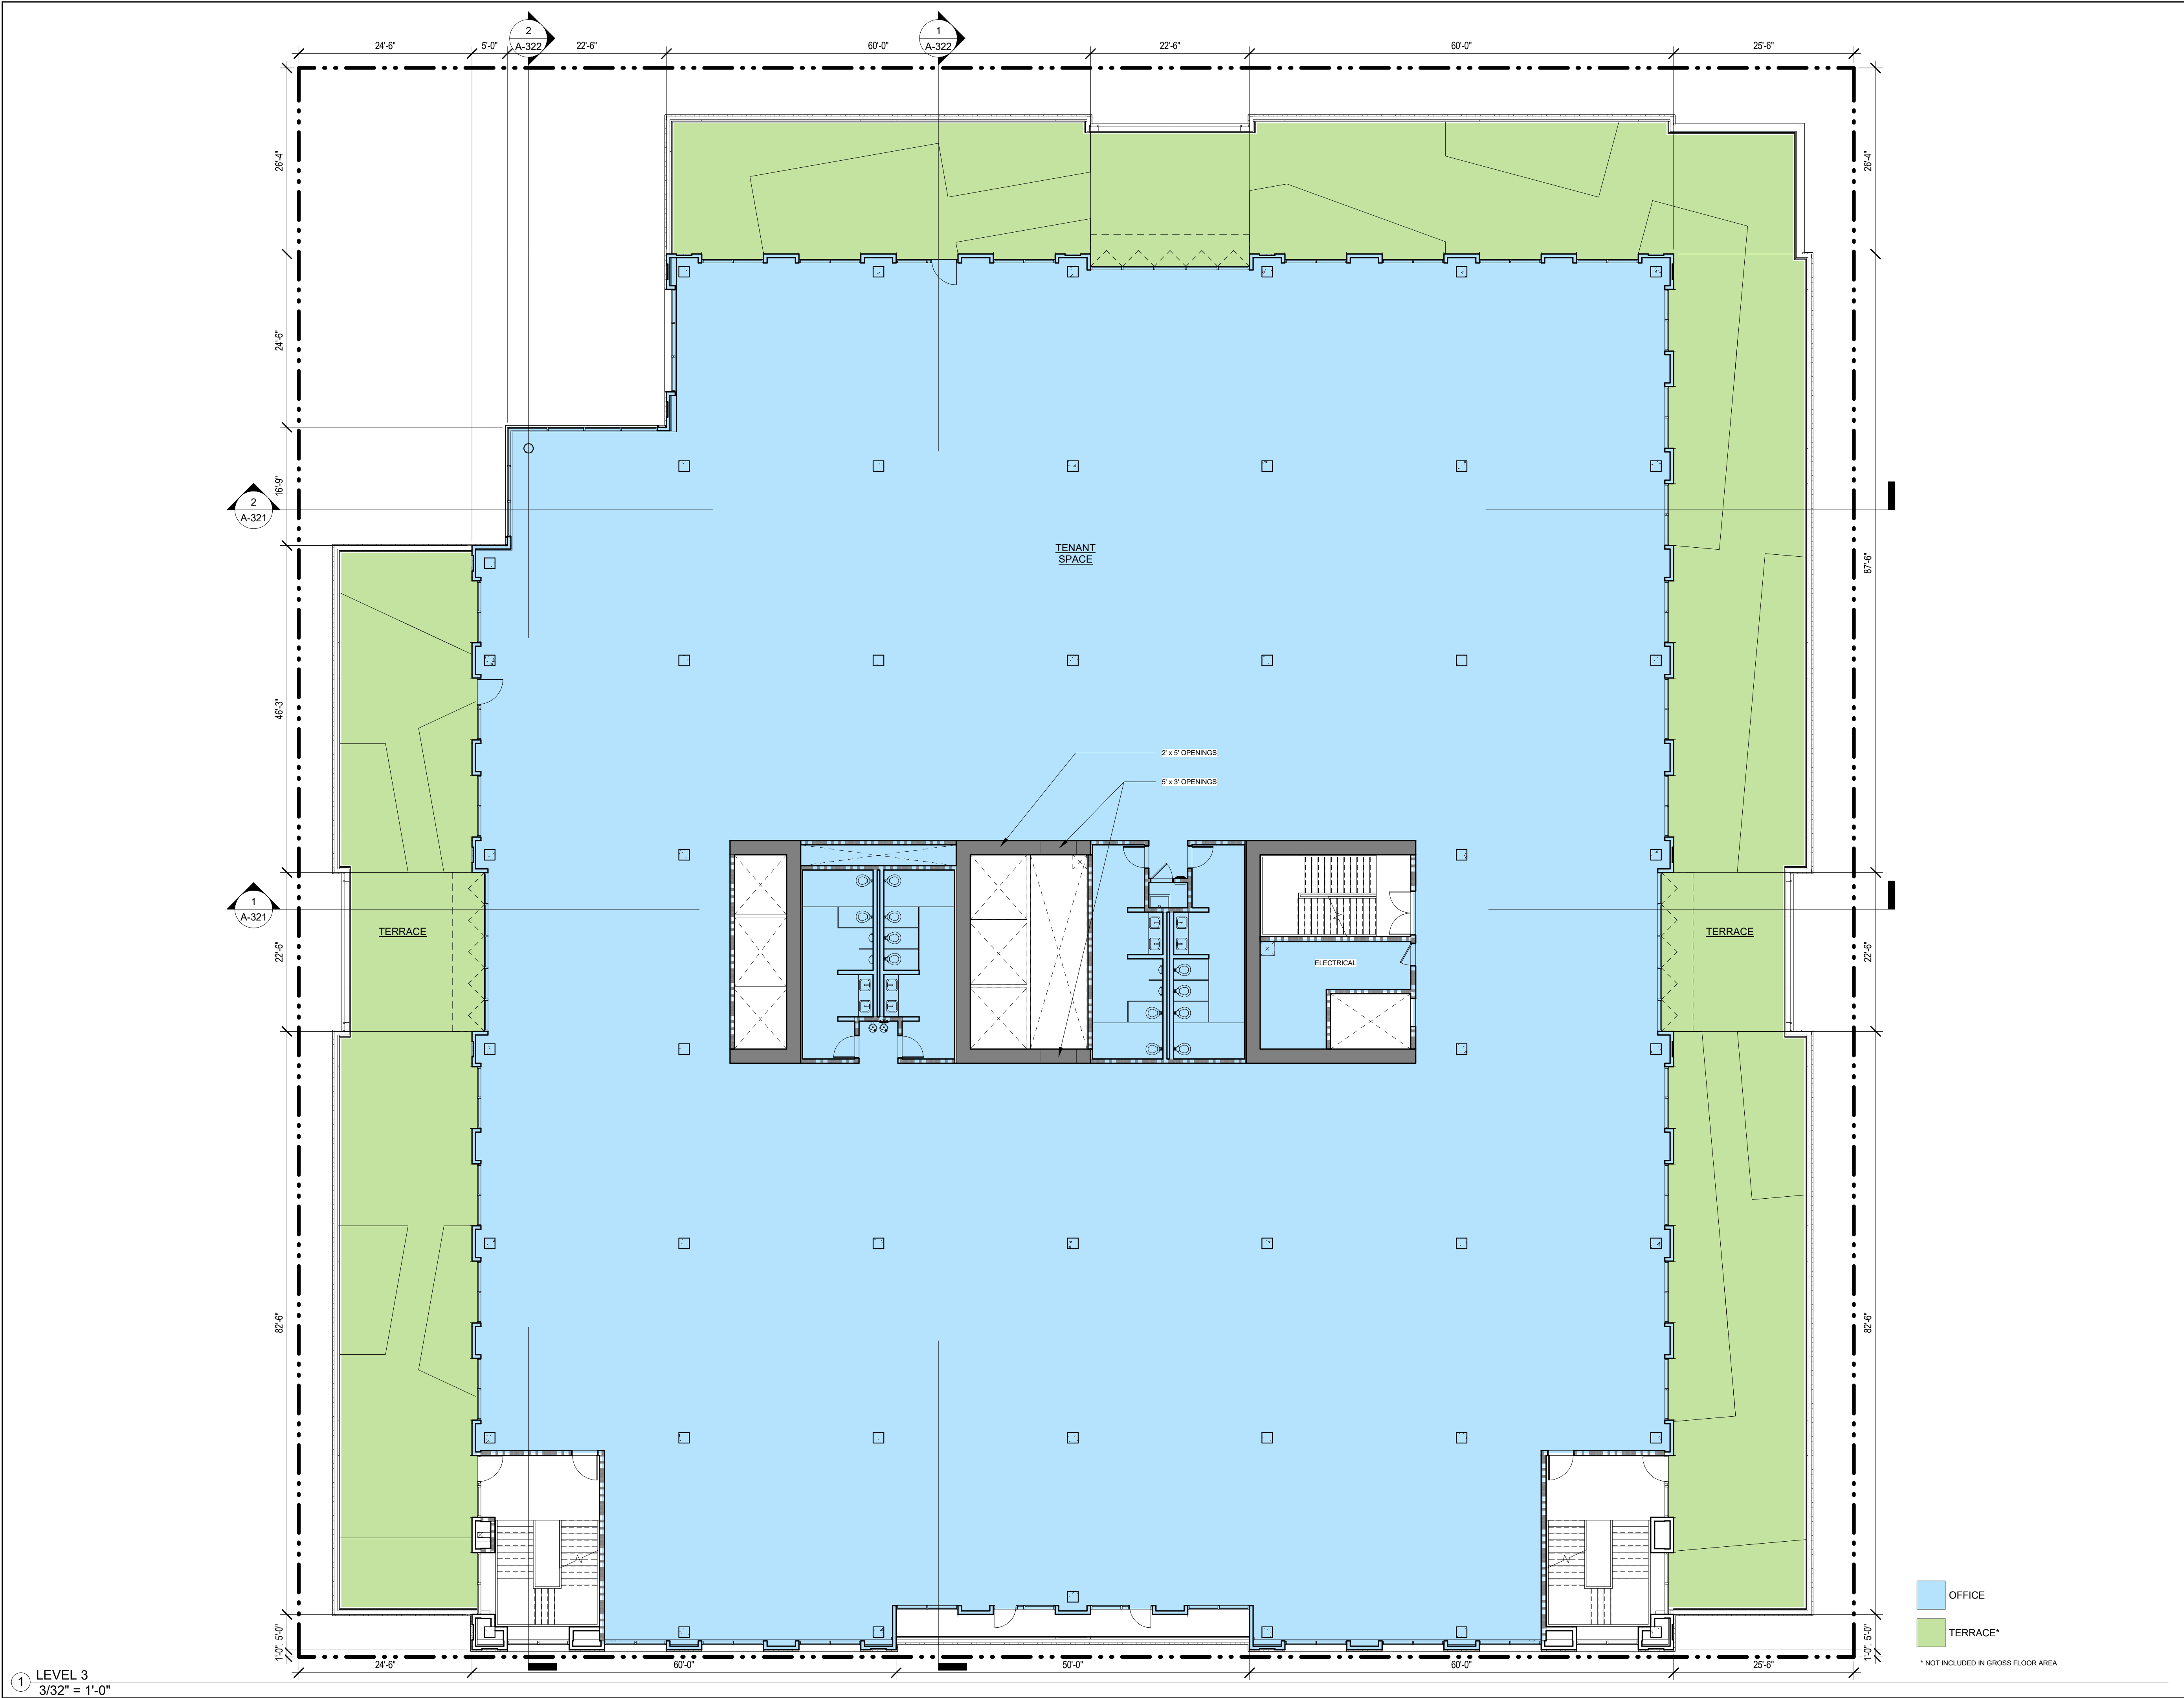
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LEVEL 3 FLOOR PLAN


SCALE
3/32" = 1'-0"



SHEET NUMBER

A-203



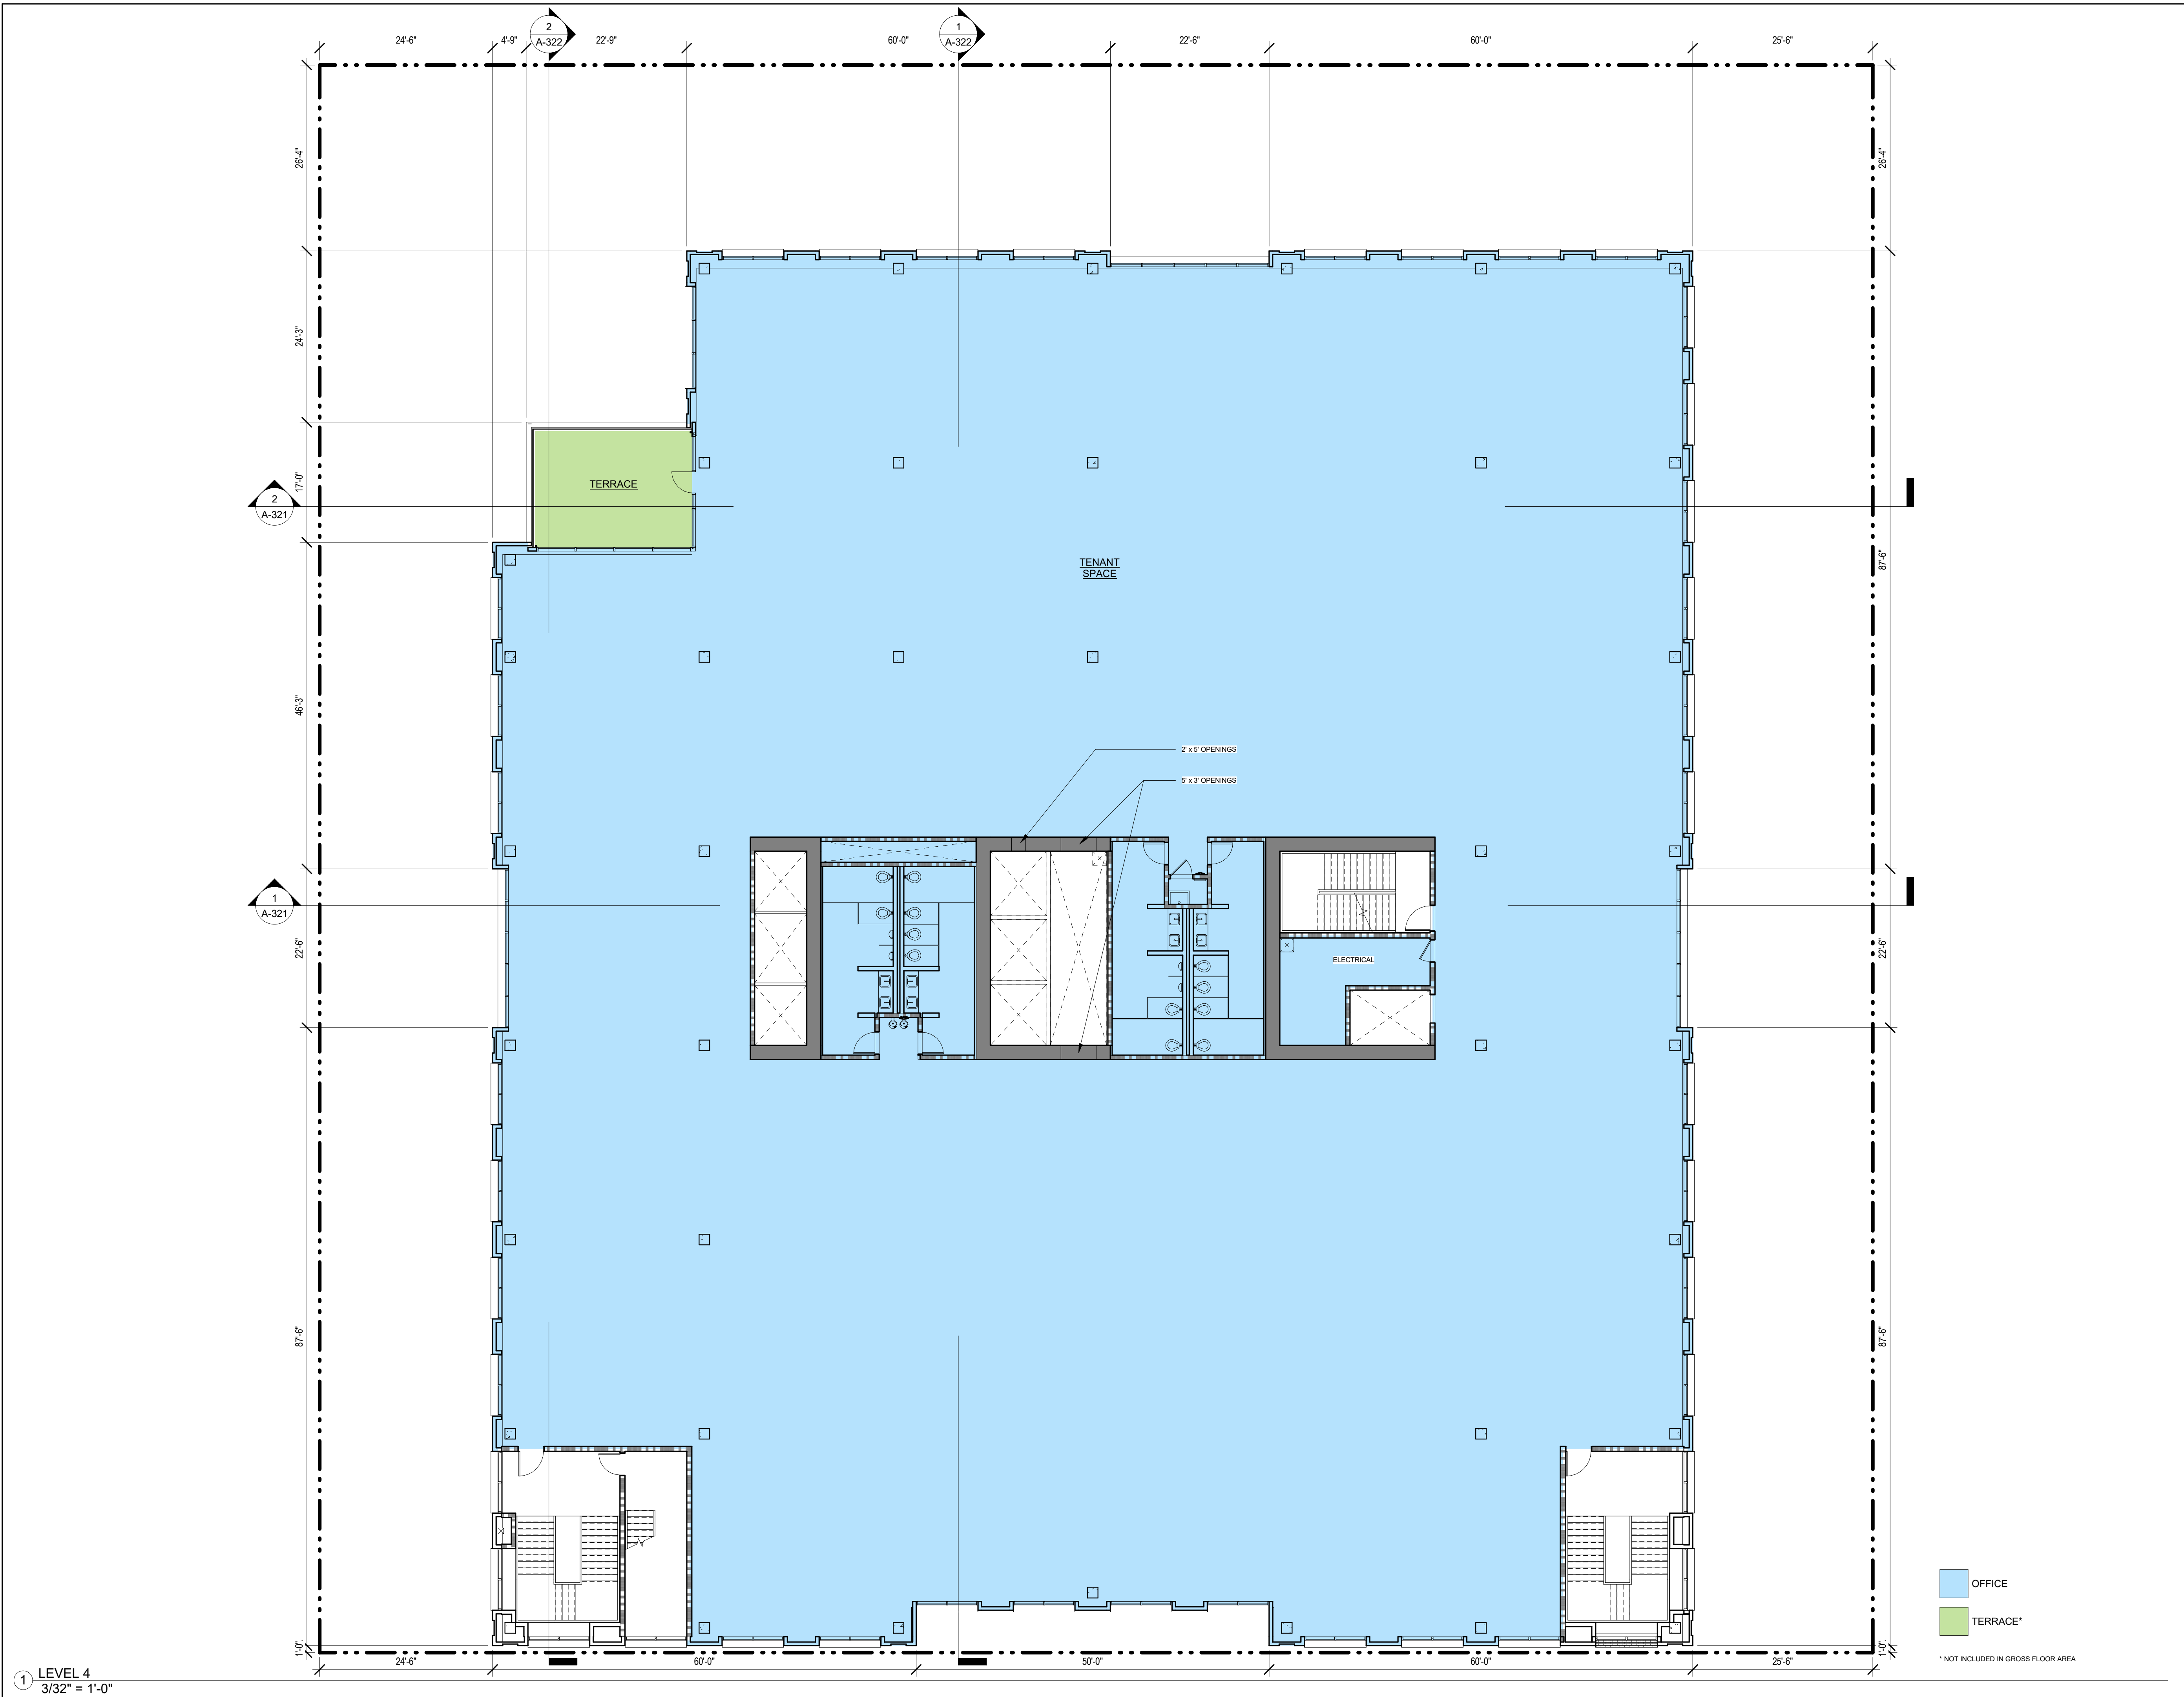

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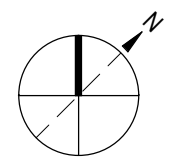
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SHEET TITLE
LEVEL 4 FLOOR PLAN

SCALE
3/32" = 1'-0"



SHEET NUMBER

A-204



ARCHITECTS
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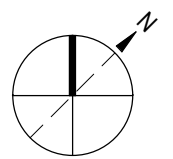
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SHEET TITLE
LEVEL 5 FLOOR PLAN

SCALE
3/32" = 1'-0"



SHEET NUMBER

A-205





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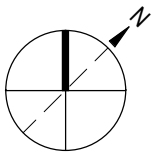
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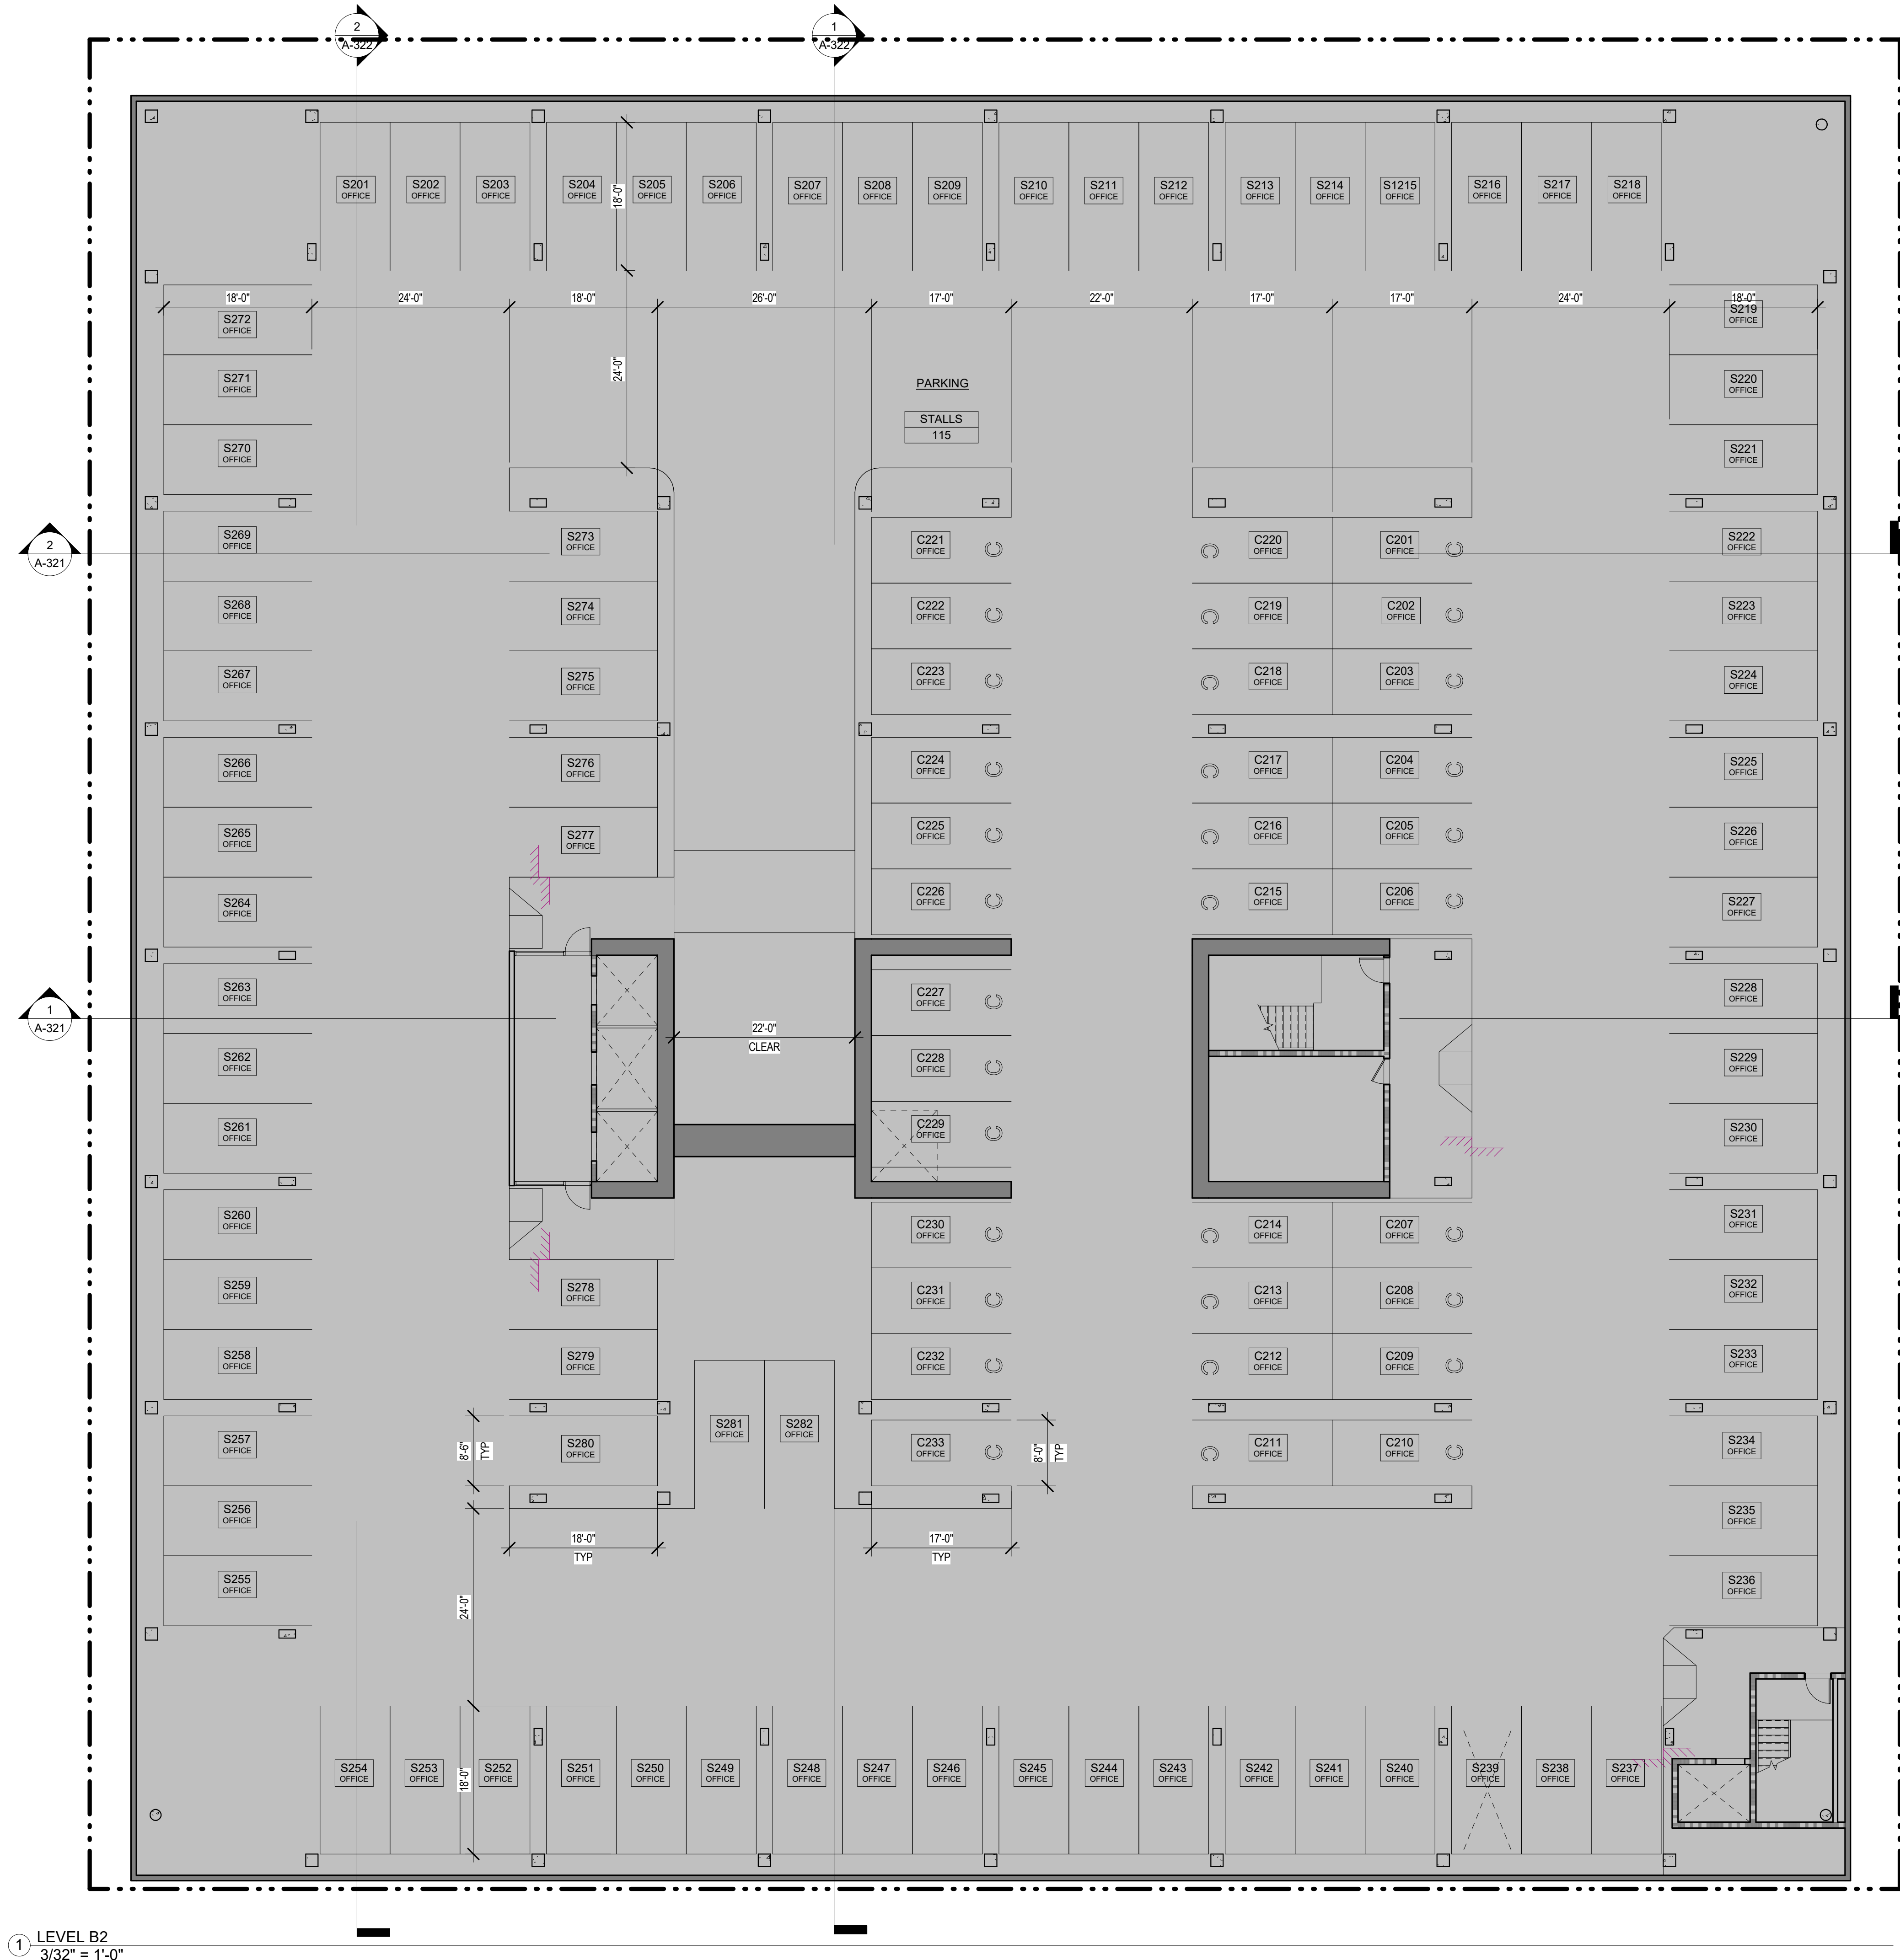
SHEET TITLE
LEVEL B2 FLOOR PLAN

SCALE
3/32" = 1'-0"



SHEET NUMBER

A-207



1 LEVEL B2
3/32" = 1'-0"

PARKING*
* NOT INCLUDED IN GROSS FLOOR AREA



ARCHITECTS
KORTH SUNSERI HAGEY


ISSUES AND REVISIONS

No.	Date	Description
A	10/21/20	Pre-App Resubmittal

PROJECT NUMBER
16010.00


SHEET TITLE
RESIDENTIAL UNIT PLANS

SCALE
1/4" = 1'-0"

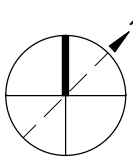


SHEET NUMBER


A-210

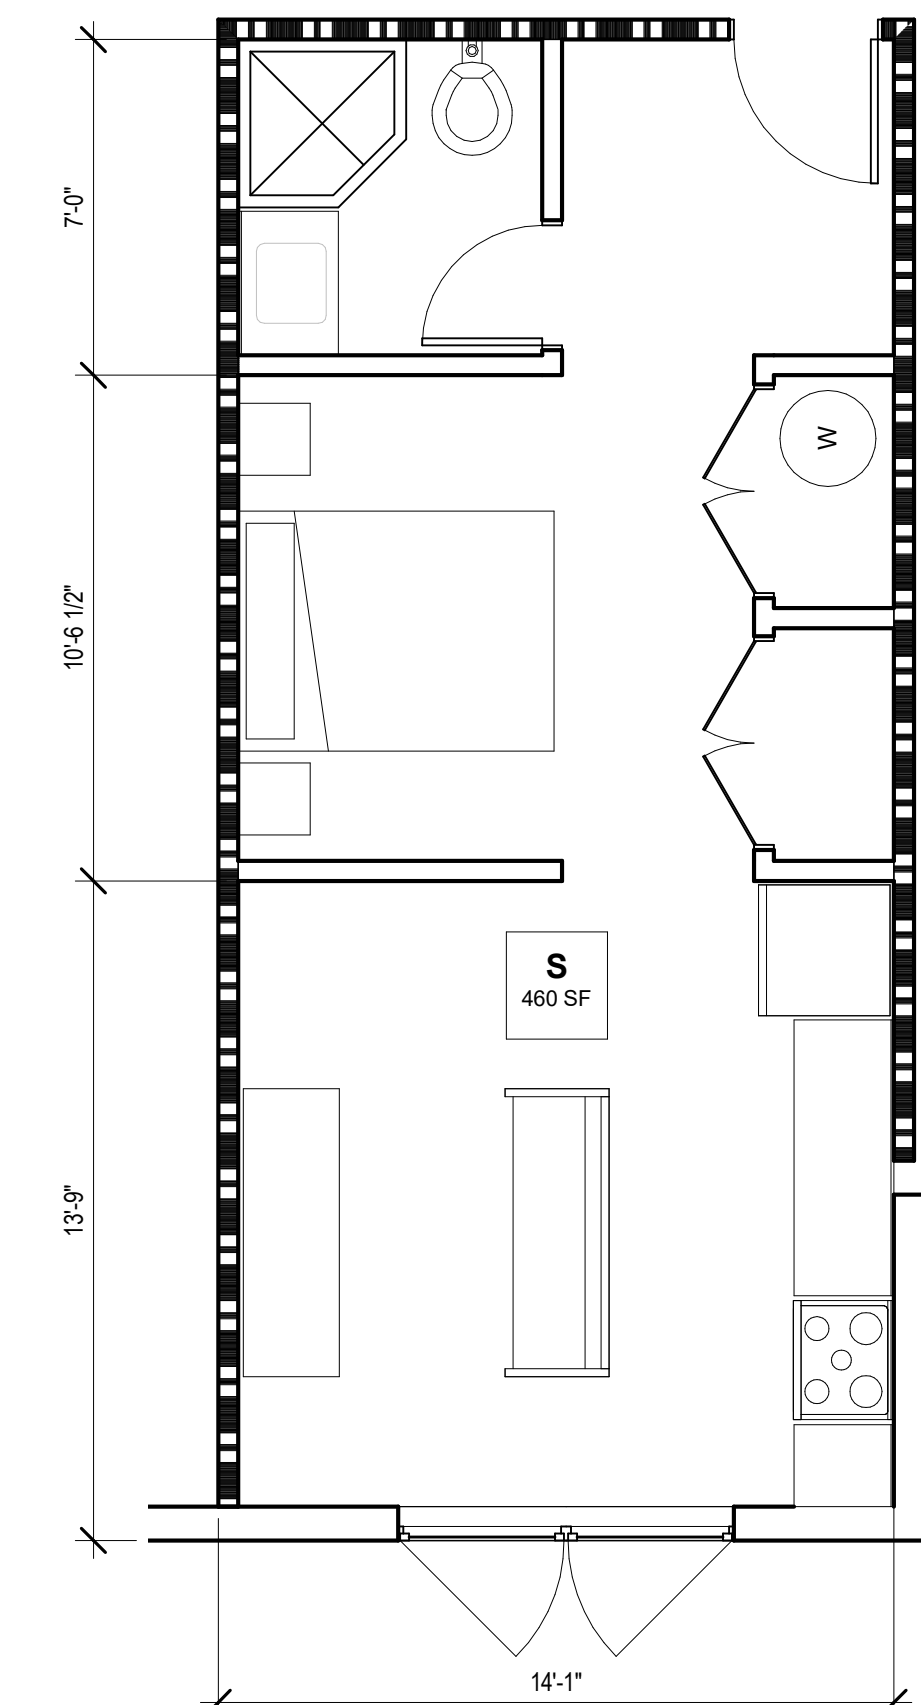

③ STUDIO
1/4" = 1'-0"

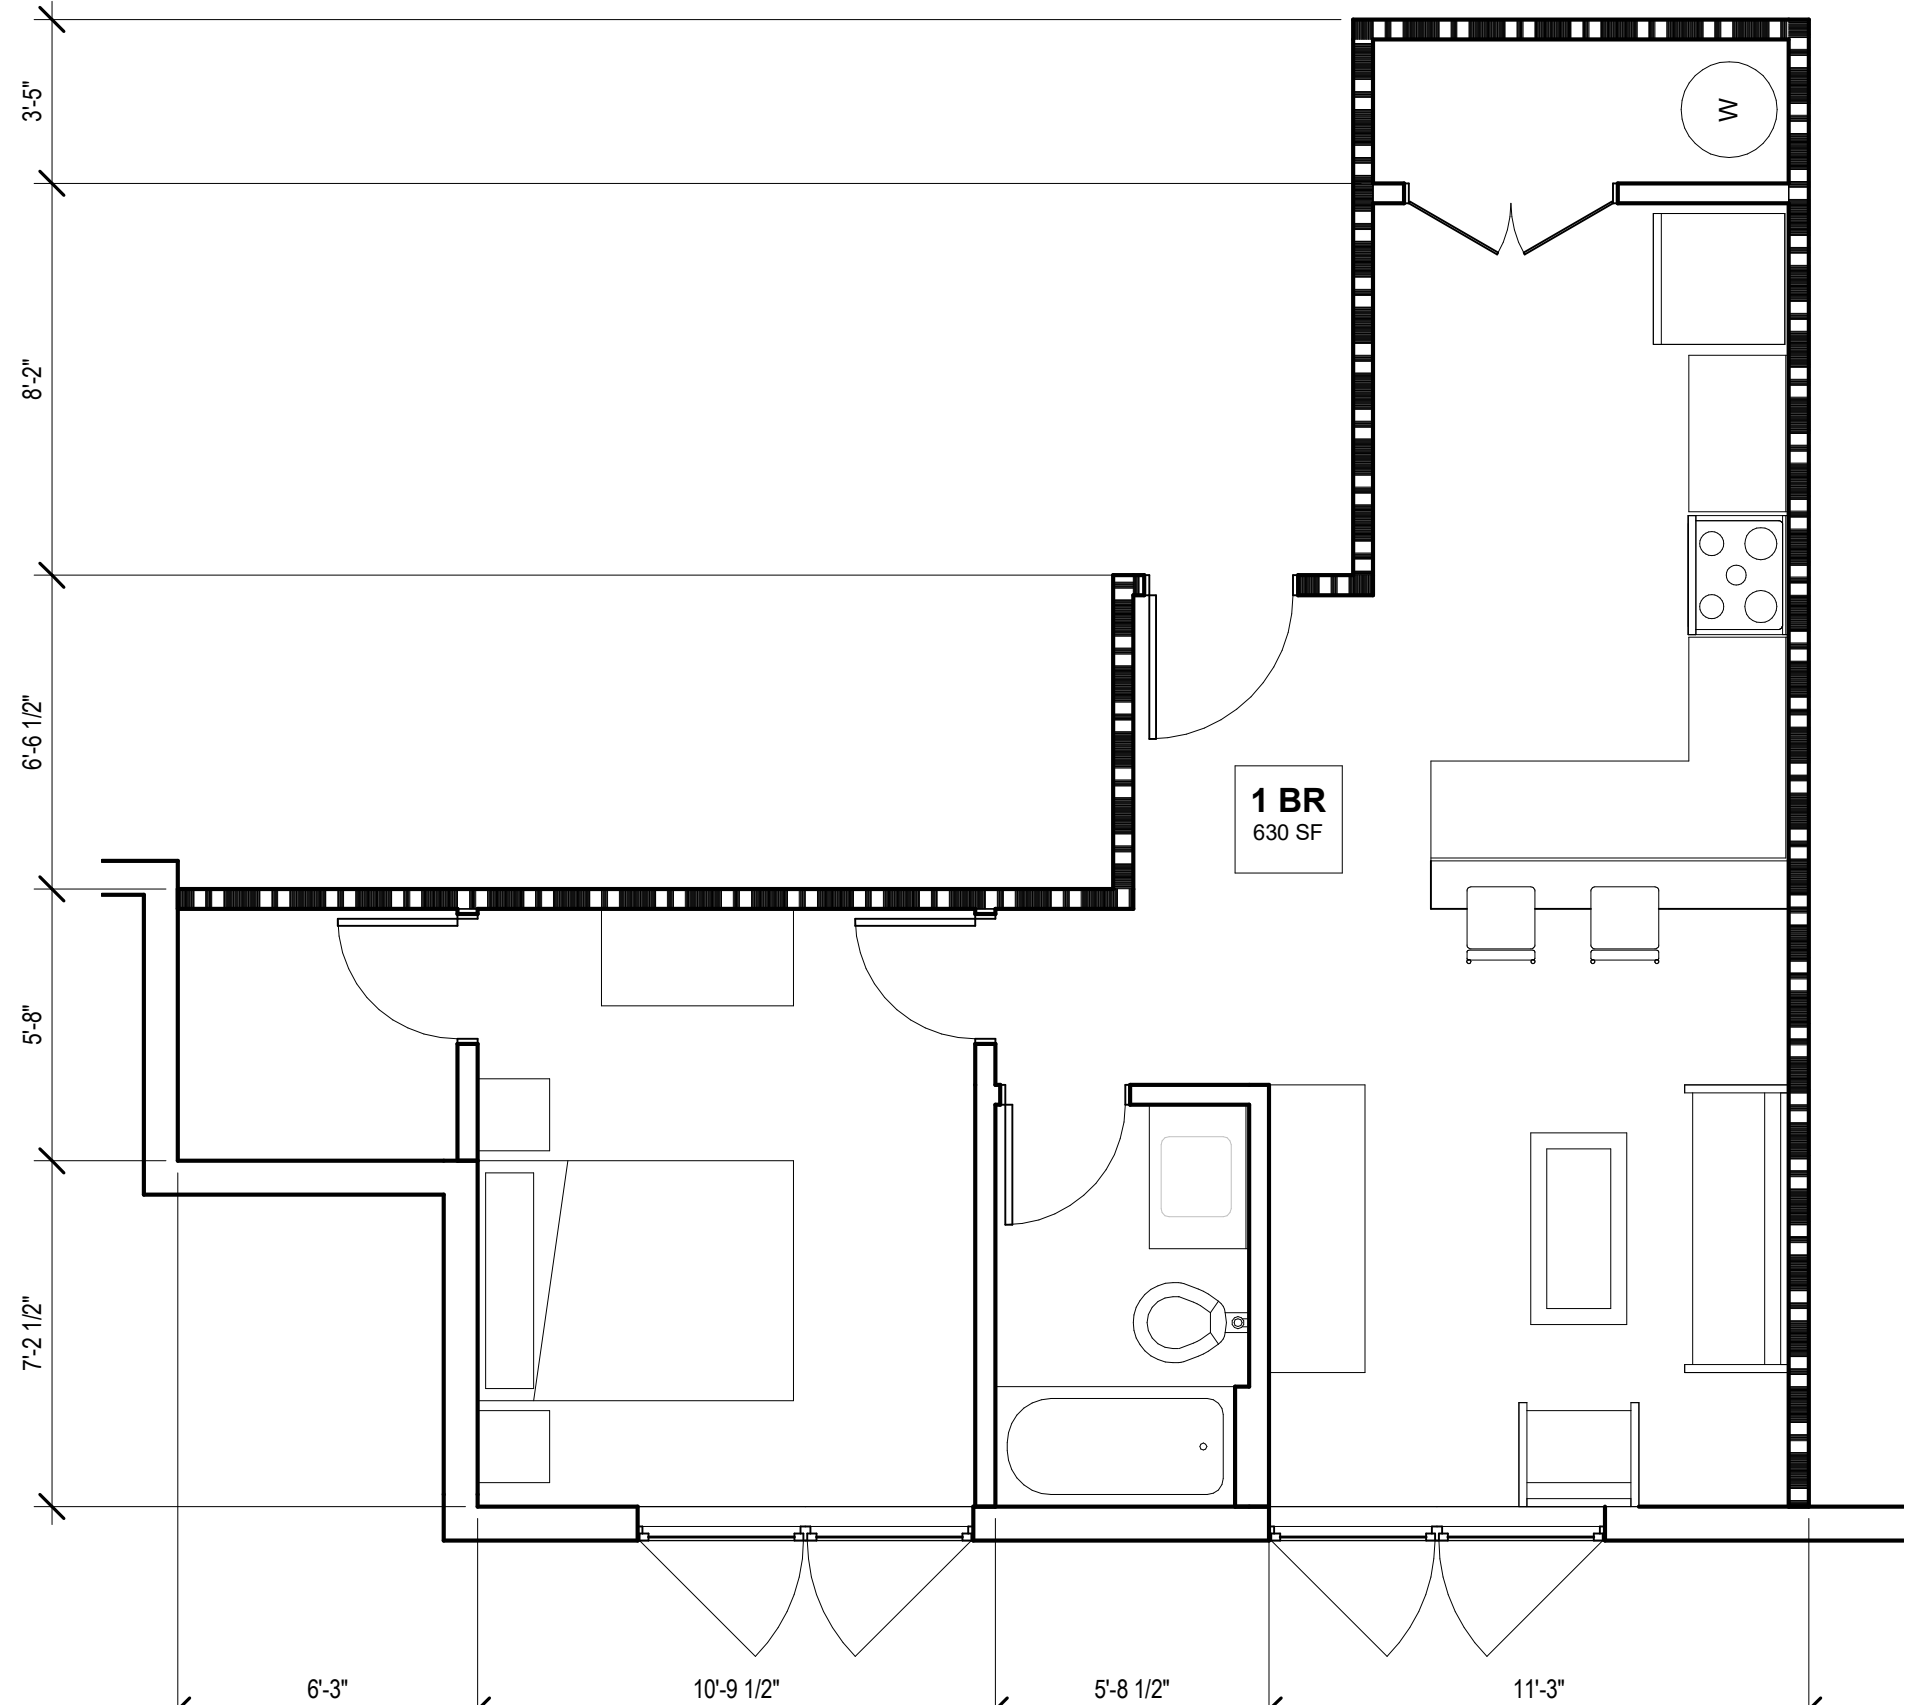

② 1-BED TYPE B
1/4" = 1'-0"

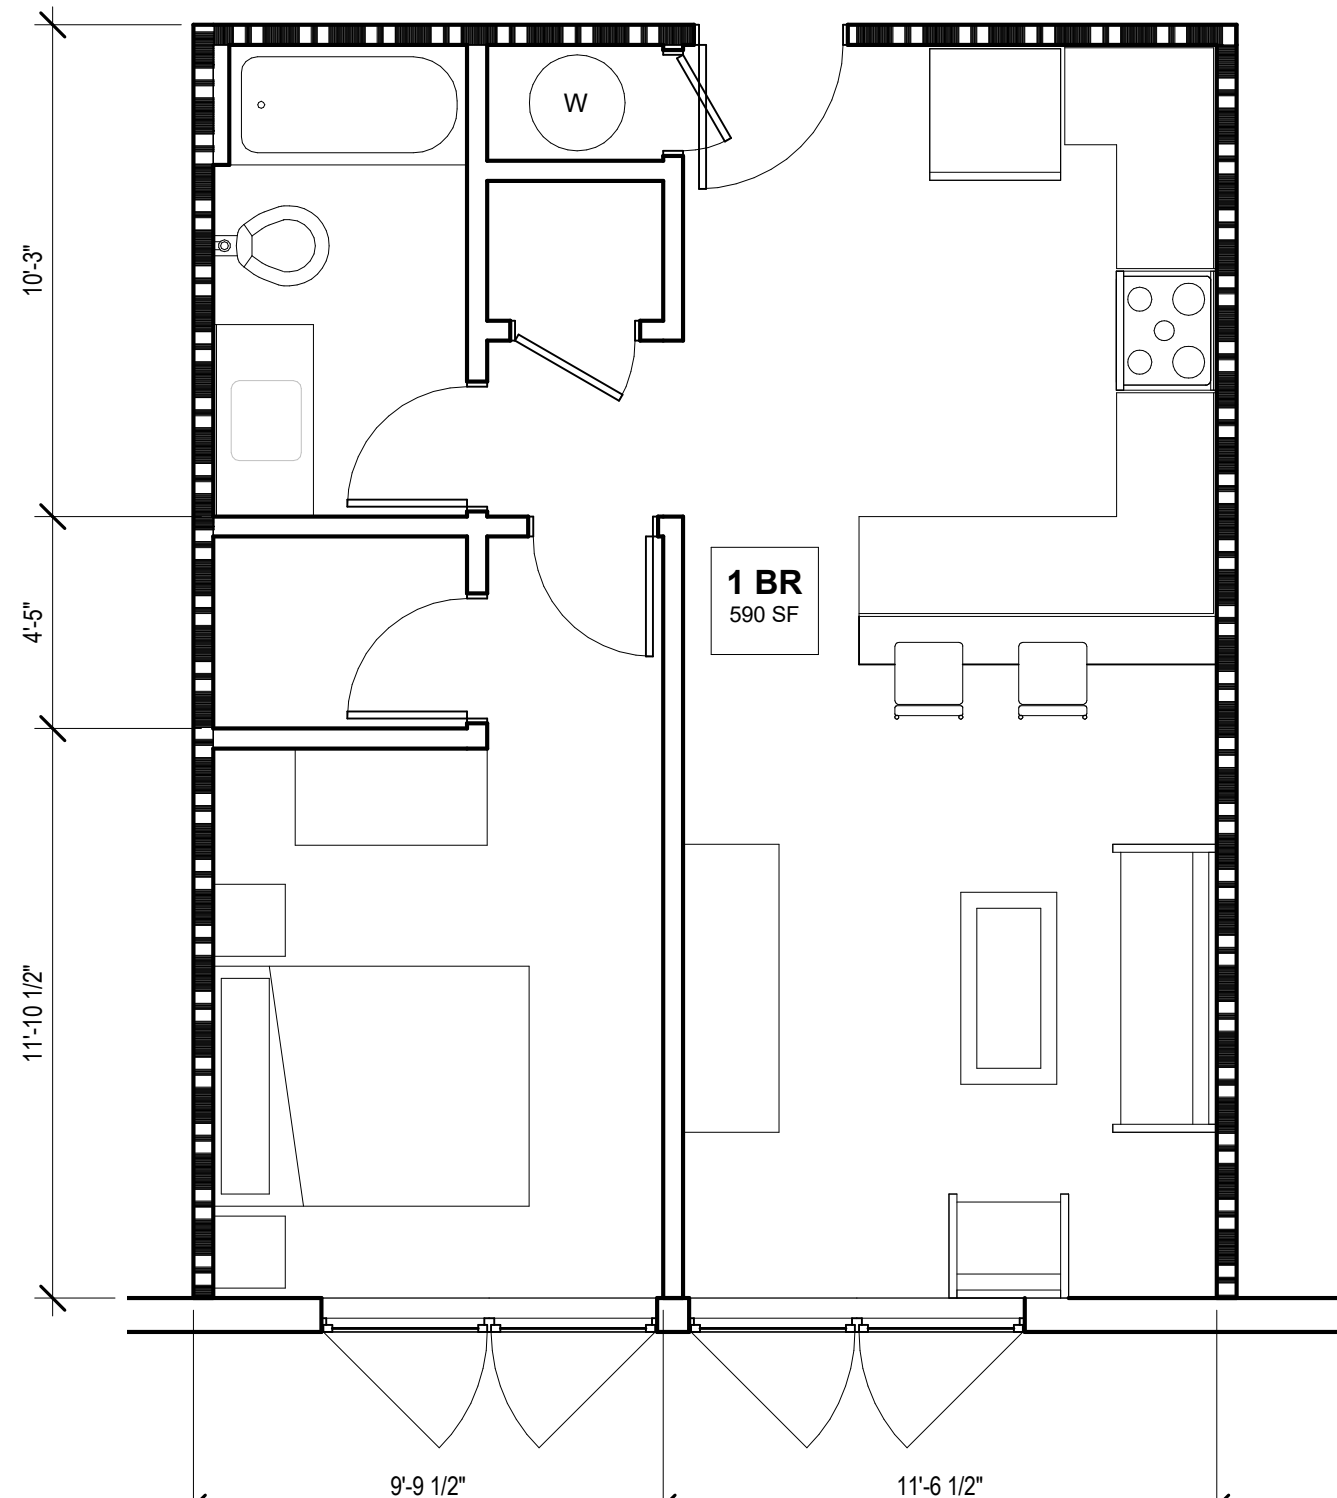

① 1-BED TYPE A
1/4" = 1'-0"



ARCHITECTS
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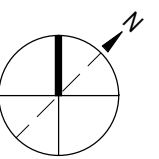
ISSUES AND REVISIONS

No.	Date	Description
A	05/05/20	Pre-Application Set
B	10/21/20	Pre-App Resubmittal
C	03/19/21	Pre-App Resubmittal

PROJECT NUMBER
16010.00

SHEET TITLE
DESIGN CONTEXT PLAN

SCALE
1" = 20'-0"




SHEET NUMBER

A-220



VIEW 1: FACADE TYPE 1
SEE SHEET A-301 FOR MORE INFORMATION

TYPE 1

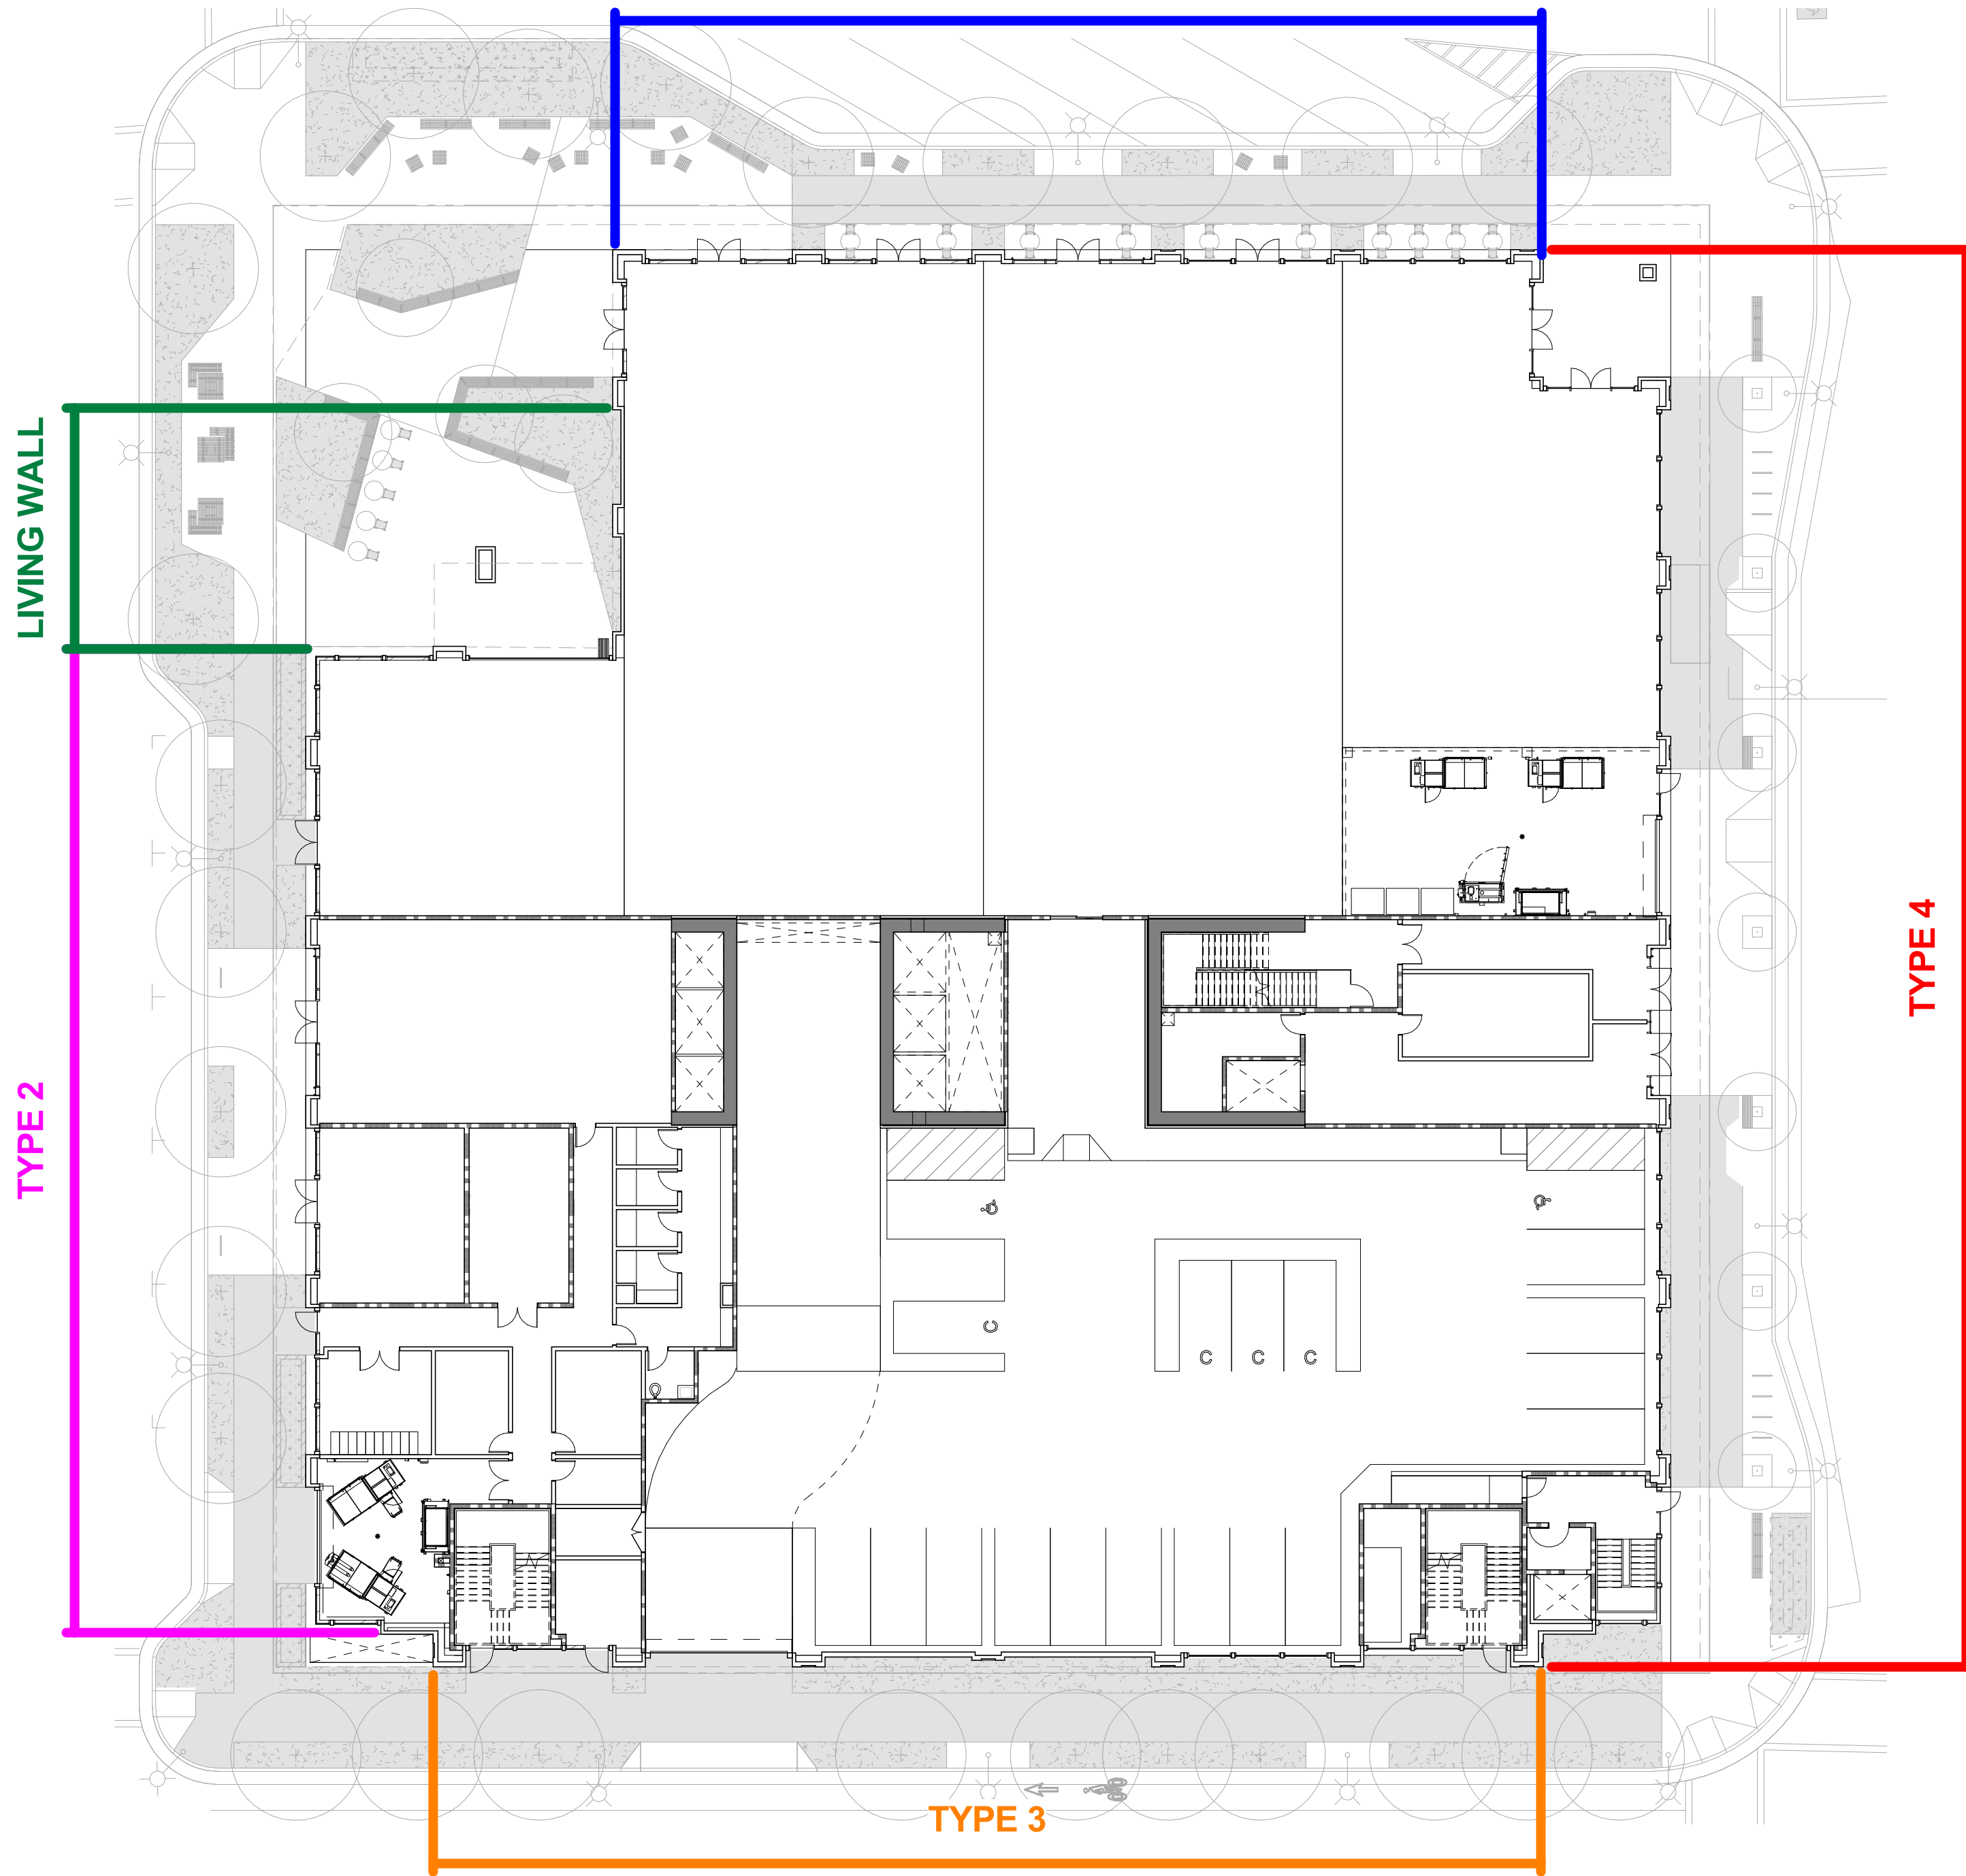

VIEW 2: FACADE TYPE 2
SEE SHEET A-302 FOR ADDITIONAL INFORMATION

TYPE 2



VIEW 4: FACADE TYPE 4
SEE SHEET A-304 FOR MORE INFORMATION

TYPE 4



VIEW 3: FACADE TYPE 3
SEE SHEET A-303 FOR MORE INFORMATION

TYPE 3

[SEE SHEETS A-401 - A-404 FOR MORE INFORMATION ON FACADE TYPES]




ISSUES AND REVISIONS

No.	Date	Description
A	04/22/22	Planning Resubmittal

PROJECT NUMBER
16010.00


SHEET TITLE
LEVEL 1 VEHICLE TURNING
ANALYSIS

SCALE
1/16" = 1'-0"

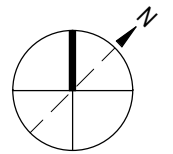

SHEET NUMBER

A-231

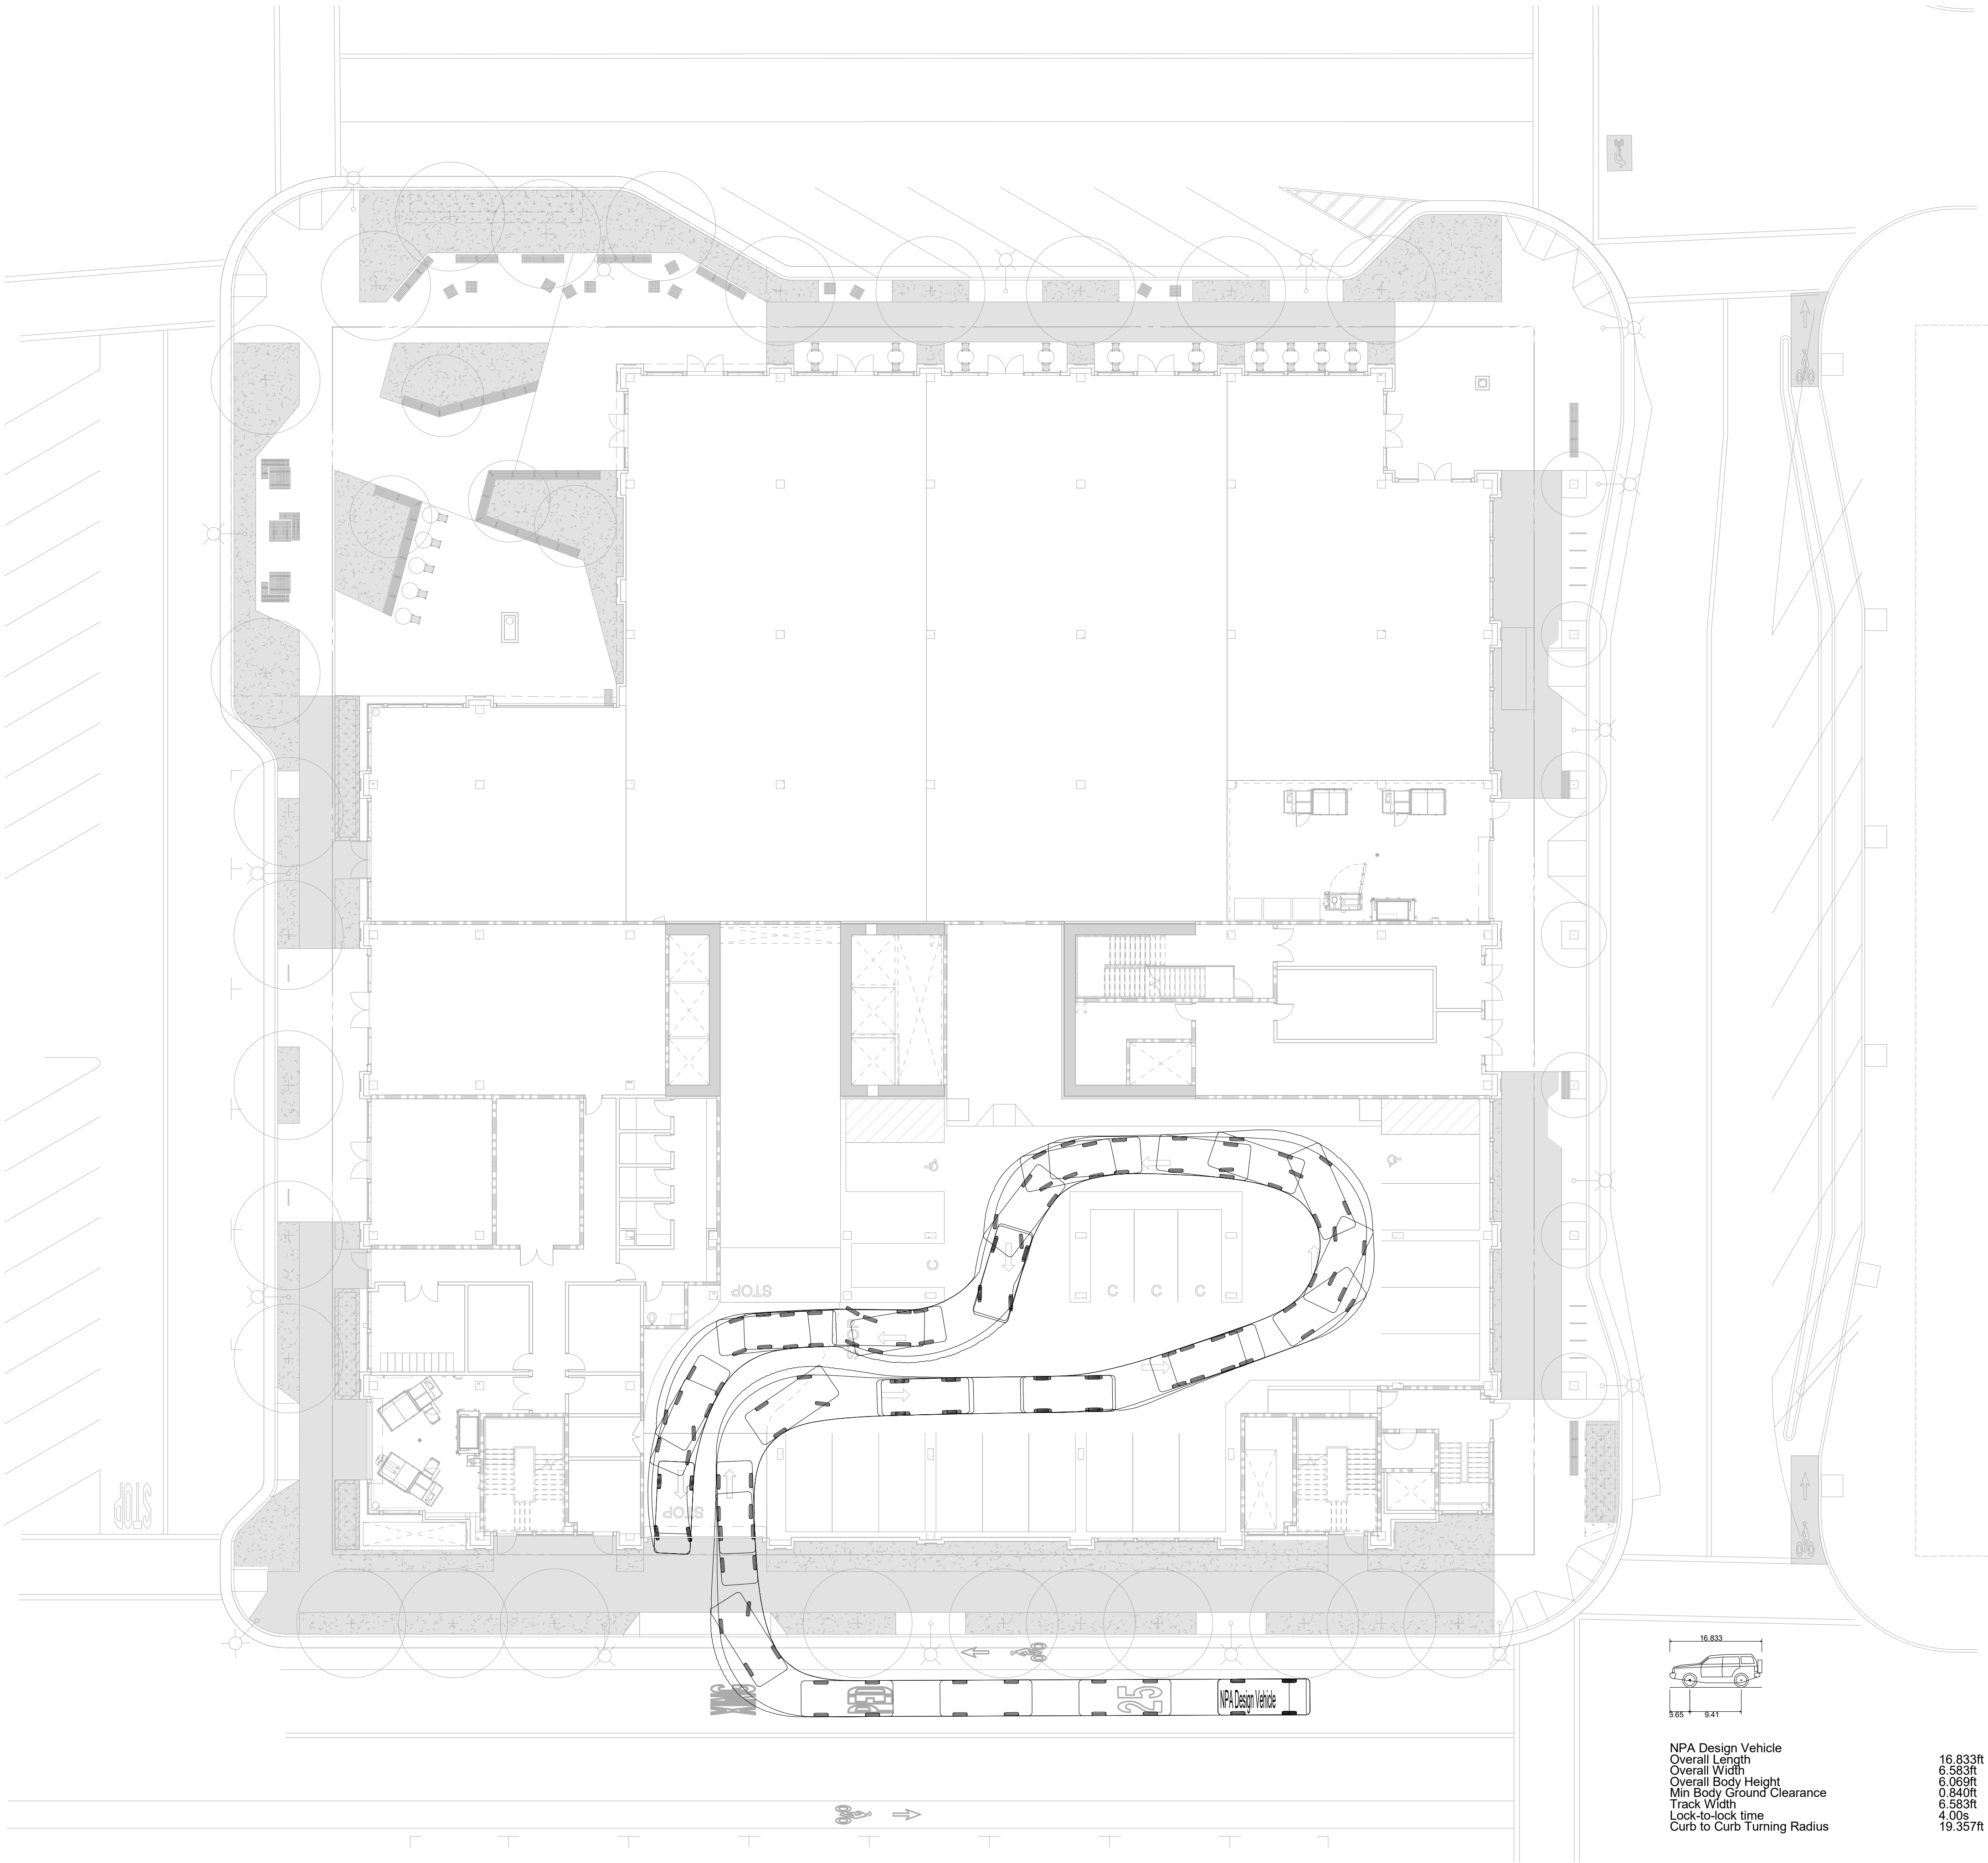



ARCHITECTS
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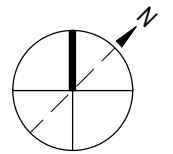
ISSUES AND REVISIONS

No.	Date	Description
A	04/22/22	Planning Resubmittal

PROJECT NUMBER
16010.00



SHEET TITLE
LEVEL B1 & B2 VEHICLE TURNING
ANALYSIS

SCALE
1/16" = 1'-0"





SHEET NUMBER

A-232

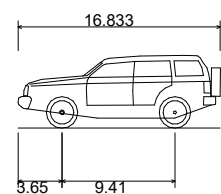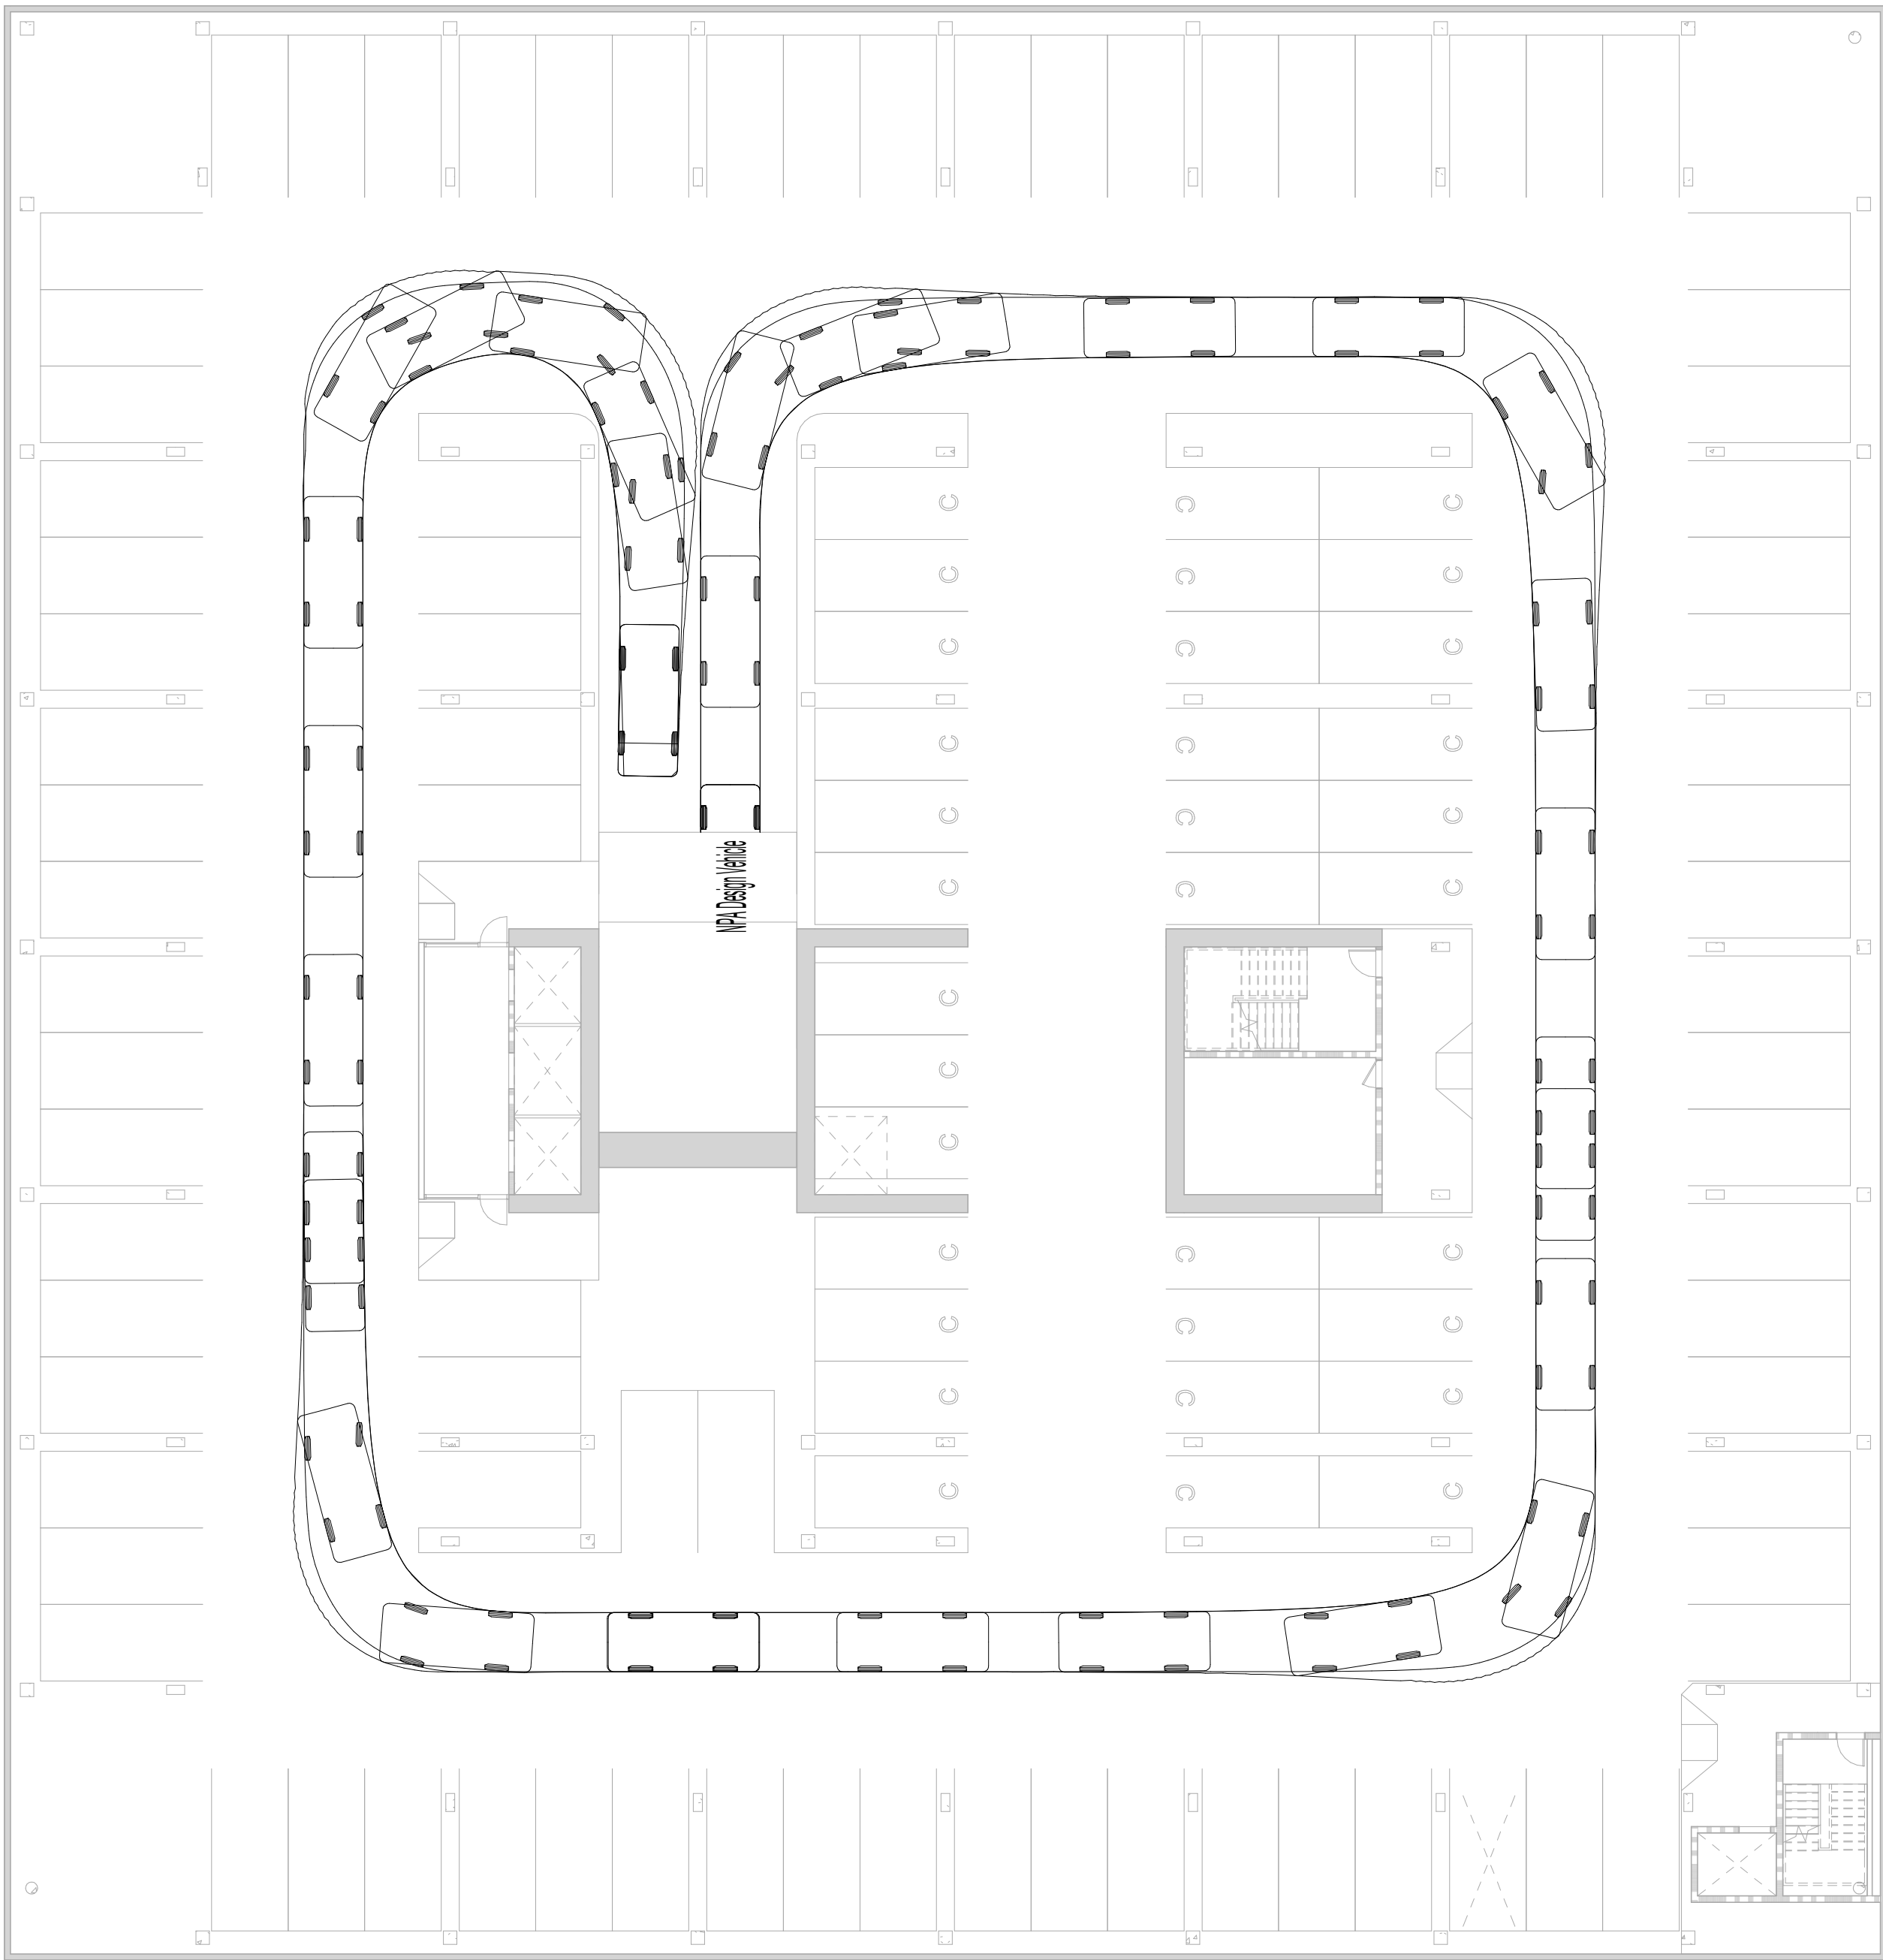

NPA Design Vehicle
Overall Length 16.833ft
Overall Width 6.583ft
Overall Body Height 6.069ft
Min Body Ground Clearance 0.840ft
Track Width 6.583ft
Lock-to-lock time 4.00s
Curb to Curb Turning Radius 19.357ft

② LEVEL B2 - VEHICLE TURNING ANALYSIS
1/16" = 1'-0"

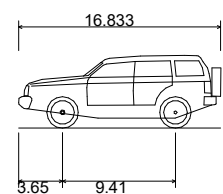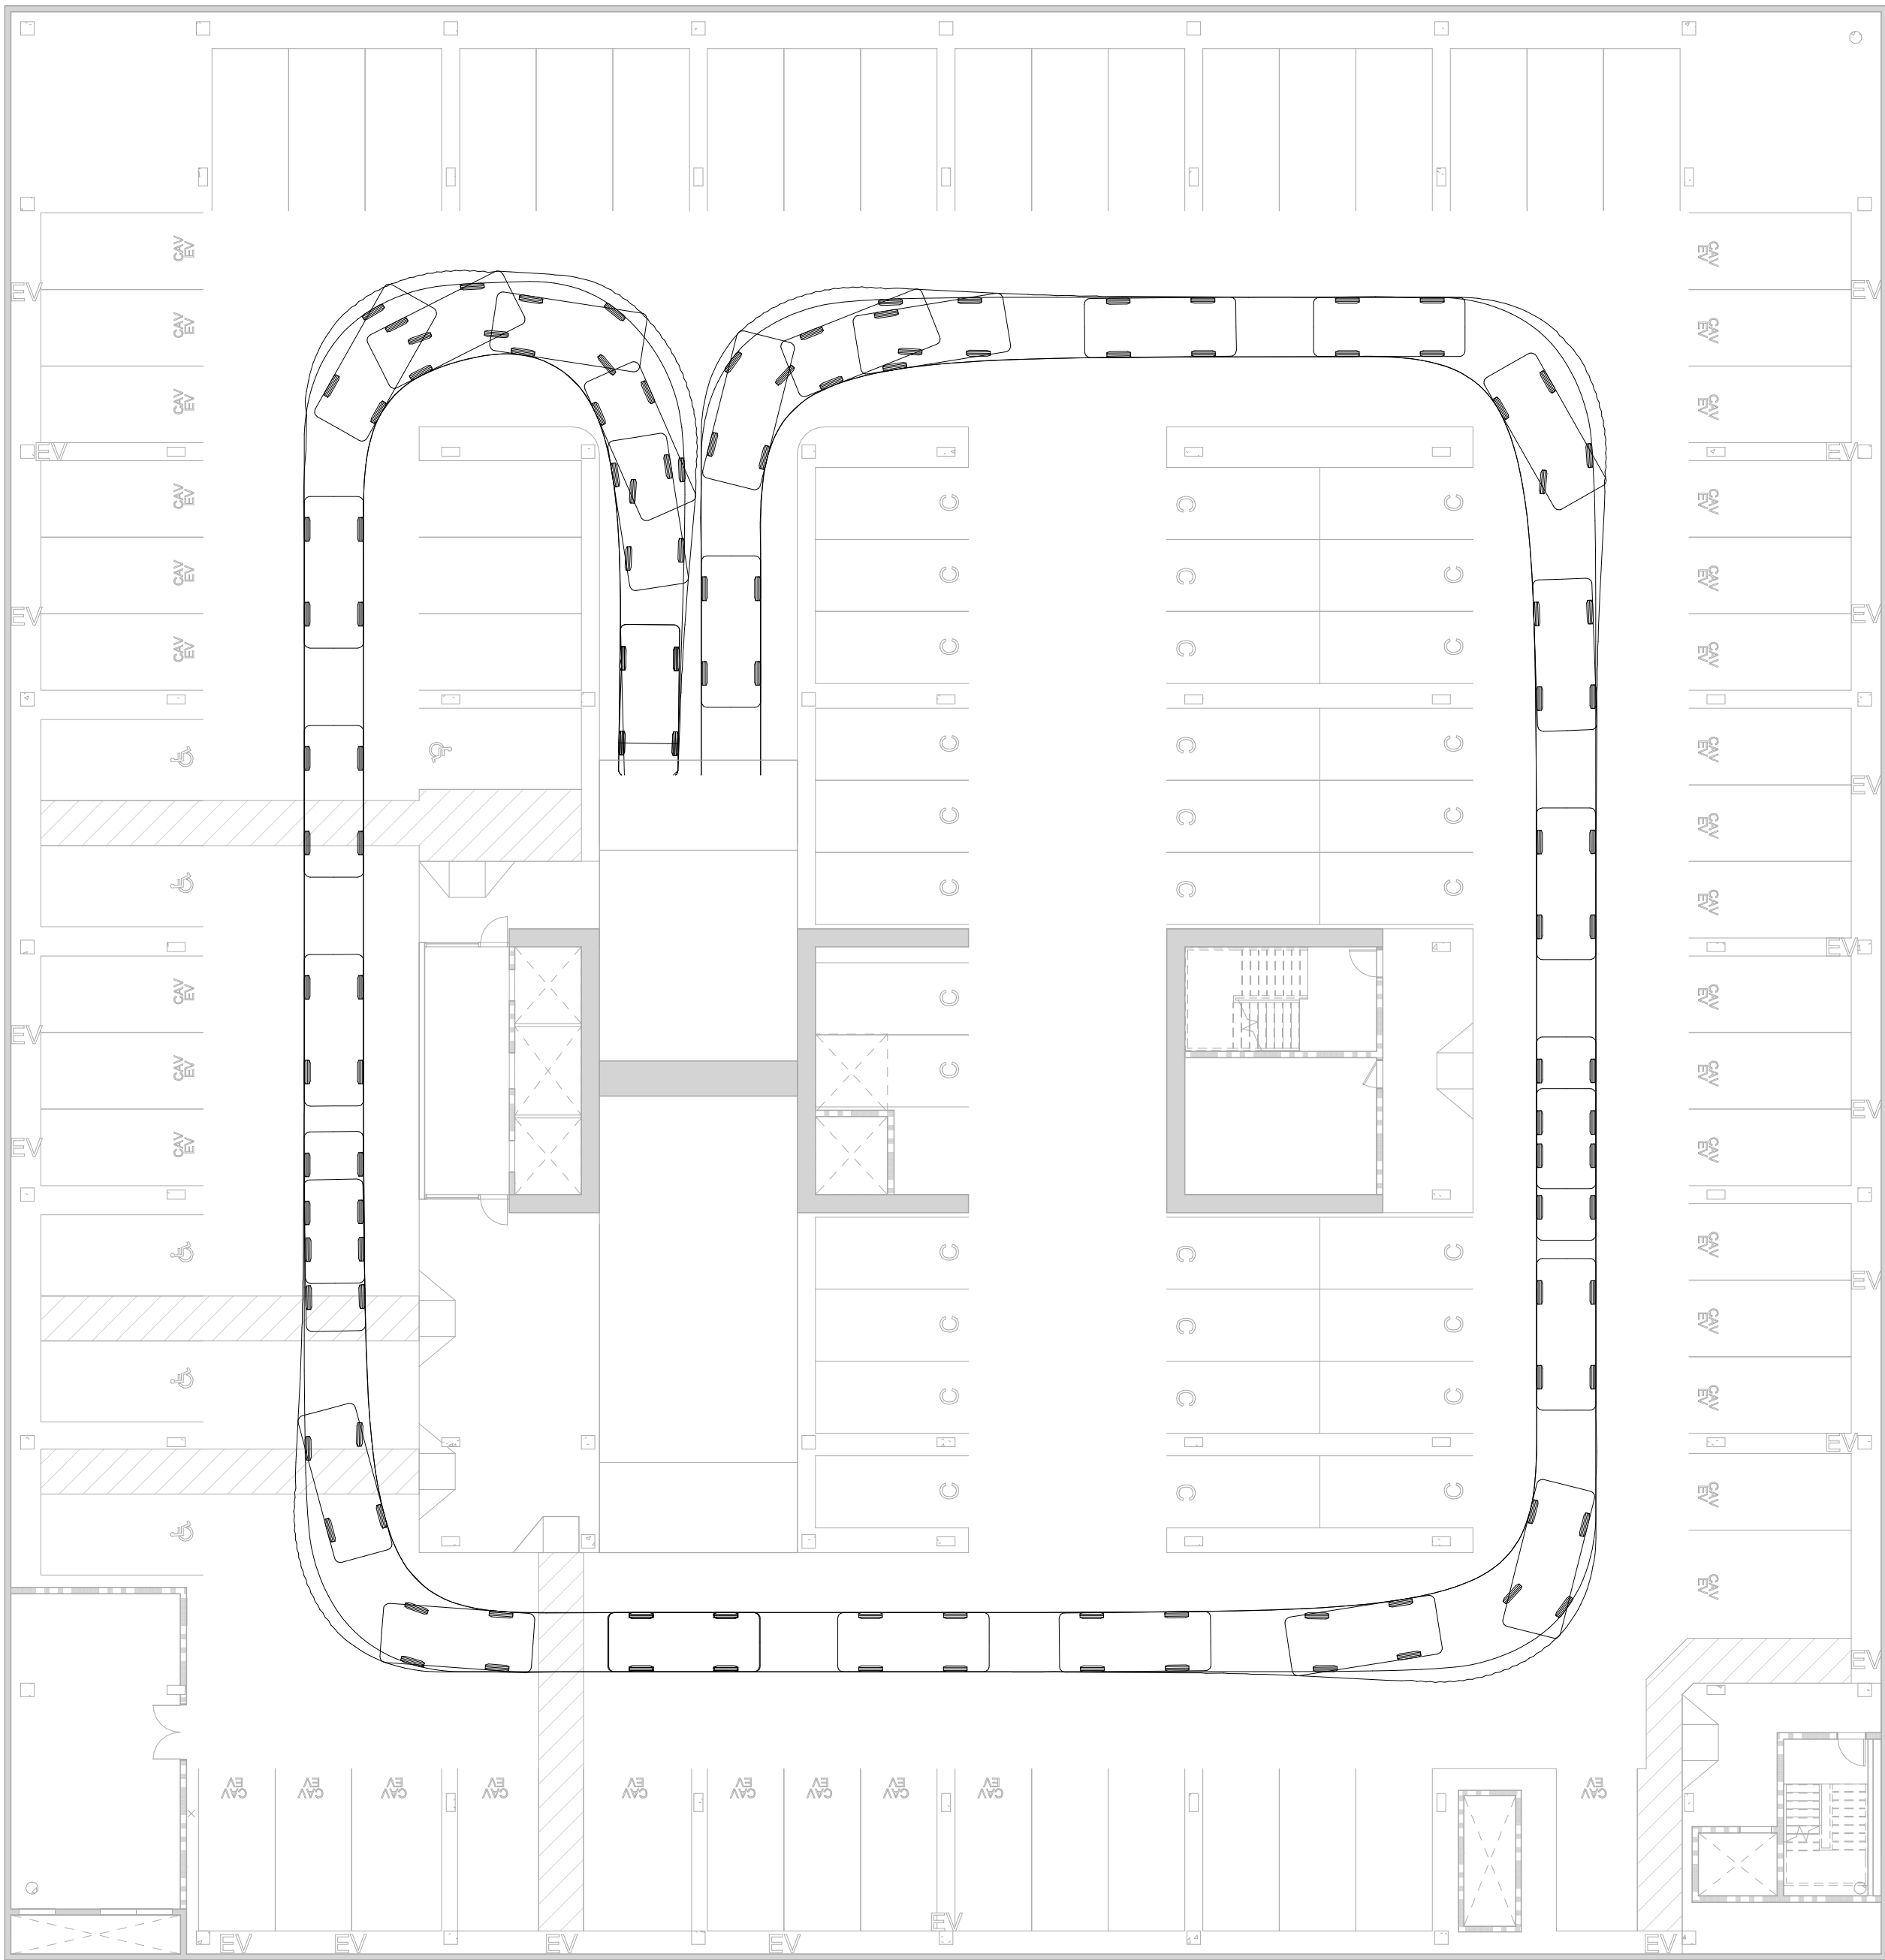

NPA Design Vehicle
Overall Length 16.833ft
Overall Width 6.583ft
Overall Body Height 6.069ft
Min Body Ground Clearance 0.840ft
Track Width 6.583ft
Lock-to-lock time 4.00s
Curb to Curb Turning Radius 19.357ft

① LEVEL B1 - VEHICLE TURNING ANALYSIS
1/16" = 1'-0"



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ISSUES AND REVISIONS

No.	Date	Description
A	05/05/20	Pre-Application Set
B	10/21/20	Pre-App Resubmittal
C	03/19/21	Pre-App Resubmittal
D	10/15/21	Planning Application Set

PROJECT NUMBER
16010.00

SHEET TITLE
RENDERING

SCALE
3/32" = 1'-0"

SHEET NUMBER

A-301



- FACADE TYPE 1**
- 1A. WOOD STOREFRONT WINDOW SYSTEM WITH METAL AND WOOD CANOPY
 - 1B. WOOD STOREFRONT WINDOW SYSTEM WITH DIVIDED TRANSOM LITES AND FABRIC AWNING
 - 1C. RECESSED METAL STOREFRONT WINDOW SYSTEM WITH PROFILED METAL HEADERS AND JAMBS AND GLASS CANOPY



ARCHITECTS
KORTH SUNSERI HAGEY

ISSUES AND REVISIONS

No.	Date	Description
A	05/05/20	Pre-Application Set
B	10/21/20	Pre-App Resubmittal
C	03/19/21	Pre-App Resubmittal
D	10/15/21	Planning Application Set

PROJECT NUMBER
16010.00

SHEET TITLE
RENDERING

SCALE
3/32" = 1'-0"

SHEET NUMBER

A-302



- FACADE TYPE 2**
- 2A. WOOD STOREFRONT WINDOW SYSTEM WITH METAL AND WOOD CANOPY
 - 2B. WOOD STOREFRONT WINDOW SYSTEM
 - 2C. RECESSED METAL STOREFRONT WINDOW SYSTEM WITH PROFILED METAL HEADERS AND JAMBS AND GLASS CANOPY
 - 2D. WOOD "NANAWALL" SYSTEM WITH WOOD SOFFIT AND CLADDING
 - 2E. VINE-COVERED WALL



ARCHITECTS
KORTH SUNSERI HAGEY

ISSUES AND REVISIONS

No.	Date	Description
A	05/05/20	Pre-Application Set
B	10/21/20	Pre-App Resubmittal
C	03/19/21	Pre-App Resubmittal
D	10/15/21	Planning Application Set

PROJECT NUMBER
16010.00

SHEET TITLE
RENDERING

SCALE
3/32" = 1'-0"

SHEET NUMBER

A-303



- FACADE TYPE 3**
- 3A. WOOD STOREFRONT WINDOW SYSTEM WITH DIVIDED TRANSOM LITES AND FABRIC AWNING
- 3B. WOOD STOREFRONT WINDOW SYSTEM
- 3C. RECESSED VINE-COVERED WALL

ISSUES AND REVISIONS

No.	Date	Description
A	05/05/20	Pre-Application Set
B	10/21/20	Pre-App Resubmittal
C	03/19/21	Pre-App Resubmittal
D	10/15/21	Planning Application Set
E	04/22/22	Planning Resubmittal

PROJECT NUMBER
16010.00

SHEET TITLE
RENDERING

SCALE
3/32" = 1'-0"

SHEET NUMBER

A-304



FACADE TYPE 4
4A. RECESSED METAL STOREFRONT WINDOW SYSTEM WITH PROFILED METAL HEADERS AND JAMBS AND GLASS CANOPY
4B. WOOD WINDOW SYSTEM WITH METAL AND WOOD CANOPY
4C. WOOD STOREFRONT WINDOW SYSTEM WITH DIVIDED TRANSOM LITES AND FABRIC AWNING



ARCHITECTS
KORTH SUNSERI HAGEY

ISSUES AND REVISIONS

No.	Date	Description
A	03/19/21	Pre-App Resubmittal
B	10/15/21	Planning Application Set

PROJECT NUMBER
16010.00


SHEET TITLE
RENDERING

SCALE
3/32" = 1'-0"

SHEET NUMBER

A-305



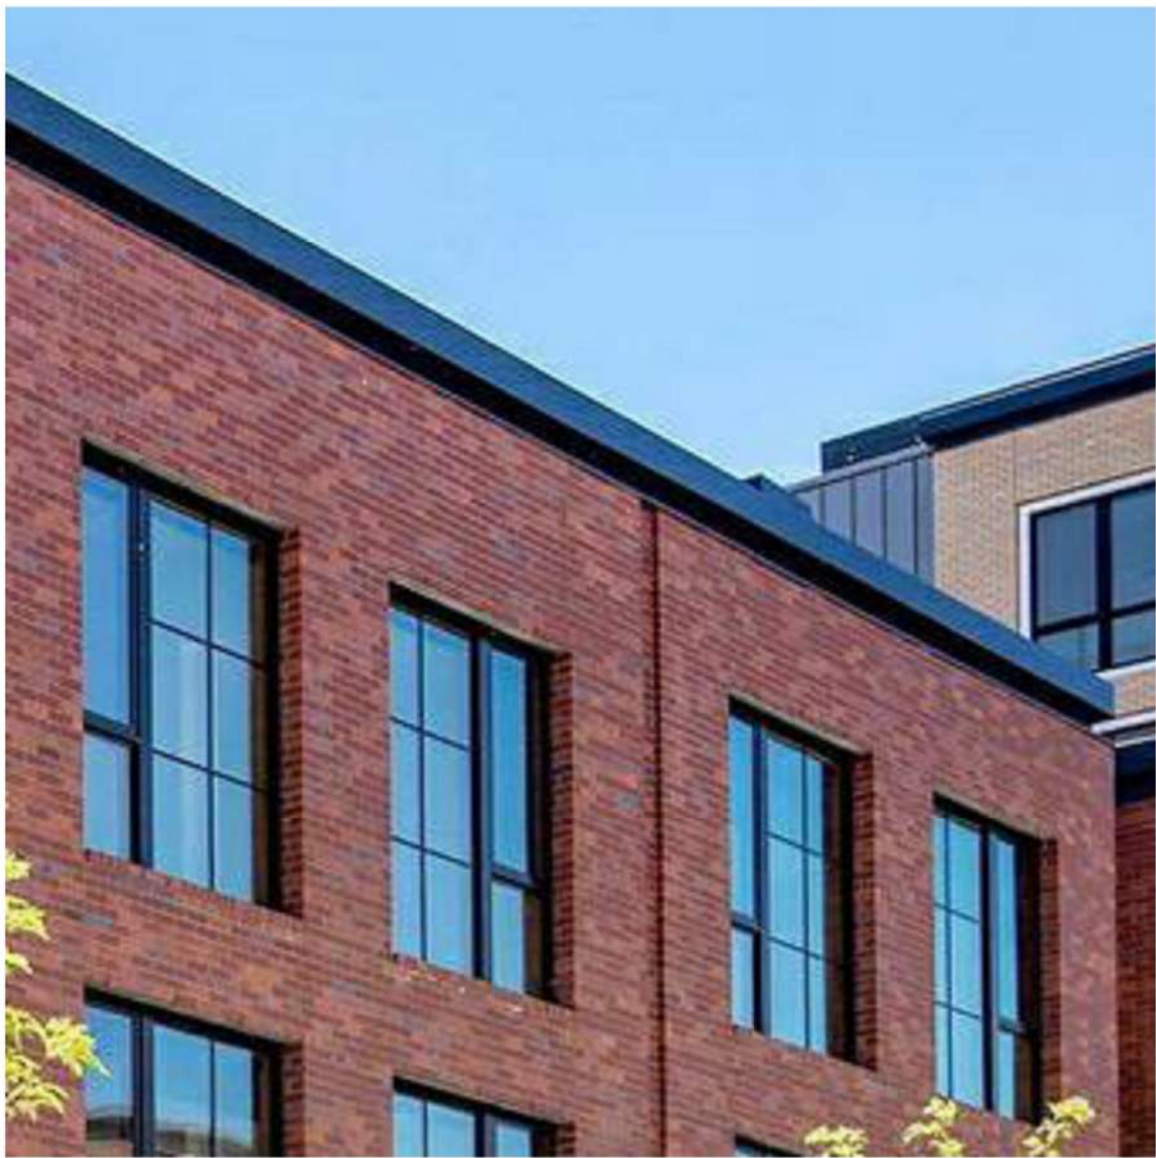

GL-4: RESIDENTIAL WINDOWS




GL-2: SPANDREL GLASS




GL-1: CLEAR GLASS



WD-1: WOOD

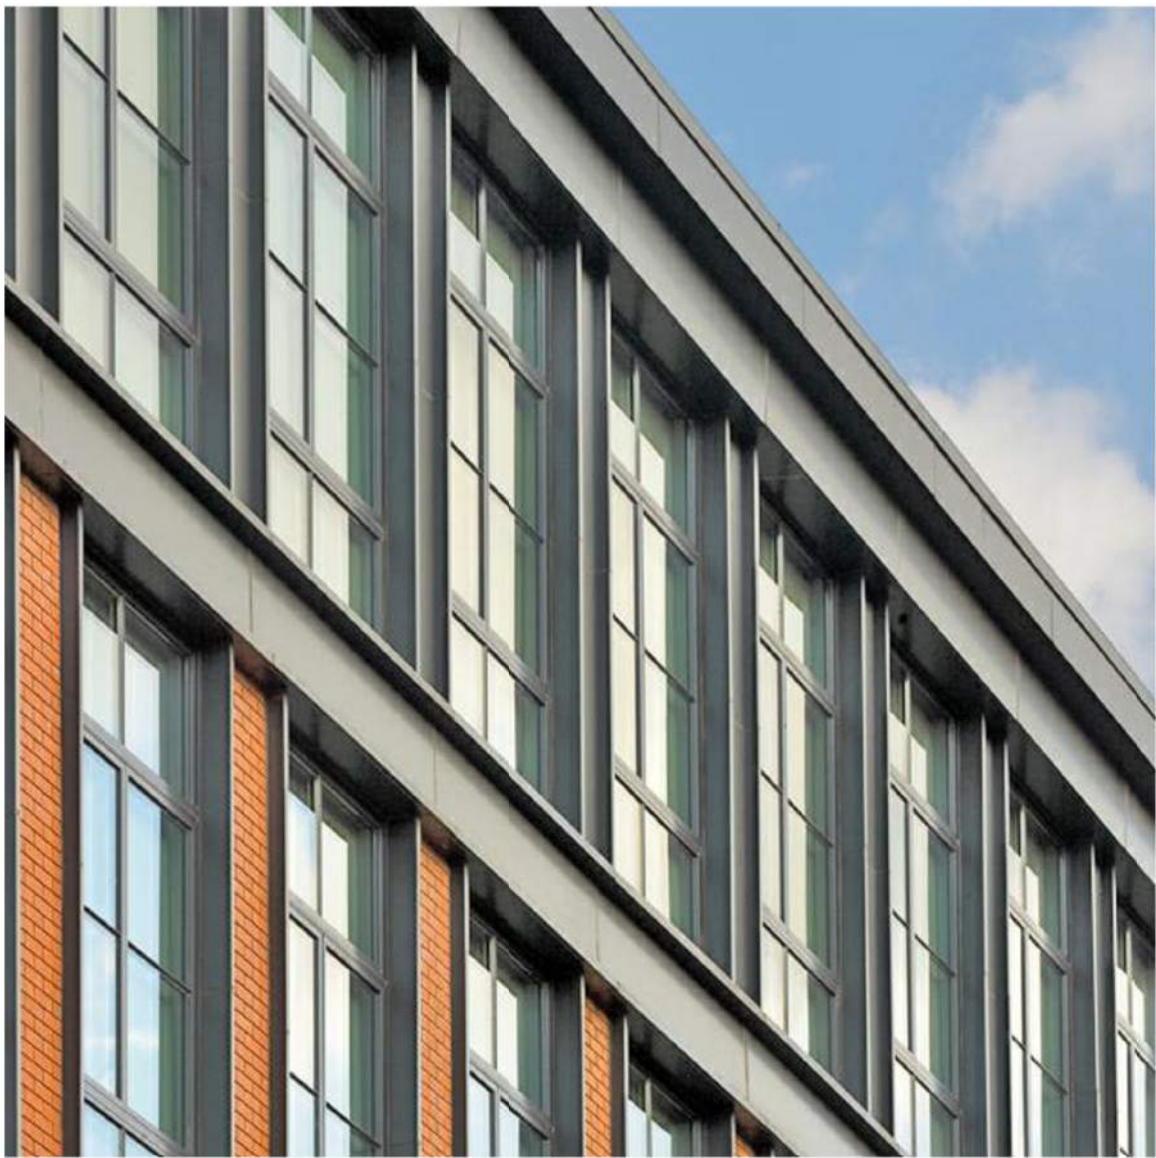


MTL-1: PAINTED ALUMINUM TRIM

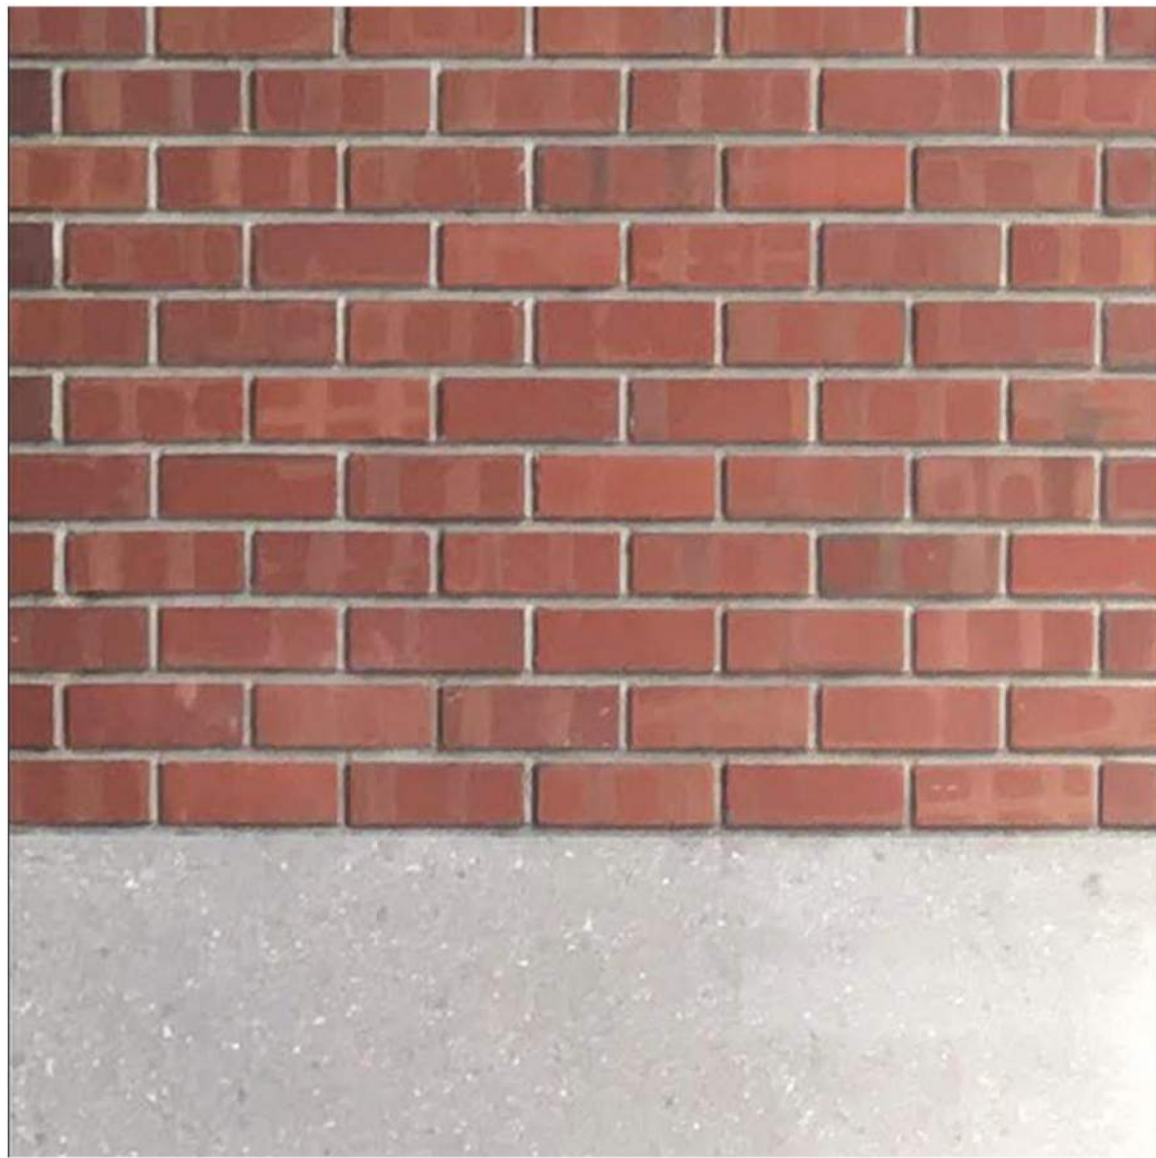

CON-1: CONCRETE BASE



MTL-2: PAINTED ALUMINUM PANELS

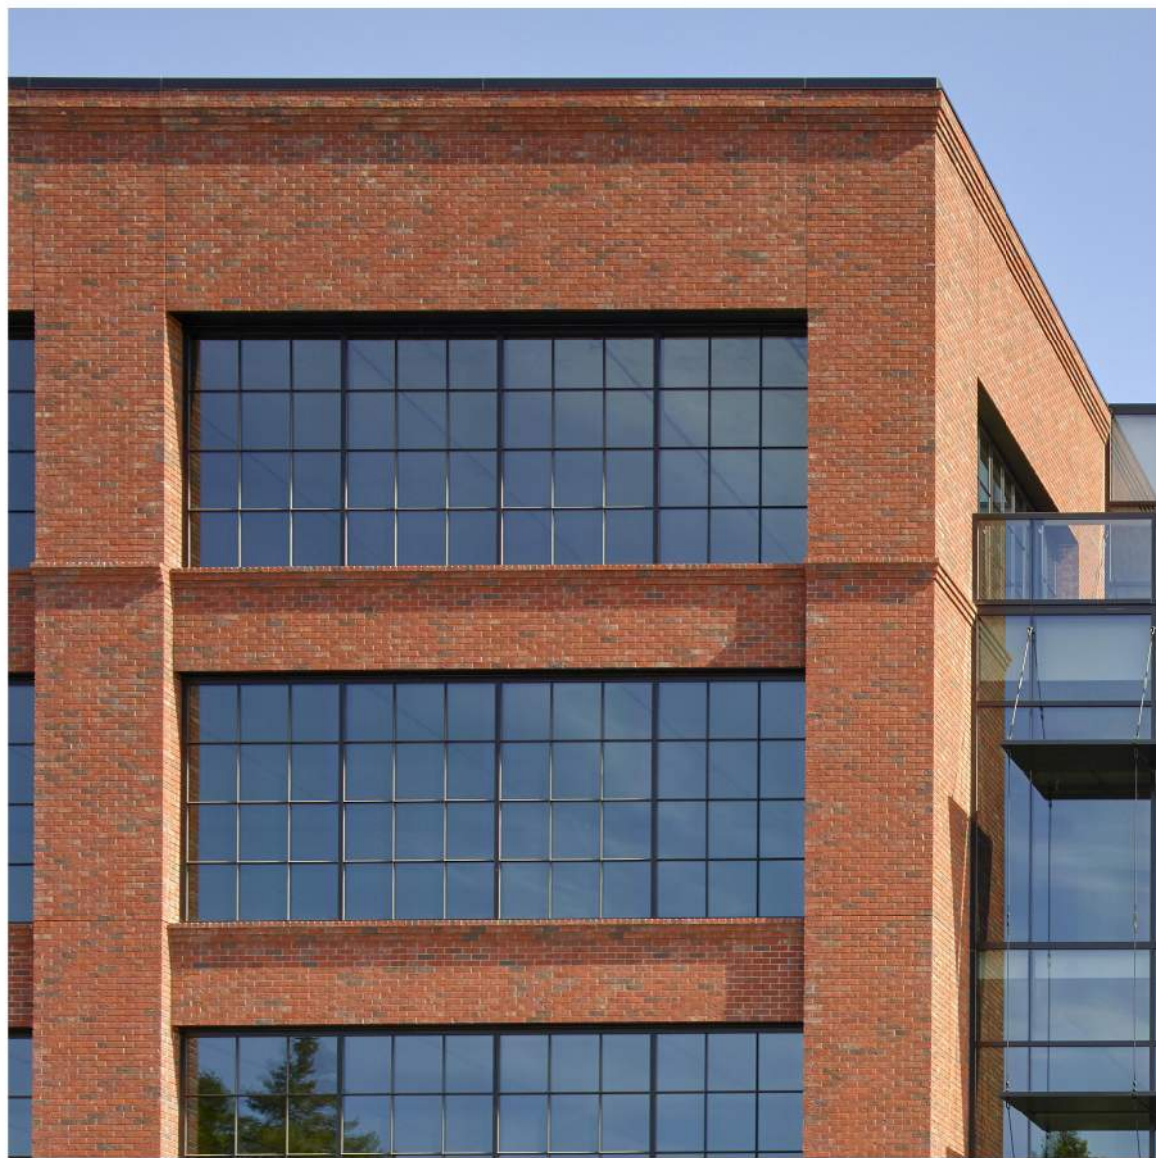

BR-1: RED BRICK

ISSUES AND REVISIONS

No.	Date	Description
A	05/05/20	Pre-Application Set
B	10/21/20	Pre-App Resubmittal
C	03/19/21	Pre-App Resubmittal


PROJECT NUMBER
16010.00

SHEET TITLE
MATERIALS


SCALE
3/16" = 1'-0"

SHEET NUMBER

A-306

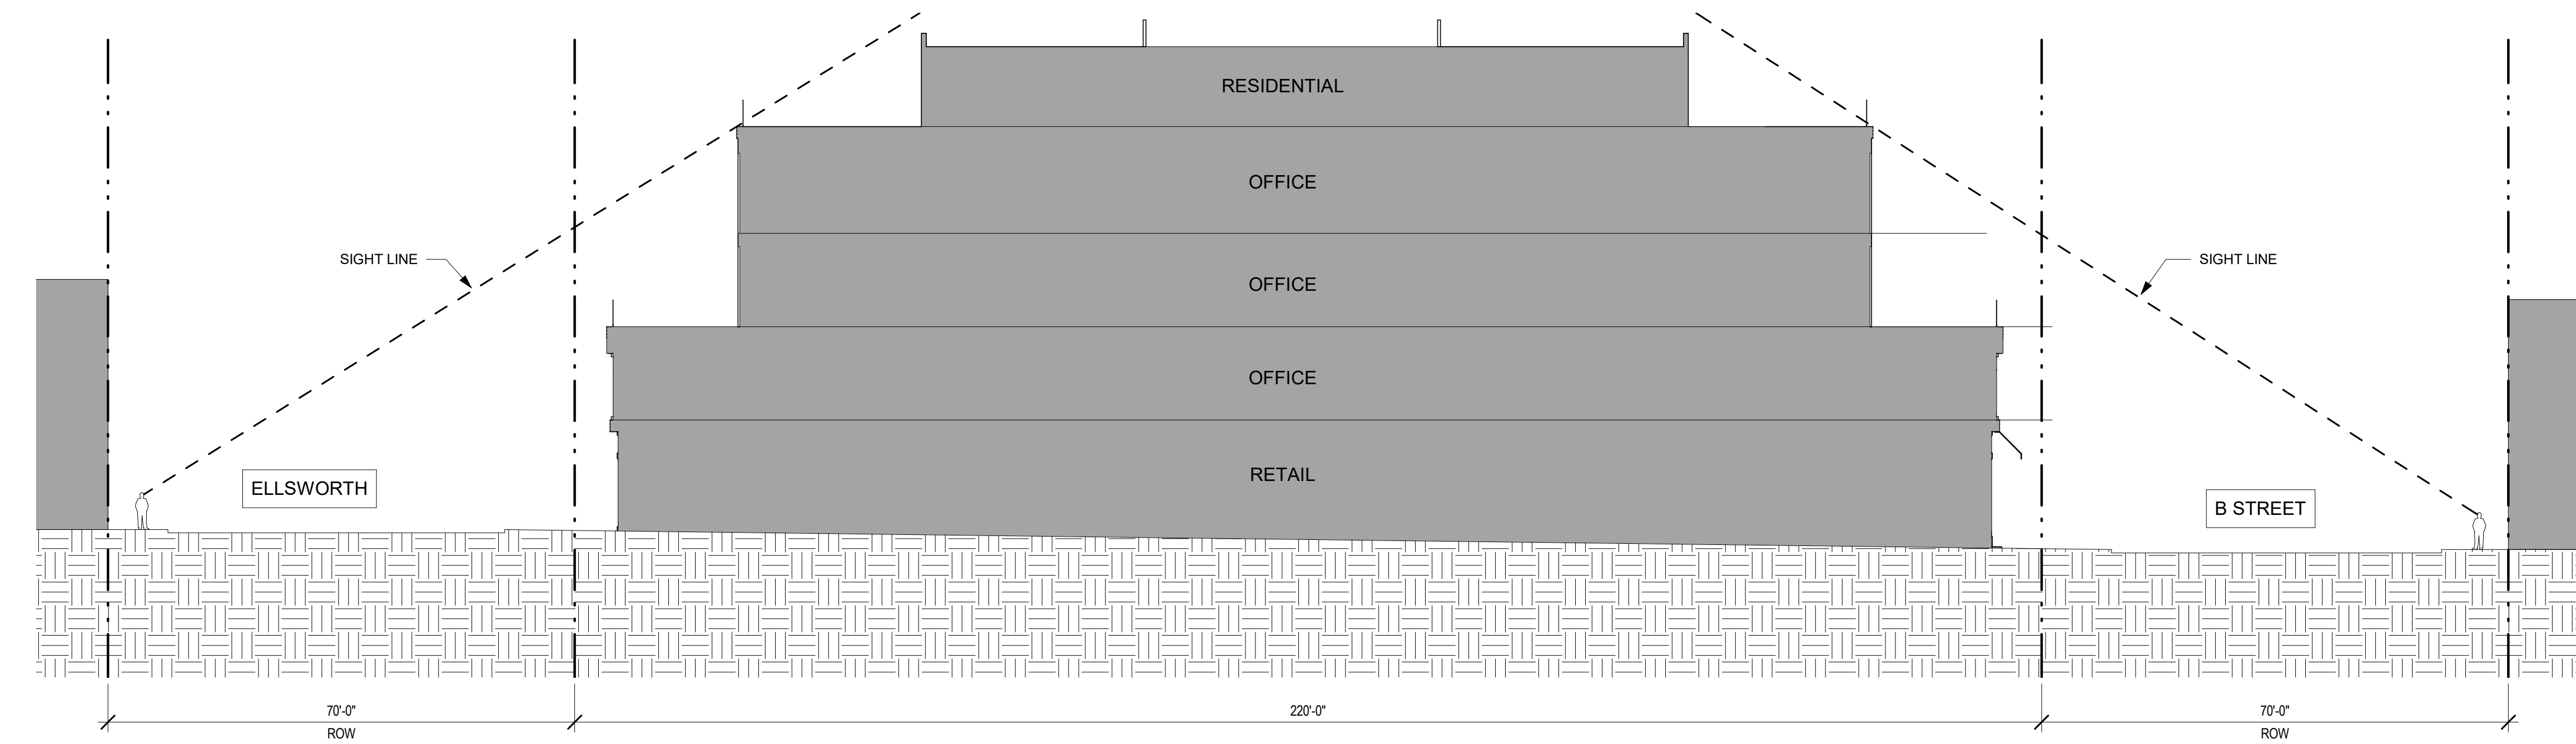

2 Site Section 2
1/16" = 1'-0"

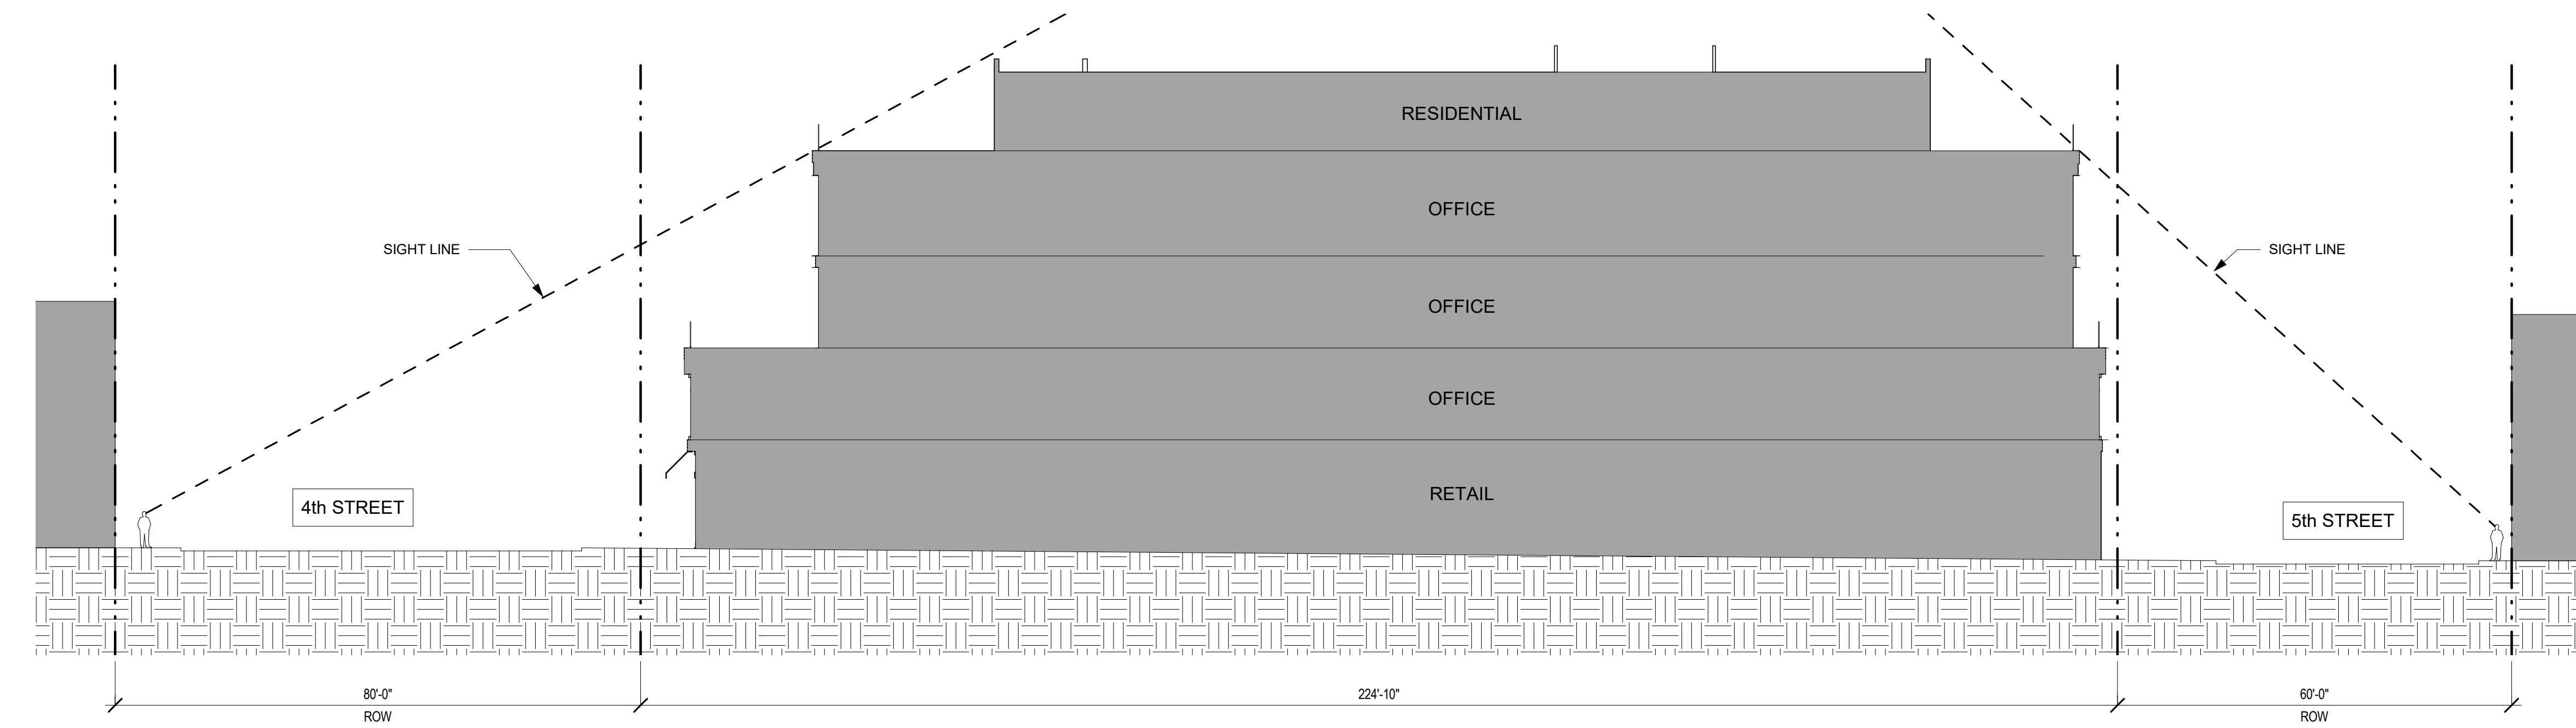

1 Site Section 1
1/16" = 1'-0"

ISSUES AND REVISIONS

No.	Date	Description
A	10/21/20	Pre-App Resubmittal
B	03/19/21	Pre-App Resubmittal

PROJECT NUMBER
16010.00

SHEET TITLE
LINE OF SIGHT DIAGRAM

SCALE
1/16" = 1'-0"

SHEET NUMBER

A-307

ISSUES AND REVISIONS

No.	Date	Description
A	05/05/20	Pre-Application Set
B	10/21/20	Pre-App Resubmittal
C	03/19/21	Pre-App Resubmittal
D	10/15/21	Planning Application Set
E	02/04/22	Planning Resubmittal
F	04/22/22	Planning Resubmittal
G	06/15/22	Planning Resubmittal

PROJECT NUMBER
16010.00

SHEET TITLE
BUILDING ELEVATIONS

SCALE
3/32" = 1'-0"

SHEET NUMBER

A-311



2 South - 5th Street
3/32" = 1'-0"



1 North - 4th Street
3/32" = 1'-0"



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KORTH SUNSERI HAGEY

ISSUES AND REVISIONS

No.	Date	Description
A	05/05/20	Pre-Application Set
B	10/21/20	Pre-App Resubmittal
C	03/19/21	Pre-App Resubmittal
D	10/15/21	Planning Application Set
E	02/04/22	Planning Resubmittal
F	04/22/22	Planning Resubmittal

PROJECT NUMBER
16010.00

SHEET TITLE
BUILDING ELEVATIONS

SCALE
3/32" = 1'-0"

SHEET NUMBER

A-312



② West - Ellsworth
3/32" = 1'-0"



① East - B Street
3/32" = 1'-0"



ISSUES AND REVISIONS

No.	Date	Description
A	05/05/20	Pre-Application Set
B	10/21/20	Pre-App Resubmittal
C	03/19/21	Pre-App Resubmittal
D	02/04/22	Planning Resubmittal


PROJECT NUMBER
16010.00

SHEET TITLE
BUILDING SECTIONS


SCALE
1/16" = 1'-0"

SHEET NUMBER

A-321

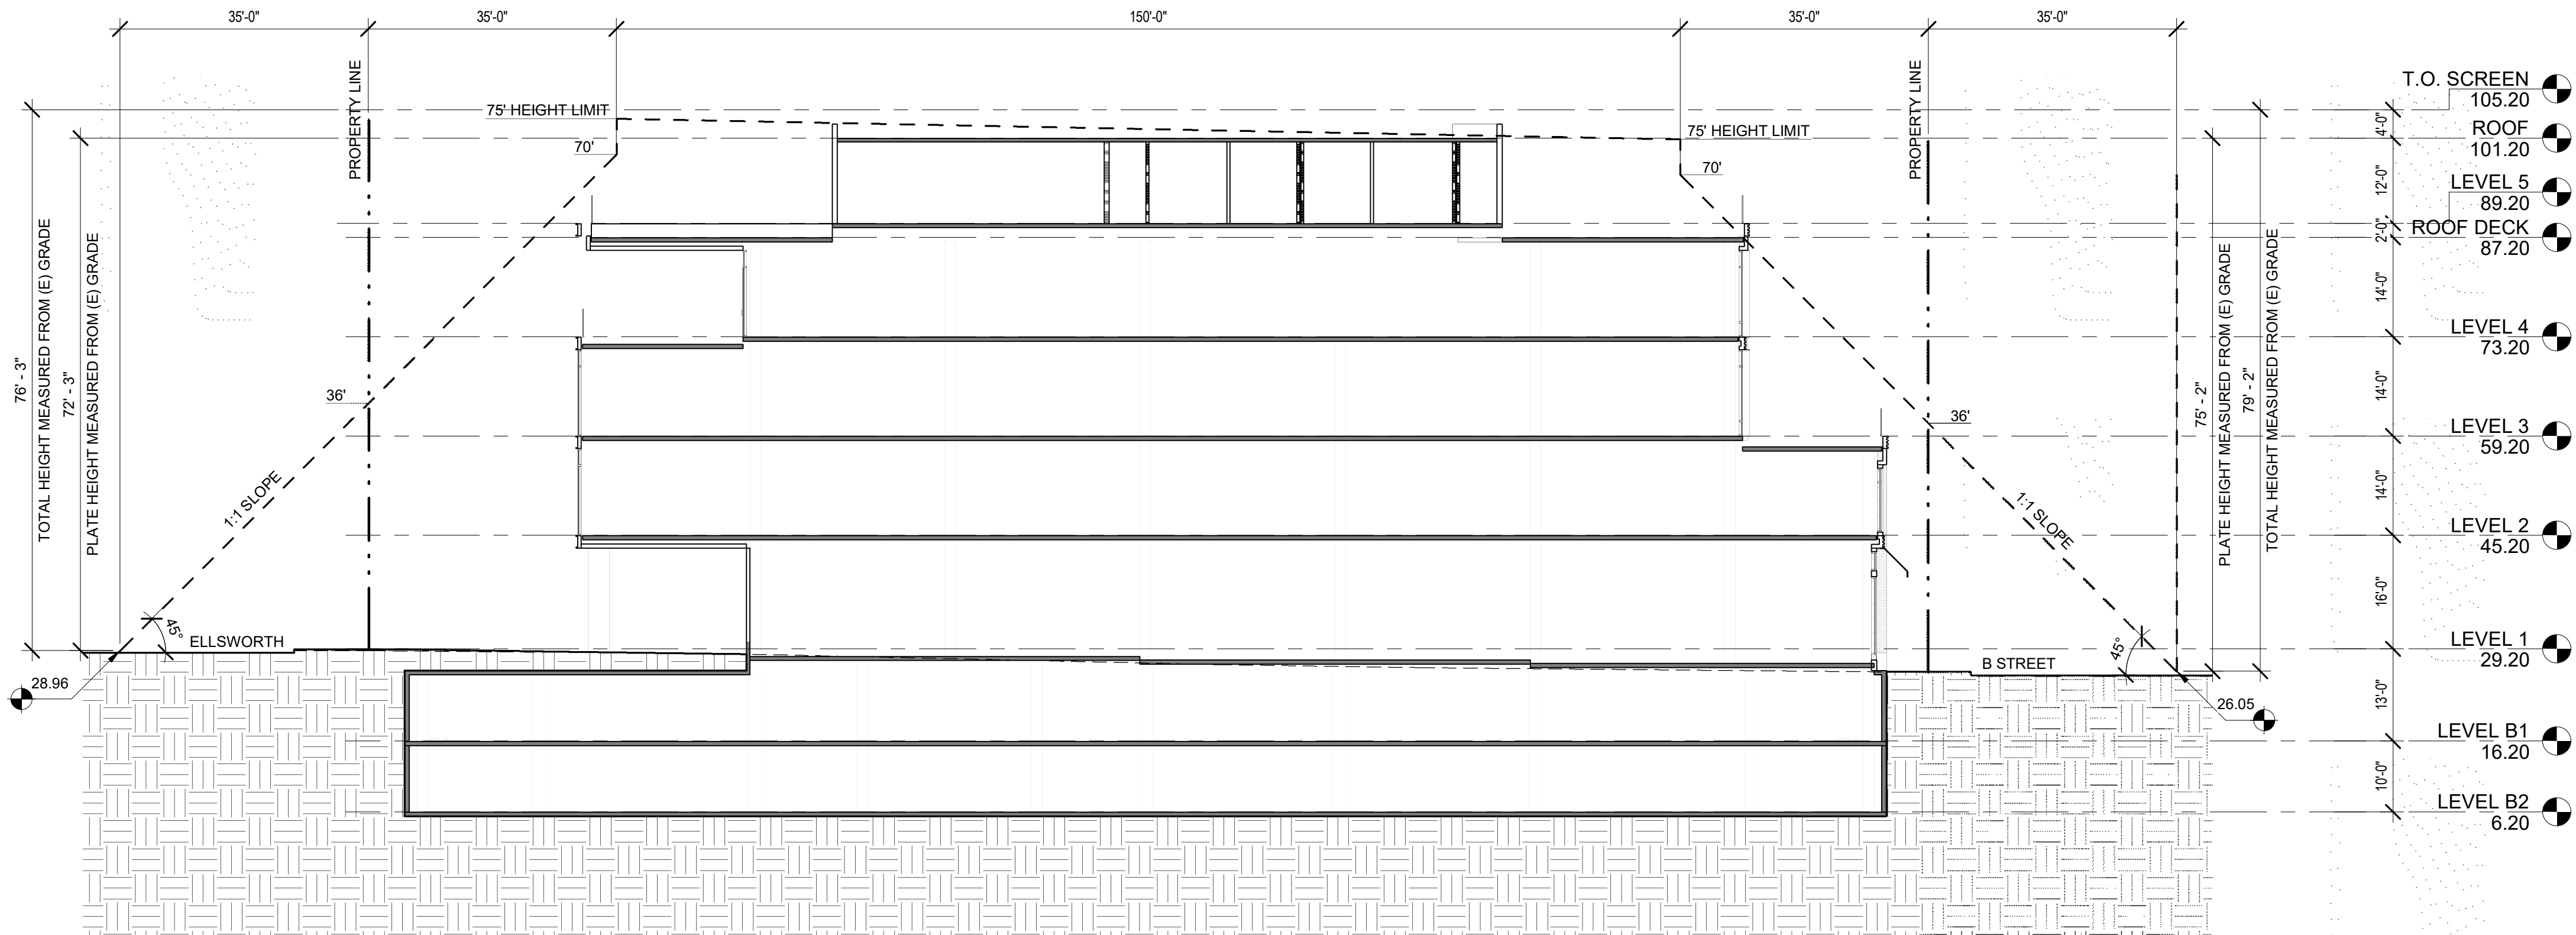

Section 2
1/16" = 1'-0"

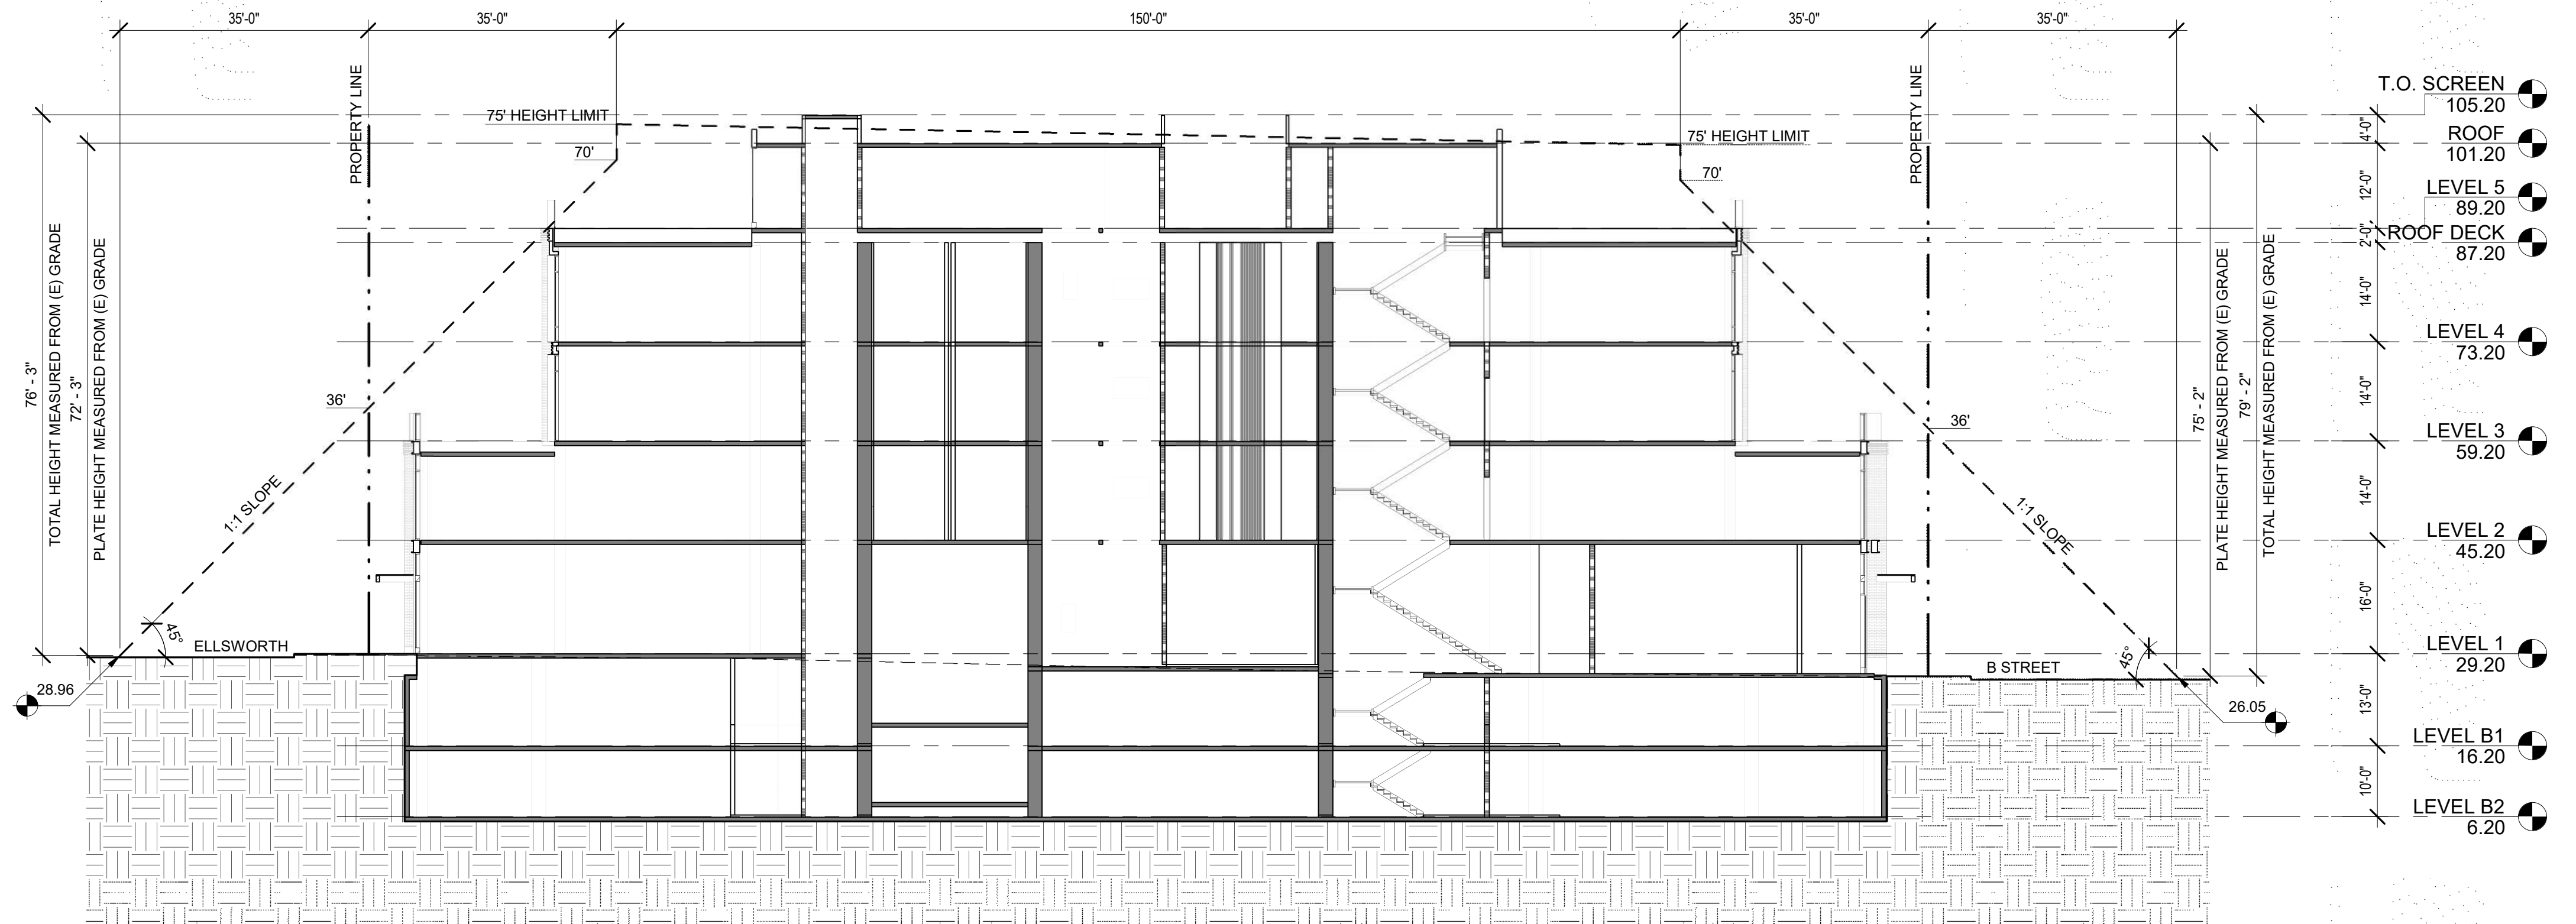

Section 1
1/16" = 1'-0"



ISSUES AND REVISIONS

No.	Date	Description
A	05/05/20	Pre-Application Set
B	10/21/20	Pre-App Resubmittal
C	03/19/21	Pre-App Resubmittal
D	02/04/22	Planning Resubmittal


PROJECT NUMBER
16010.00

SHEET TITLE
BUILDING SECTIONS


SCALE
1/16" = 1'-0"

SHEET NUMBER

A-322

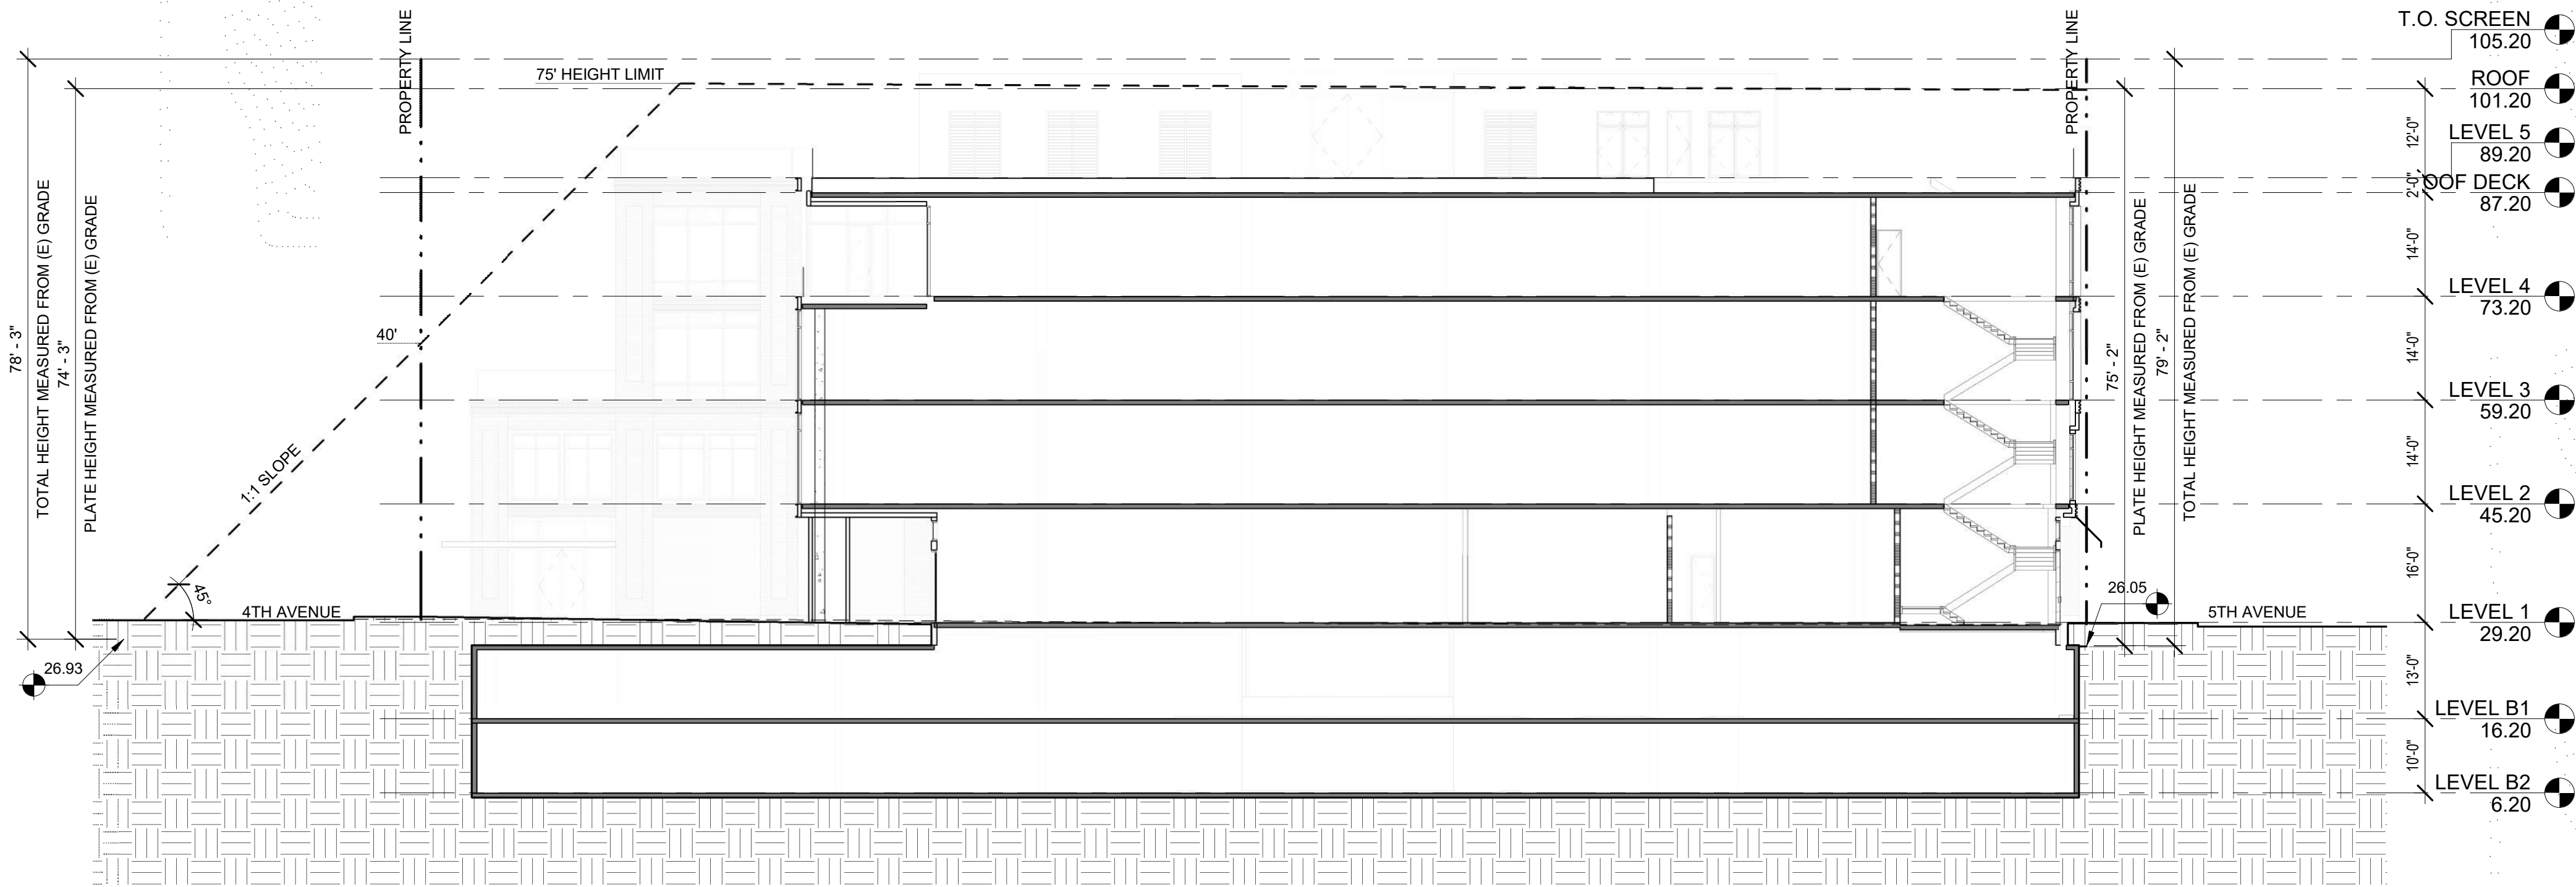

② Section 4
1/16" = 1'-0"

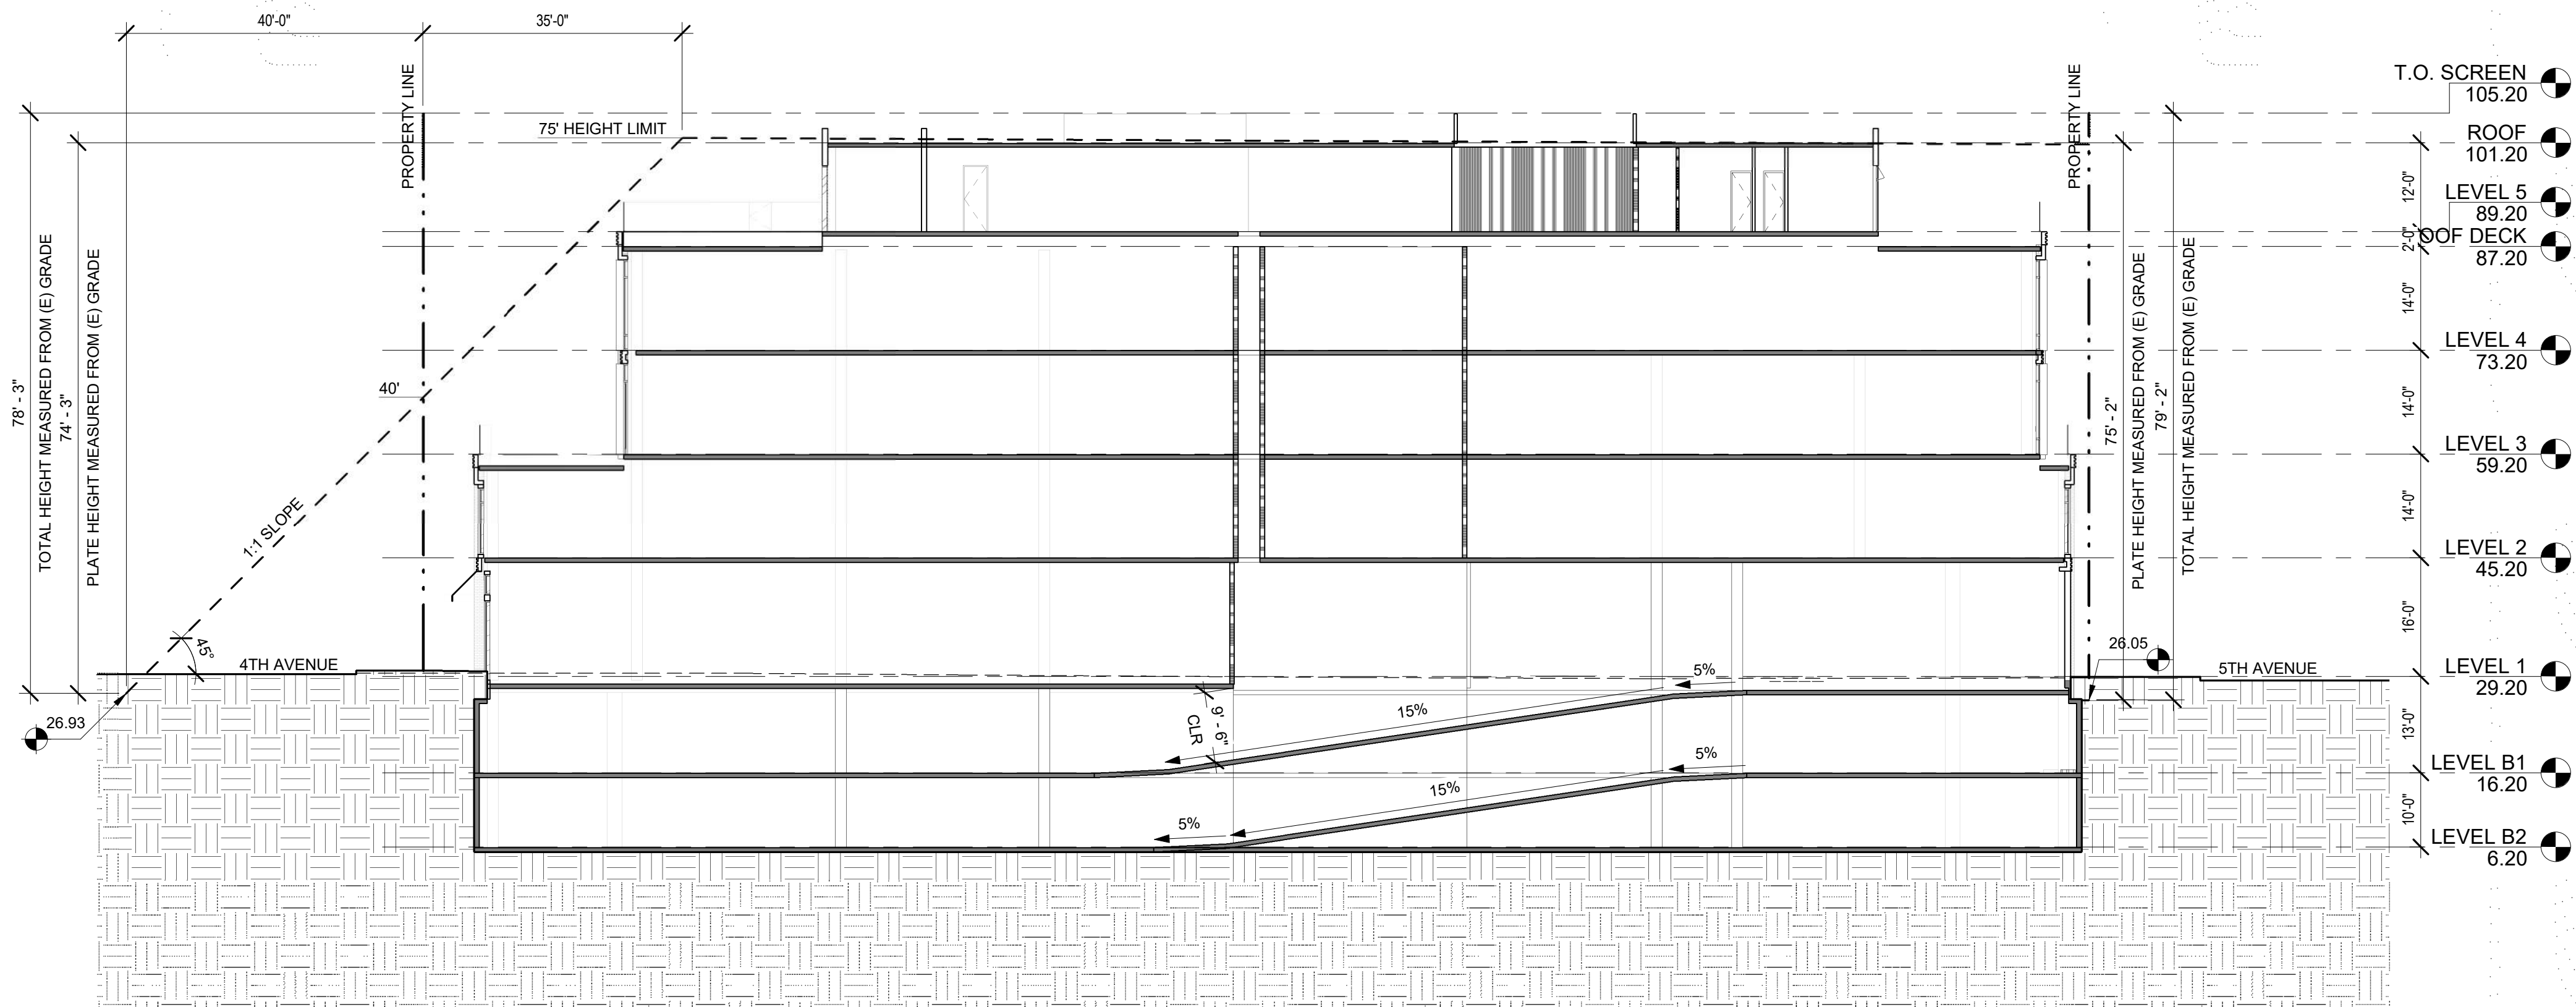

① Section 3
1/16" = 1'-0"



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ISSUES AND REVISIONS

No.	Date	Description
A	03/19/21	Pre-App Resubmittal
B	04/22/22	Planning Resubmittal







PROJECT NUMBER
16010.00



SHEET TITLE
ENLARGED ELEVATIONS AND
SECTIONS

SCALE
As indicated

SHEET NUMBER

A-401

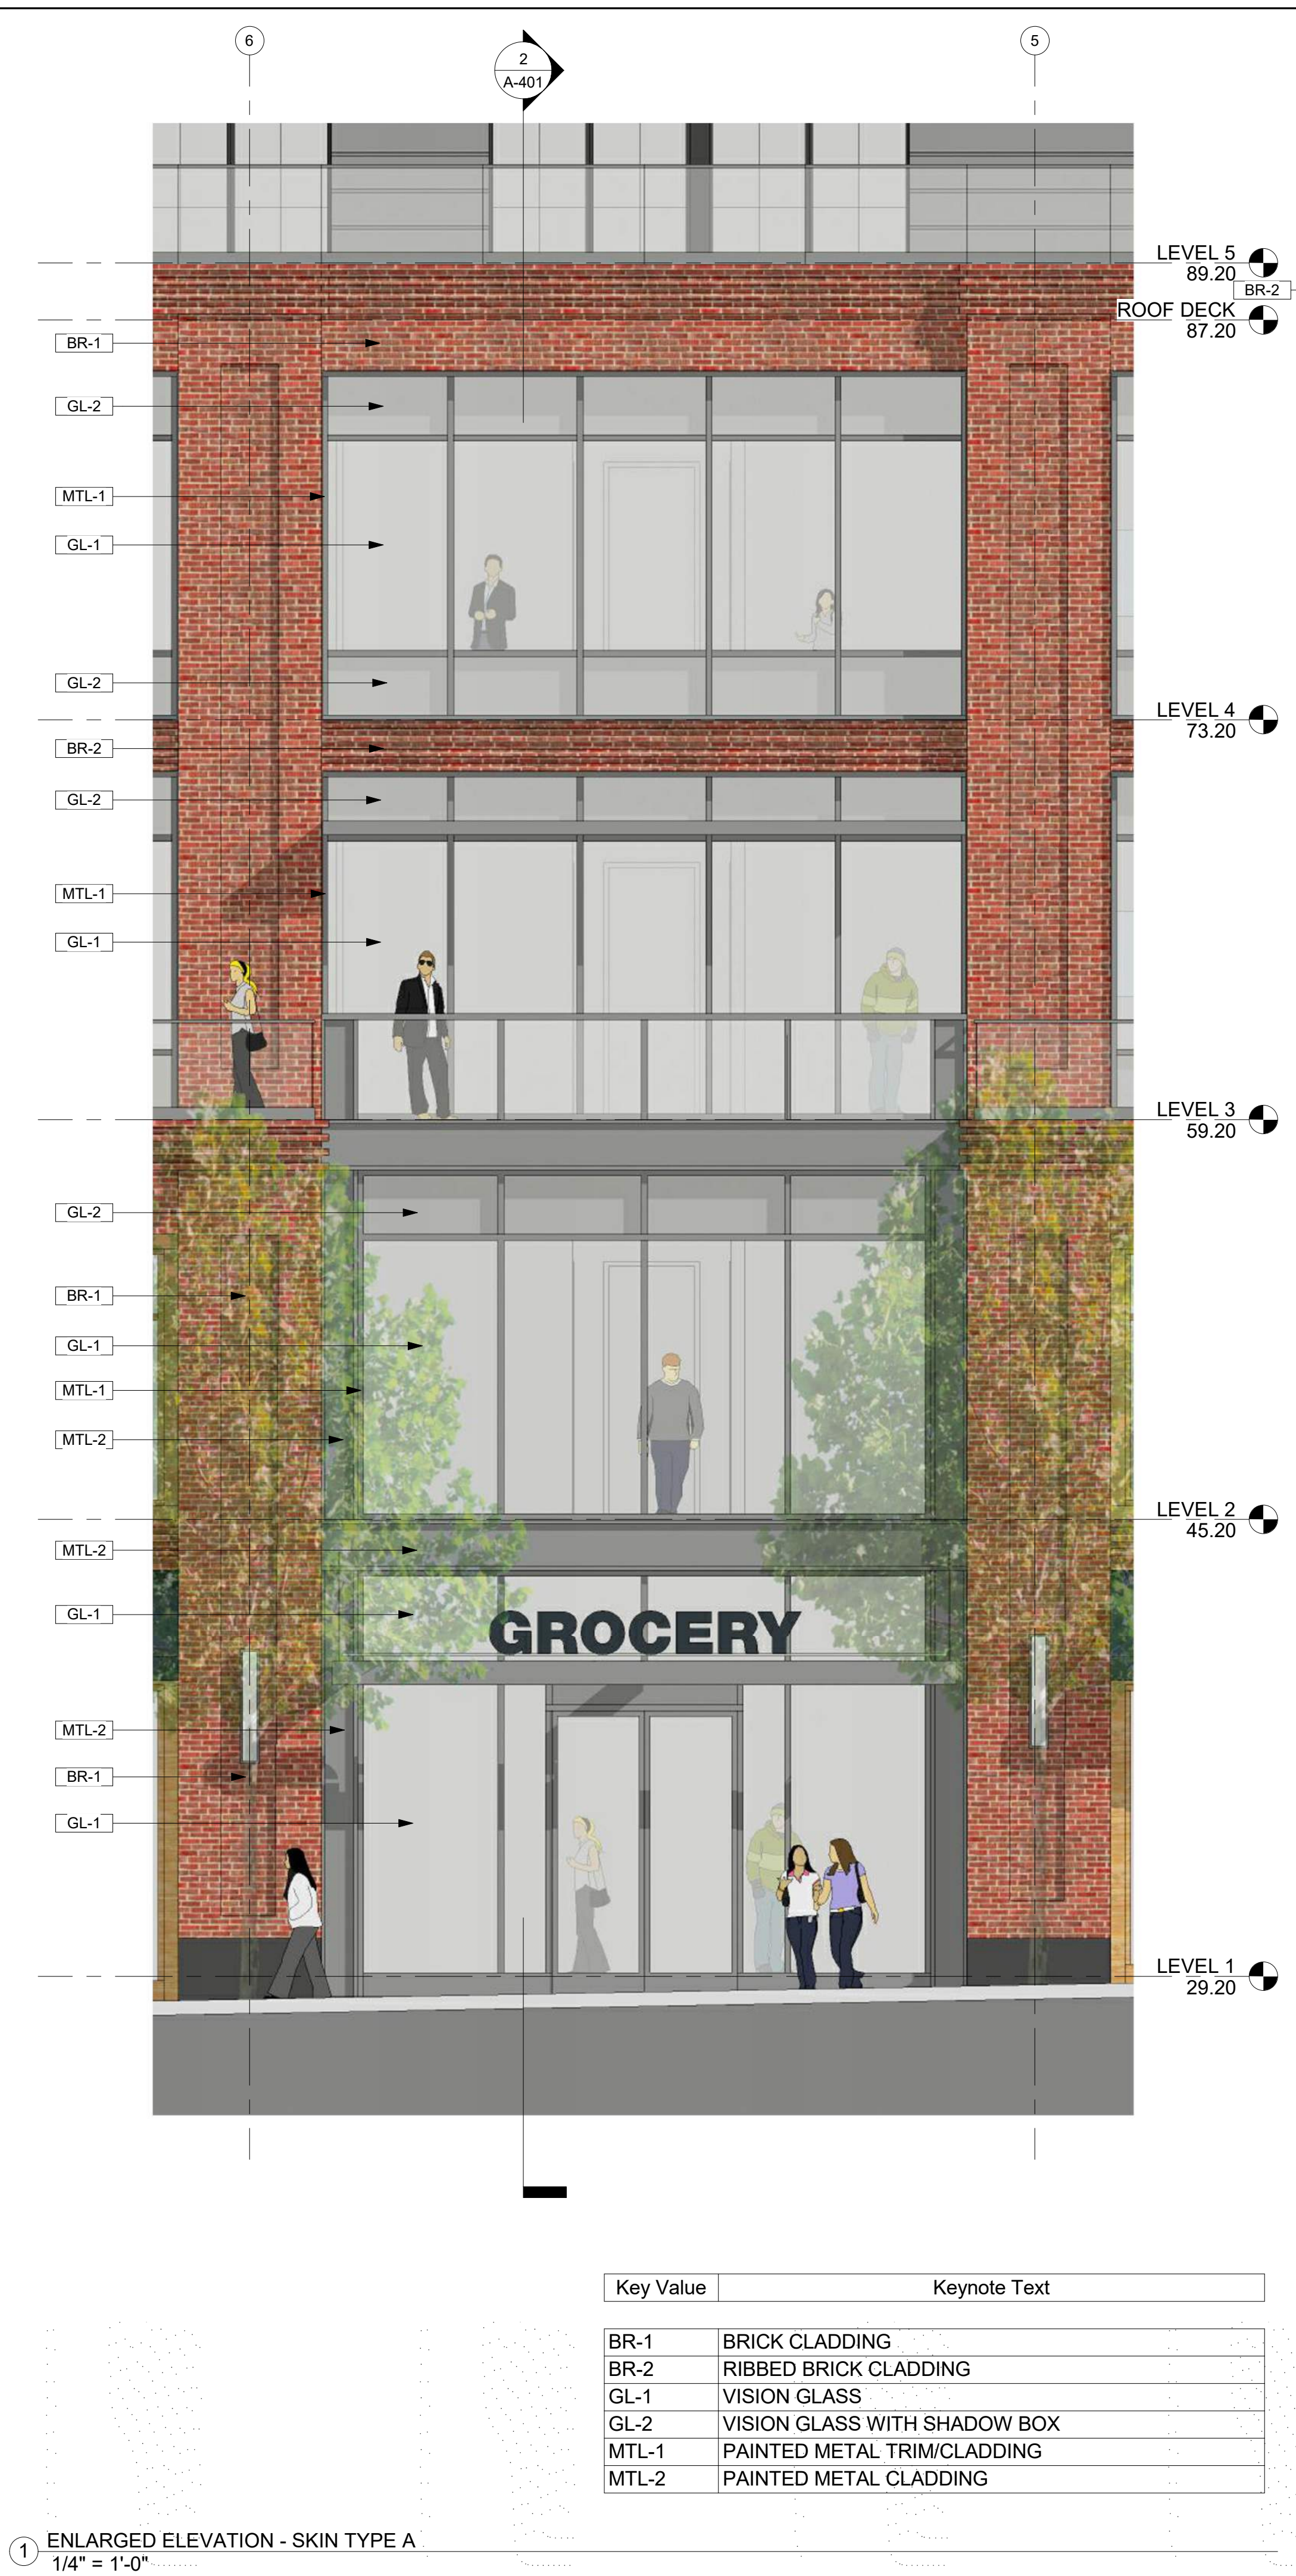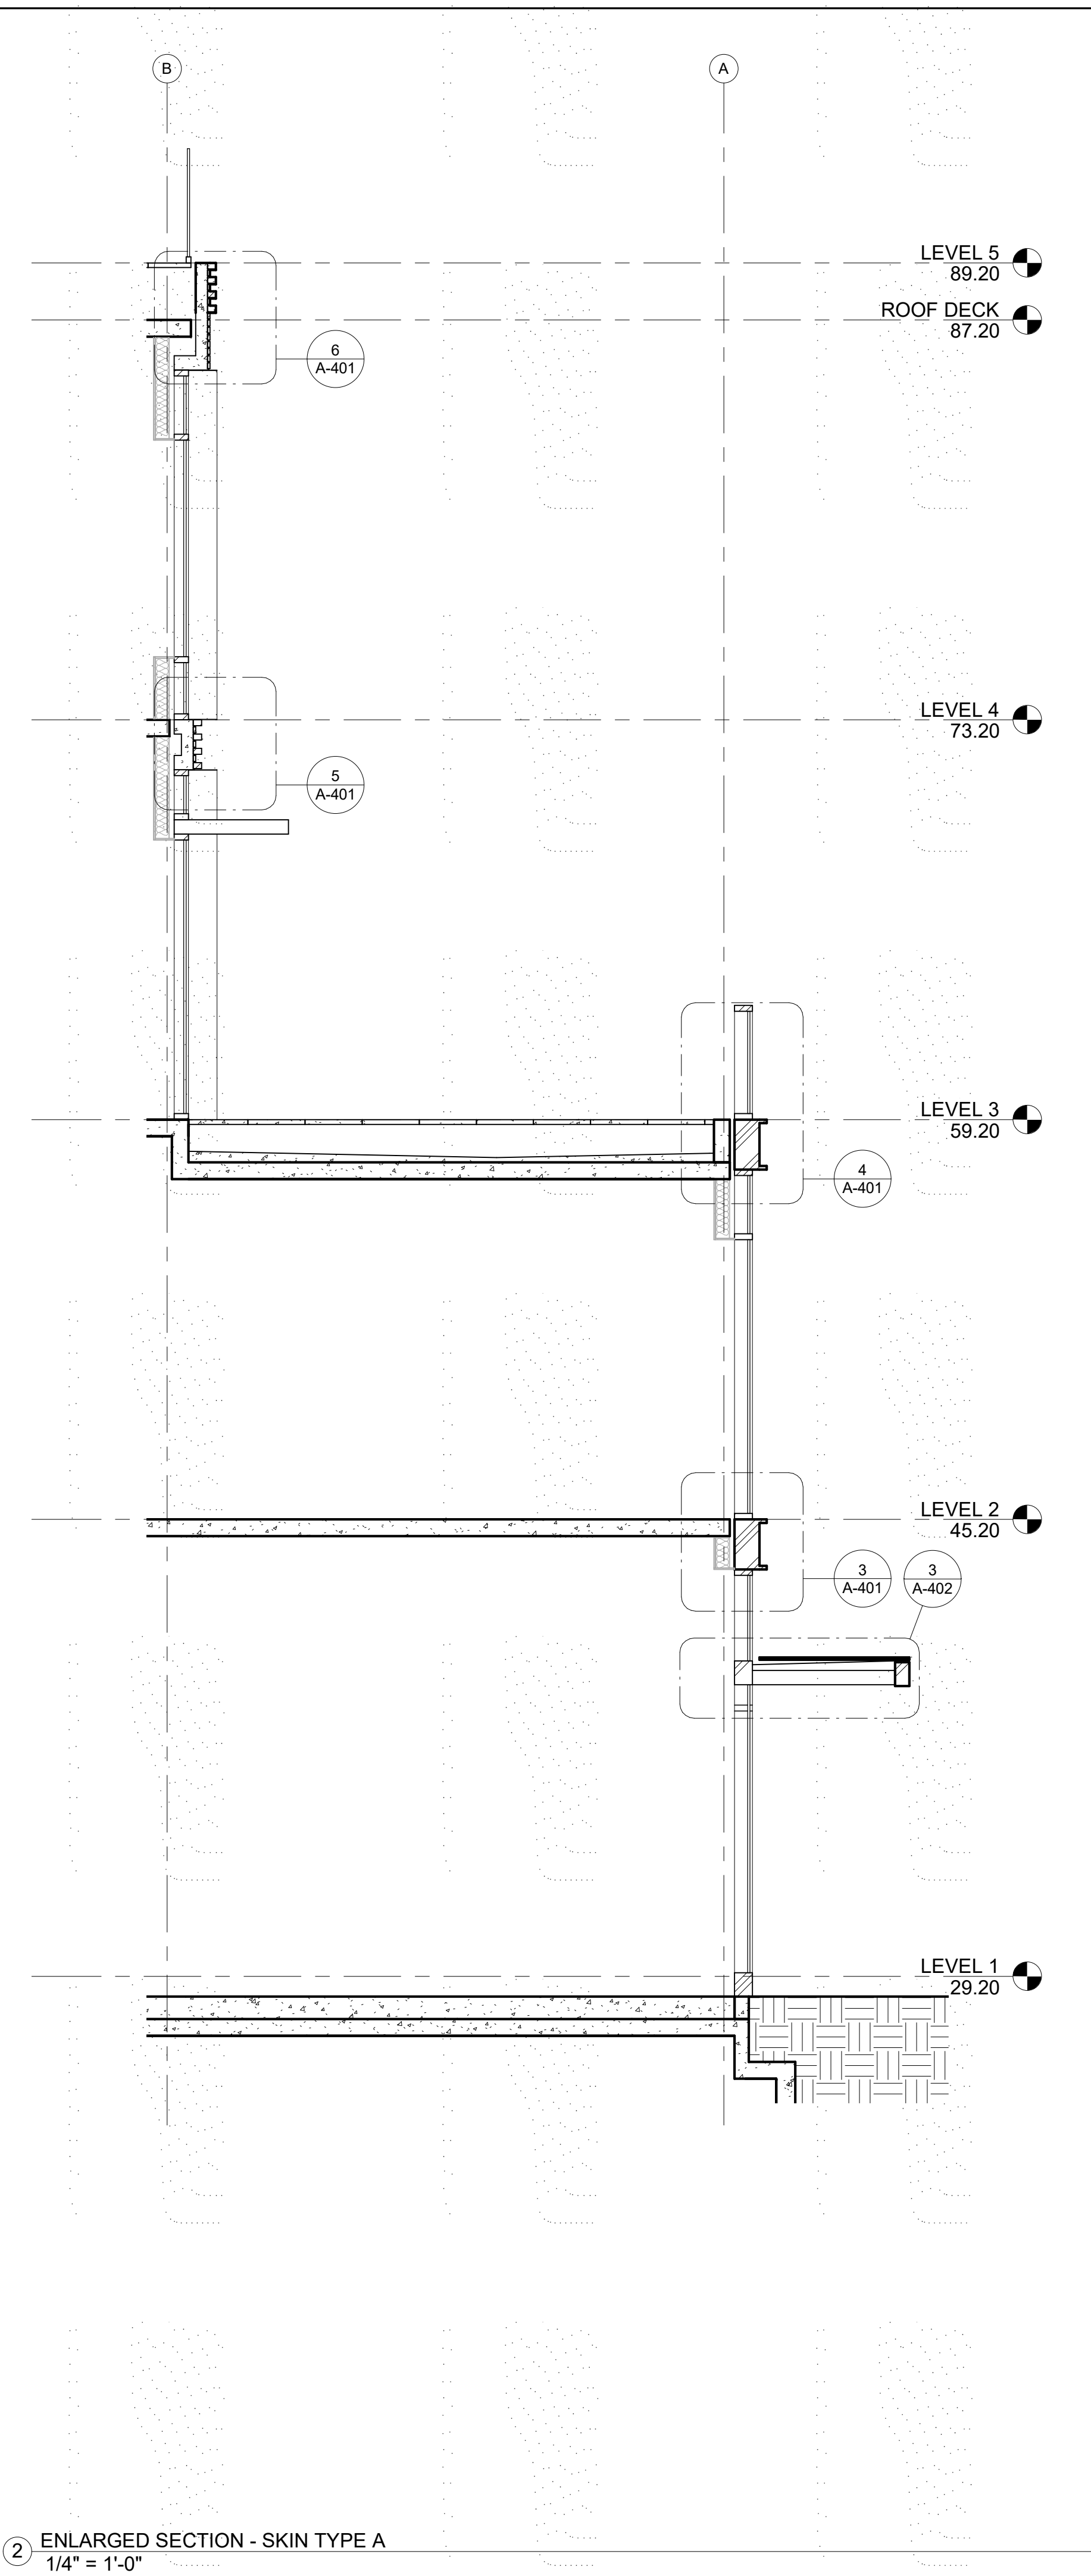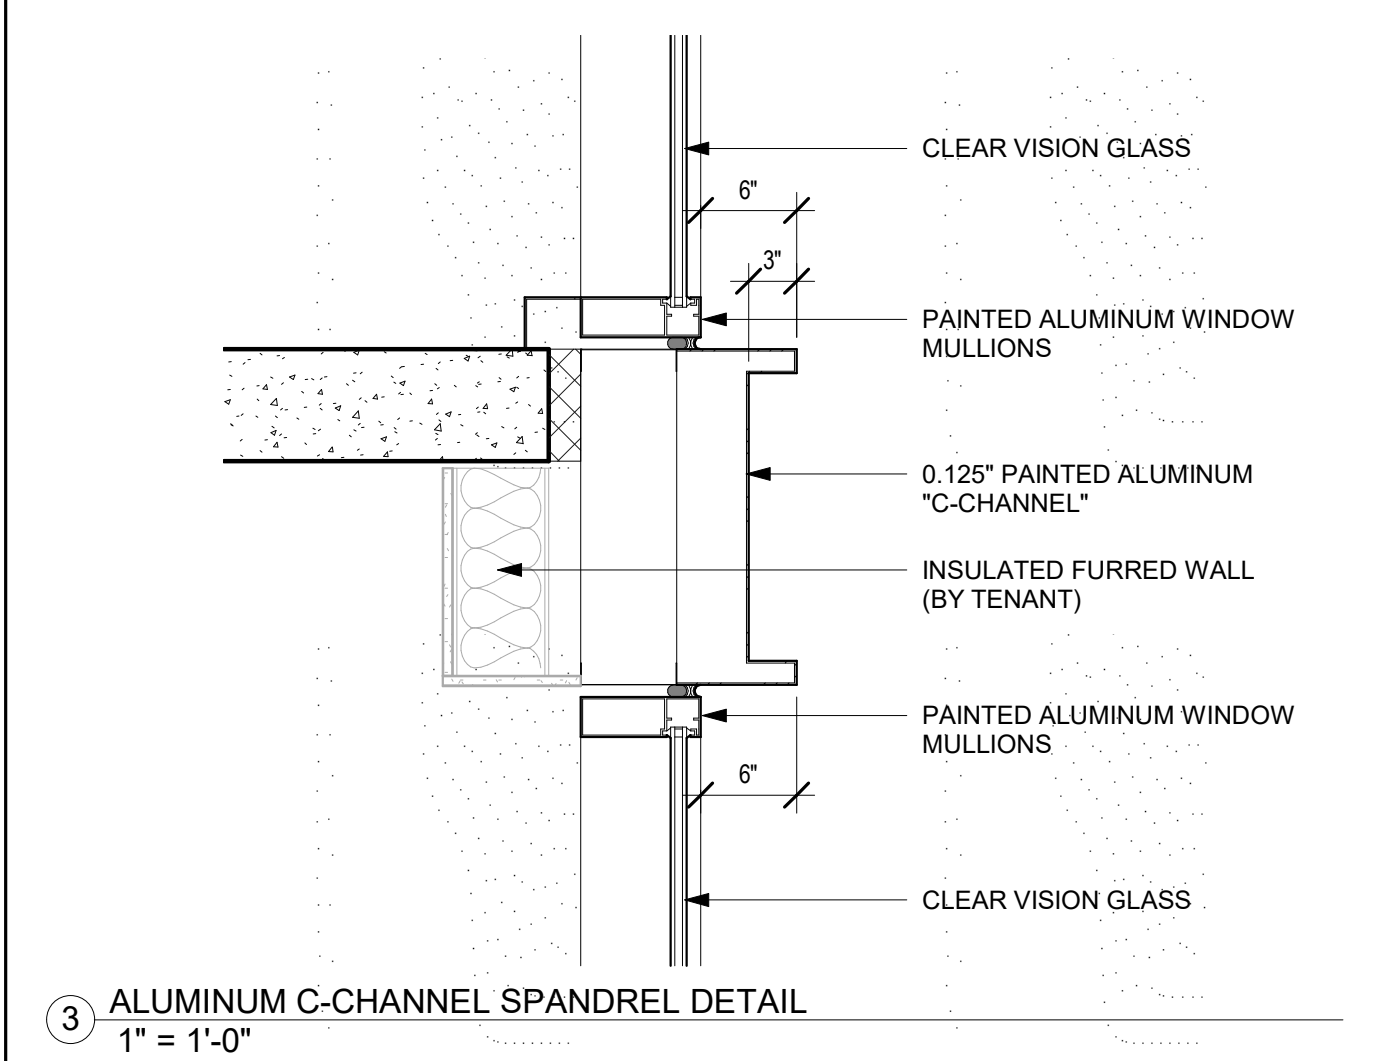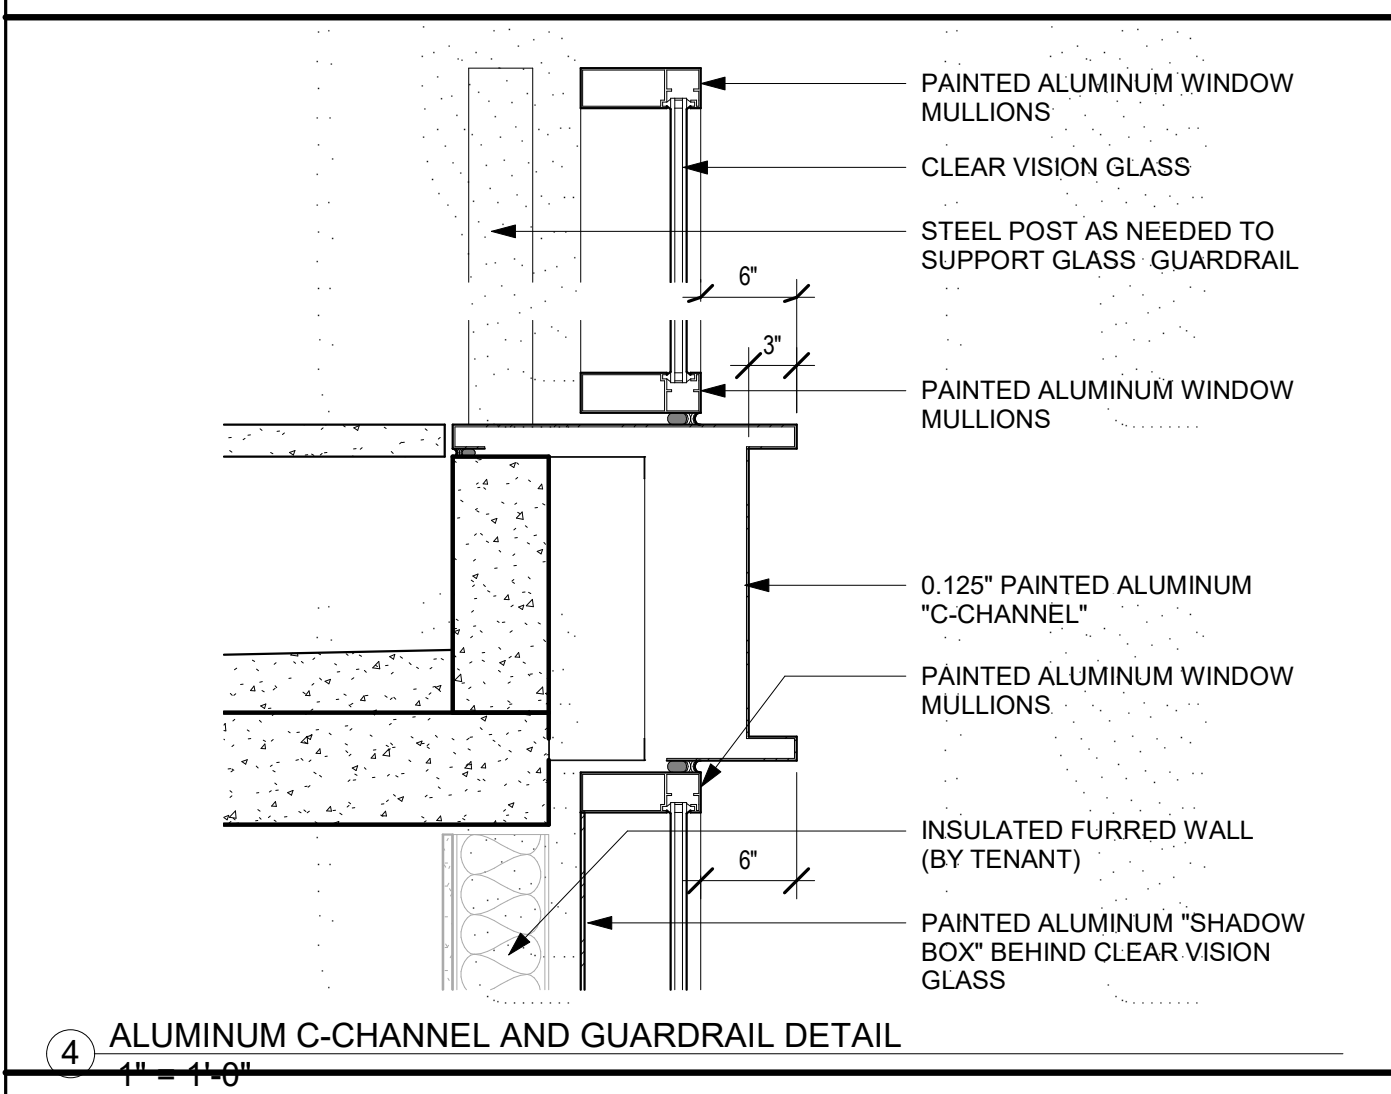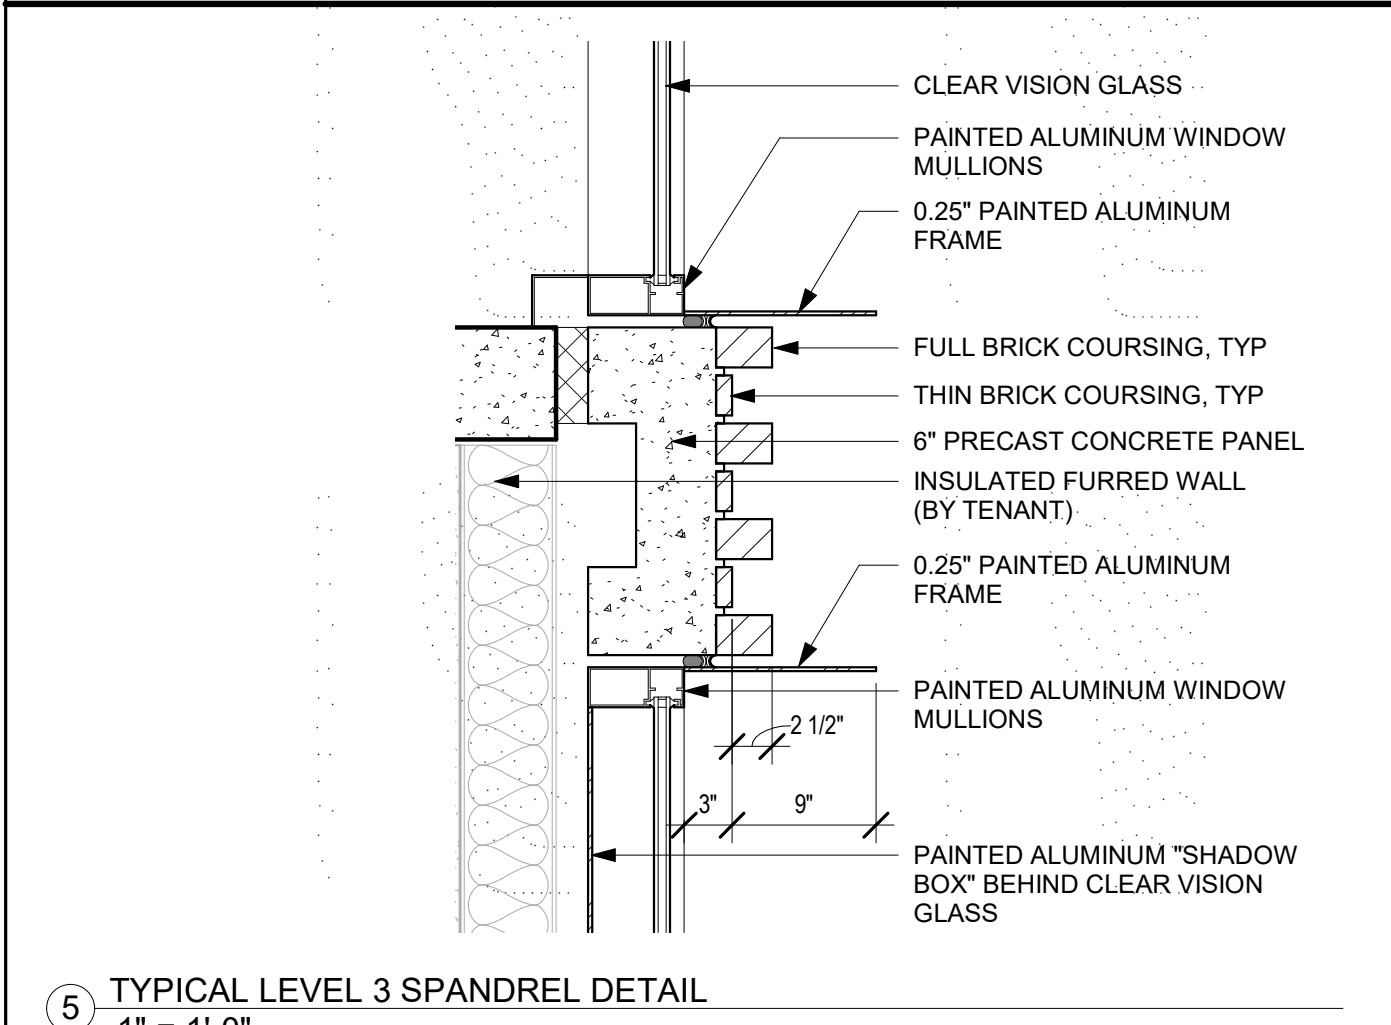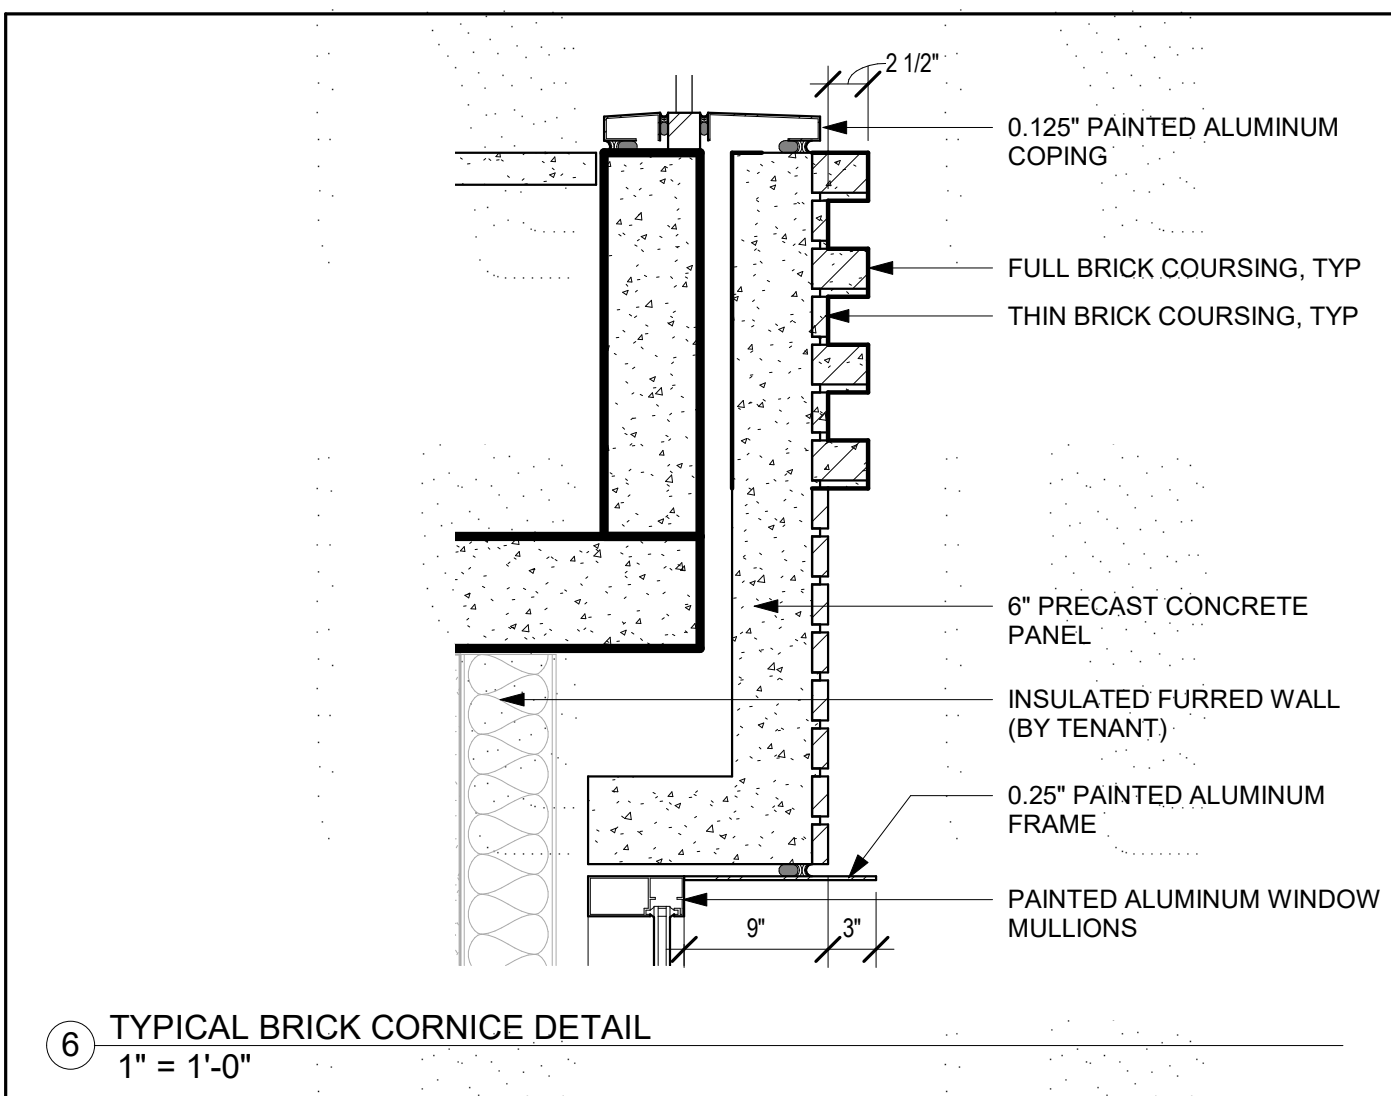

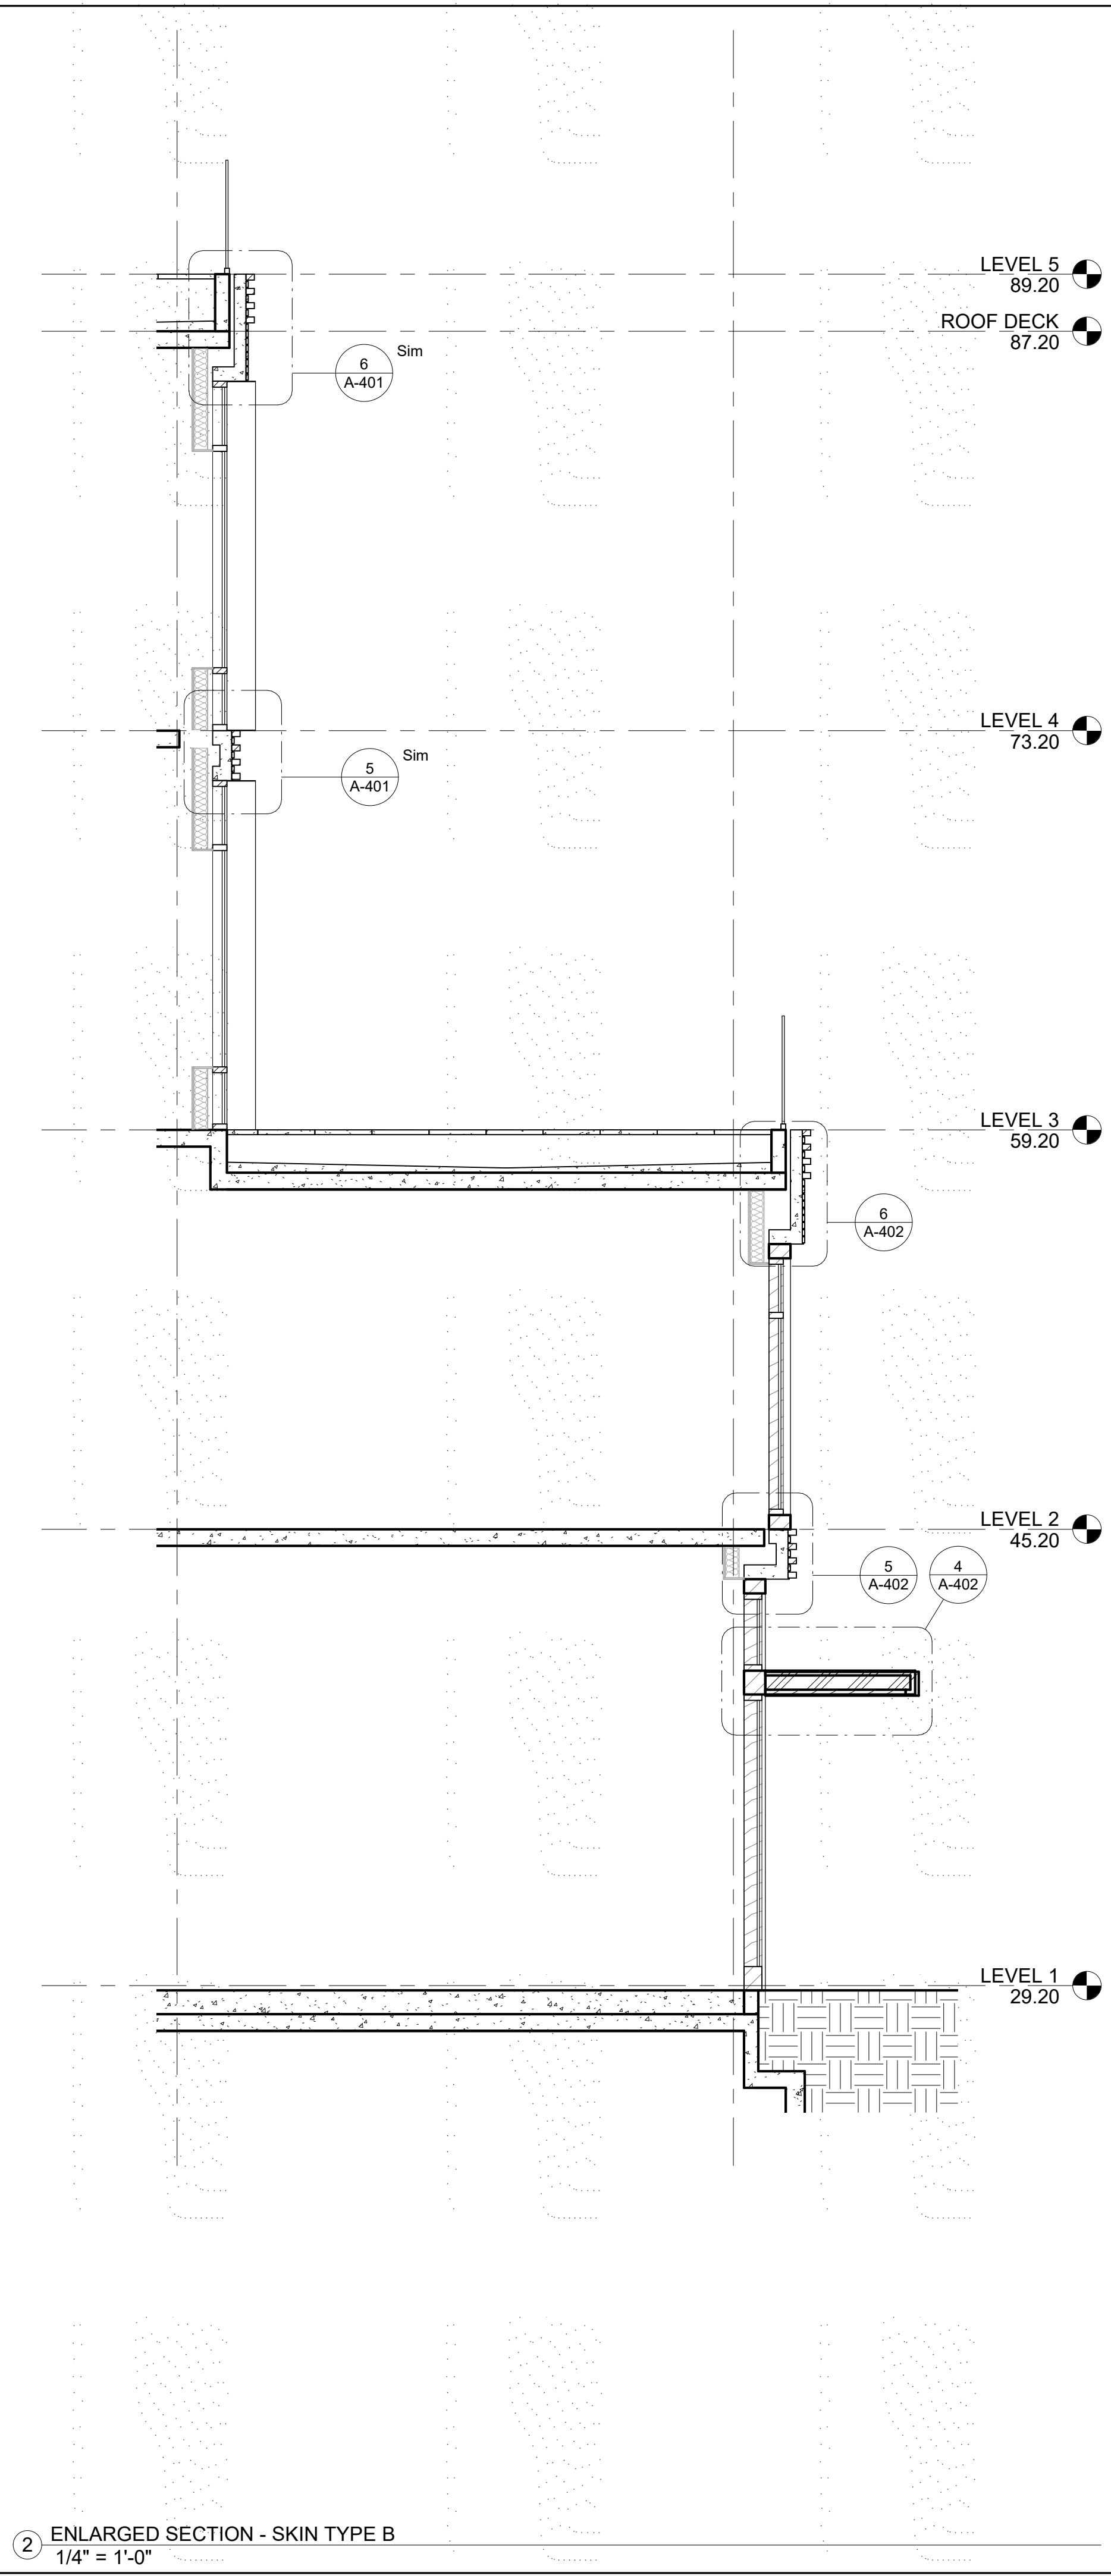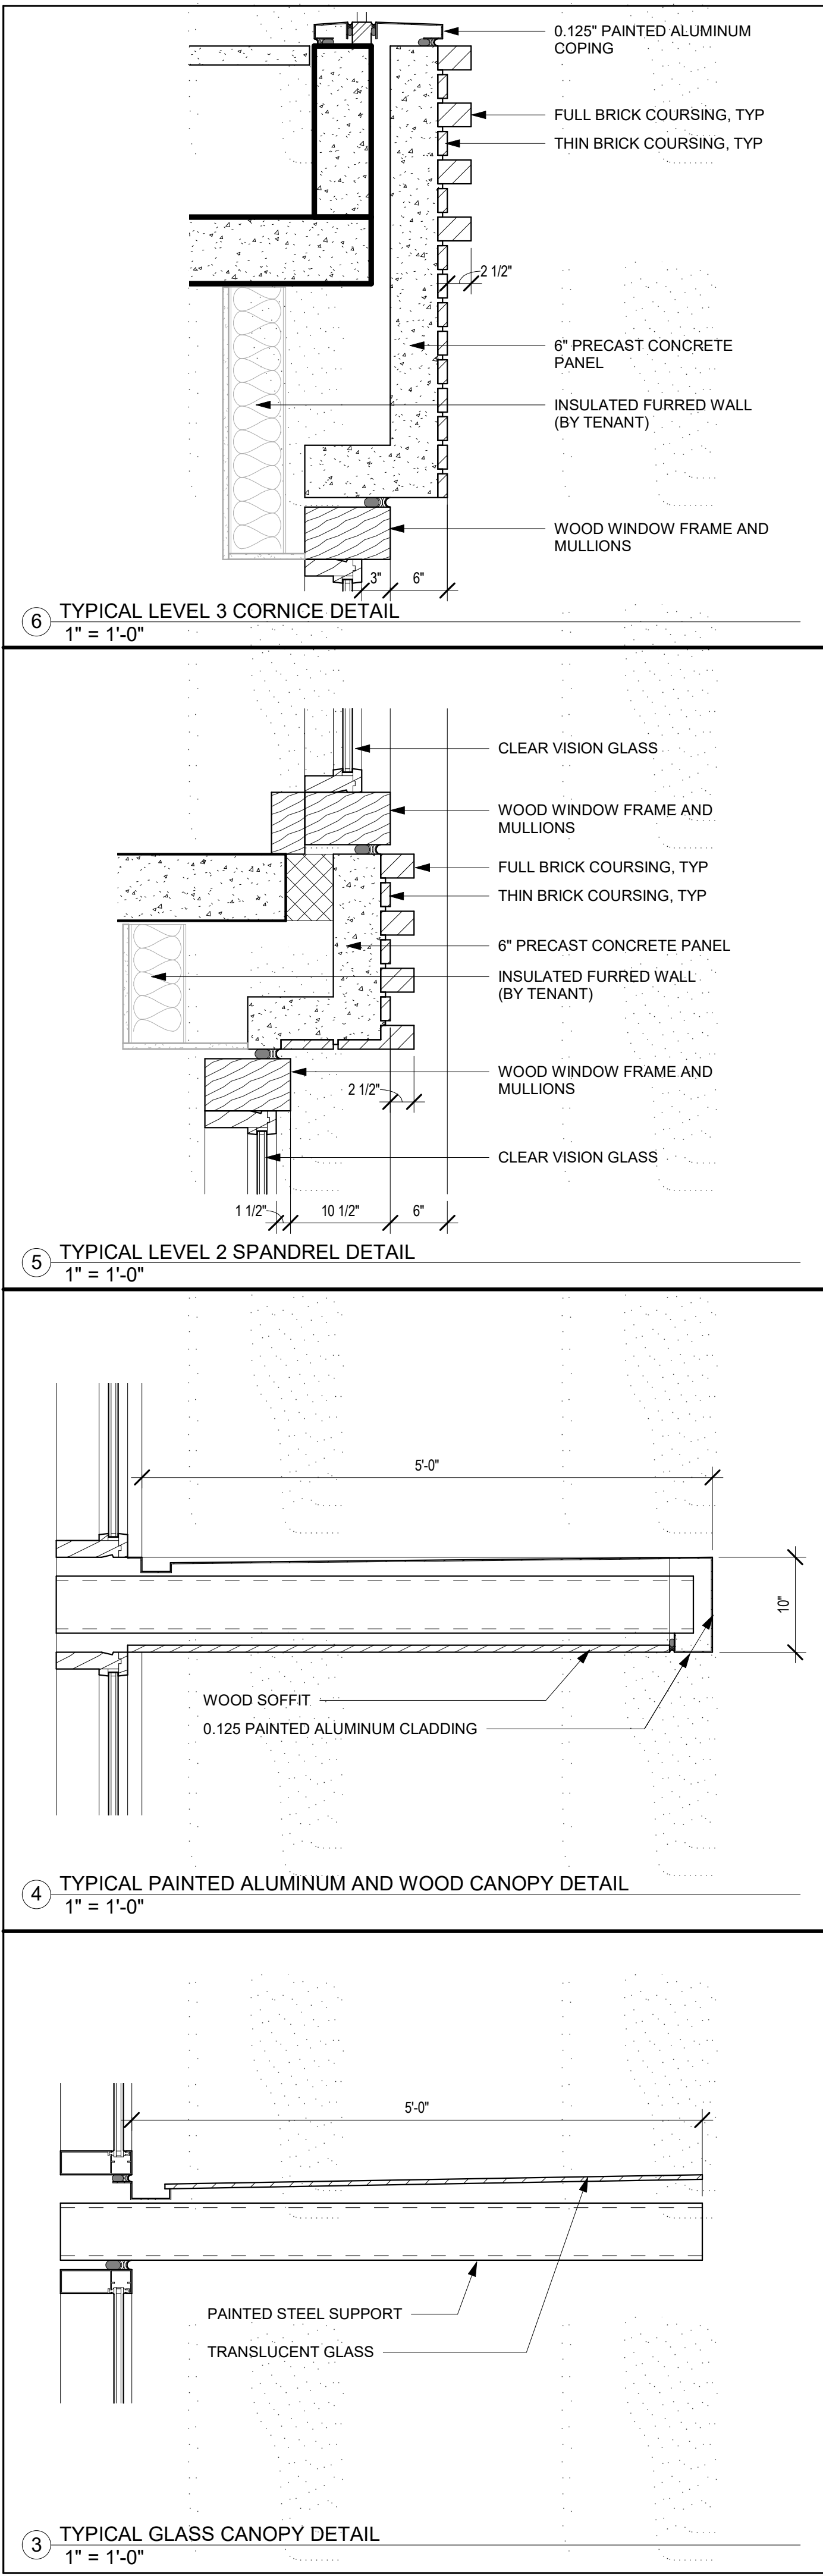

222 EAST 4TH
LANE PARTNERS

LANE PARTNERS

KSH
ARCHITECTS
KORTH SUNSERI HAGEY

ISSUES AND REVISIONS

No.	Date	Description
A	03/19/21	Pre-App Resubmittal
B	04/22/22	Planning Resubmittal

PROJECT NUMBER
16010.00

SHEET TITLE
ENLARGED ELEVATIONS AND SECTIONS

SCALE
As indicated

SHEET NUMBER

A-402

Z:\2019\A19538-1\DWG\entitlements\pd_permit\A19538-1-PC-TS.dwg 6--17--22 08:07:17 AM tknudson

PREPARED BY OR UNDER THE SUPERVISION OF
RODNEY A. STEWART II P.L.S. 9225



LEGEND	
	BUILDING LINE
	MONUMENT LINE
	CONCRETE/BLOCK/RETAINING WALL
	CONCRETE CURB
	CONCRETE CURB & GUTTER
	DRIVEWAY
	EASEMENT LINE
	ELECTRIC LINE
	FENCE LINE
	GAS LINE-VALVE & METER
	LOT LINE
	MONUMENT/MONUMENT LINE
	PROPERTY LINE
	SANITARY SEWER LINE-MANHOLE & CLEANOUT
	SIDEWALK
	SPOT ELEVATION
	STORM DRAIN LINE-MANHOLE & CATCH BASIN
	TELEPHONE LINE
	WATER LINE & VALVE
	ACCESSIBLE PARKING SYMBOL
	ANDE
	BACKFLOW PREVENTION DEVICE
	ELECTROLUER
	FIRE HYDRANT
	GAS METER
	TRANSFORMER
	TRAFFIC SIGNAL POLE
	TRAFFIC SIGN
	TREE
	UTILITY BOX
	WATER VALVE

NOTES

- THIS IS NOT A BOUNDARY SURVEY. NO LIABILITY IS ASSUMED, BY KIER & WRIGHT, FOR THE EXISTENCE OF ANY EASEMENTS, ENCUMBRANCES, DISCREPANCIES IN BOUNDARY, OR TITLE DEFECTS NOT MENTIONED IN SAID DOCUMENTS AND THEREFORE NOT SHOWN ON THIS DRAWING. PROPERTY LINE PLOT ONLY (NO EASEMENTS SHOWN)
- ALL DISTANCES AND ELEVATIONS SHOWN HEREON ARE IN FEET AND DECIMALS THEREOF.
- THE TYPES, LOCATIONS, SIZES AND/OR DEPTHS OF EXISTING UNDERGROUND UTILITIES AS SHOWN ON THIS TOPOGRAPHIC SURVEY WERE OBTAINED FROM SOURCES OF VARYING RELIABILITY. THE CONTRACTOR IS CAUTIONED THAT ONLY ACTUAL EXCAVATION WILL REVEAL THE TYPES, EXTENT, SIZES, LOCATIONS AND DEPTHS OF SUCH UNDERGROUND UTILITIES. (A REASONABLE EFFORT HAS BEEN MADE TO LOCATE AND DELINEATE ALL KNOWN UNDERGROUND UTILITIES). HOWEVER, THE ENGINEER CAN ASSUME NO RESPONSIBILITY FOR THE COMPLETENESS OR ACCURACY OF ITS DELINEATION OF SUCH UNDERGROUND UTILITIES WHICH MAY BE ENCOUNTERED, BUT WHICH ARE NOT SHOWN ON THESE DRAWINGS.
- A REQUEST WAS MADE TO PACIFIC GAS & ELECTRIC COMPANY FOR INFORMATION REGARDING THE LOCATION OF THEIR FACILITIES NEAR THIS SITE. AS OF DECEMBER 13, 2019, THEY HAD NOT RESPONDED WITH THIS INFORMATION. UNTIL WE RECEIVE THIS INFORMATION AND ARE ABLE TO DELINEATE THESE FACILITIES, ALL PARTIES SHOULD CONSIDER THIS SURVEY AS PRELIMINARY WITH REGARDS TO THE LOCATION OF THE UTILITY FACILITIES. UPON RECEIPT OF THIS INFORMATION KIER & WRIGHT WILL UPDATE THIS SURVEY AND REISSUE IT.
- THE SUBJECT PROPERTY IS SHOWN ON THE FEDERAL EMERGENCY MANAGEMENT AGENCY (FEMA) FLOOD INSURANCE RATE MAP (FIRM) FOR SAN MATEO COUNTY, CALIFORNIA, MAP NUMBER 060810154G FOR COMMUNITY NUMBER 060328 (CITY OF SAN MATEO), WITH AN EFFECTIVE DATE OF APRIL 5, 2019, AS BEING LOCATED IN FLOOD ZONE "X NO SCREEN". ACCORDING TO FEMA THE DEFINITION OF ZONE "X NO SCREEN" IS: AREAS OF MINIMAL FLOOD HAZARD

INFORMATION WAS OBTAINED FROM THE CITY OF SAN MATEO, PUBLIC WORKS DEPARTMENT ON DECEMBER 17, 2019.
- BENCHMARK:
CITY OF SAN MATEO BENCHMARK 082-001; RAMSET NAIL AND WASHER, TOP OF CURB WESTERLY END AND WESTERLY RETURN AT B STREET AND 4TH AVENUE.
ELEVATION: 26.693 DATUM: SAN MATEO DATUM +100
- BASIS OF BEARINGS:
THE BEARING OF SOUTH 48° 30' 00" WEST TAKEN ON THE MONUMENT LINE OF EAST FOURTH AVENUE AS SHOWN ON THAT CERTAIN PARCEL MAP FILED FOR RECORD ON JUNE 10, 1996, IN BOOK 69 OF PARCEL MAPS AT PAGES 22, NO. 350 OF SAN MATEO COUNTY RECORDS WAS TAKEN AS THE BASIS FOR ALL BEARINGS SHOWN HEREON.
- CORNER RECORD NOTE:
THE DEVELOPER AND/OR CONTRACTOR SHALL BE RESPONSIBLE FOR THE PREPARATION AND FILING OF PRE-CONSTRUCTION AND POST-CONSTRUCTION CORNER RECORDS FOR ANY MONUMENTS OR PROPERTY CORNERS SHOWN HEREON THAT MAY BE DESTROYED DURING IMPROVEMENTS TO THE SUBJECT PROPERTY AS DEFINED IN SECTION 8771(B) OF THE PROFESSIONAL LAND SURVEYORS ACT.

ZONING CBD/R

ZONING CBD

ZONING CBD

ZONING CBD

ZONING CBD/R

ZONING CBD/R

ZONING C1-3/R5

ZONING R6-D

ZONING OS

222 EAST 4TH
LANE PARTNERS

LANE PARTNERS

KSH
ARCHITECTS
KORTH SUNSERI HAGEY

k w KIER+WRIGHT

3350 Scott Boulevard, Building 22 Phone: (408) 727-6665
Santa Clara, California 95054 www.kierwright.com

ISSUES AND REVISIONS

No.	Date	Description
A	05/05/2020	Pre-Application Set
B	10/21/2020	Pre-App Resubmittal
C	03/19/2021	Pre-App Resubmittal
D	10/15/2021	Pre-App Resubmittal
E	02/04/2022	Pre-App Resubmittal
F	04/22/2022	Pre-App Resubmittal
G	06/15/2022	Pre-App Resubmittal

PROJECT NUMBER
A19538-1

SHEET TITLE
EXISTING
CONDITIONS
PLAN

SCALE
AS SHOWN

SHEET NUMBER

C1.00




0 10 20 40 60
Scale 1" = 20'

NOTES

1. REMOVE ALL TREES AND SHRUBS WITHIN PROJECT LIMIT OF WORK.
2. REMOVE EXISTING BUILDING, BELOW GRADE PARKING STRUCTURE AND FOUNDATION IN ENTIRETY.
3. REMOVE ALL CONCRETE, AC PAVEMENT AND BASE ROCK SUBGRADE WITHIN PROJECT LIMIT OF WORK.
4. REMOVE ALL LANDSCAPING AND IRRIGATION WITHIN LIMIT OF WORK.
5. ALL UNUSED WATER LATERALS SHALL BE REMOVED AND CAPPED AT THE MAIN.
6. CONTRACTOR SHALL COORDINATE REMOVAL OF BIKE RACKS ALONG THE PROJECT FRONTAGE WITH PUBLIC WORKS.

LEGEND

- ✕ ✕ ✕ UNDERGROUND UTILITIES TO BE REMOVED
- — — UNDERGROUND UTILITIES TO BE ABANDONED
- ⌈ — — — PLUG AND CAP END
- ① REMOVE CONCRETE CURB & GUTTER
- ② REMOVE CONCRETE CURB
- ③ REMOVE CONCRETE & BASE ROCK
- ④ REMOVE ASPHALT & BASE ROCK
- ⑤ REMOVE EXISTING UTILITY IN ENTIRETY
- ⑥ REMOVE EXISTING UTILITY STRUCTURE
- ⑦ PROTECT EXISTING UTILITY IN PLACE
- ⑧ REMOVE EXISTING PARKING METER STATION
- ⑨ REMOVE PLANTER WALL
- ⑩ REMOVE SIGN
- ⑪ REMOVE EXISTING CURB, GUTTER, SIDEWALK AND RAMP. PROTECT ALL TRAFFIC POLES, BOXES & PUSH BUTTONS.

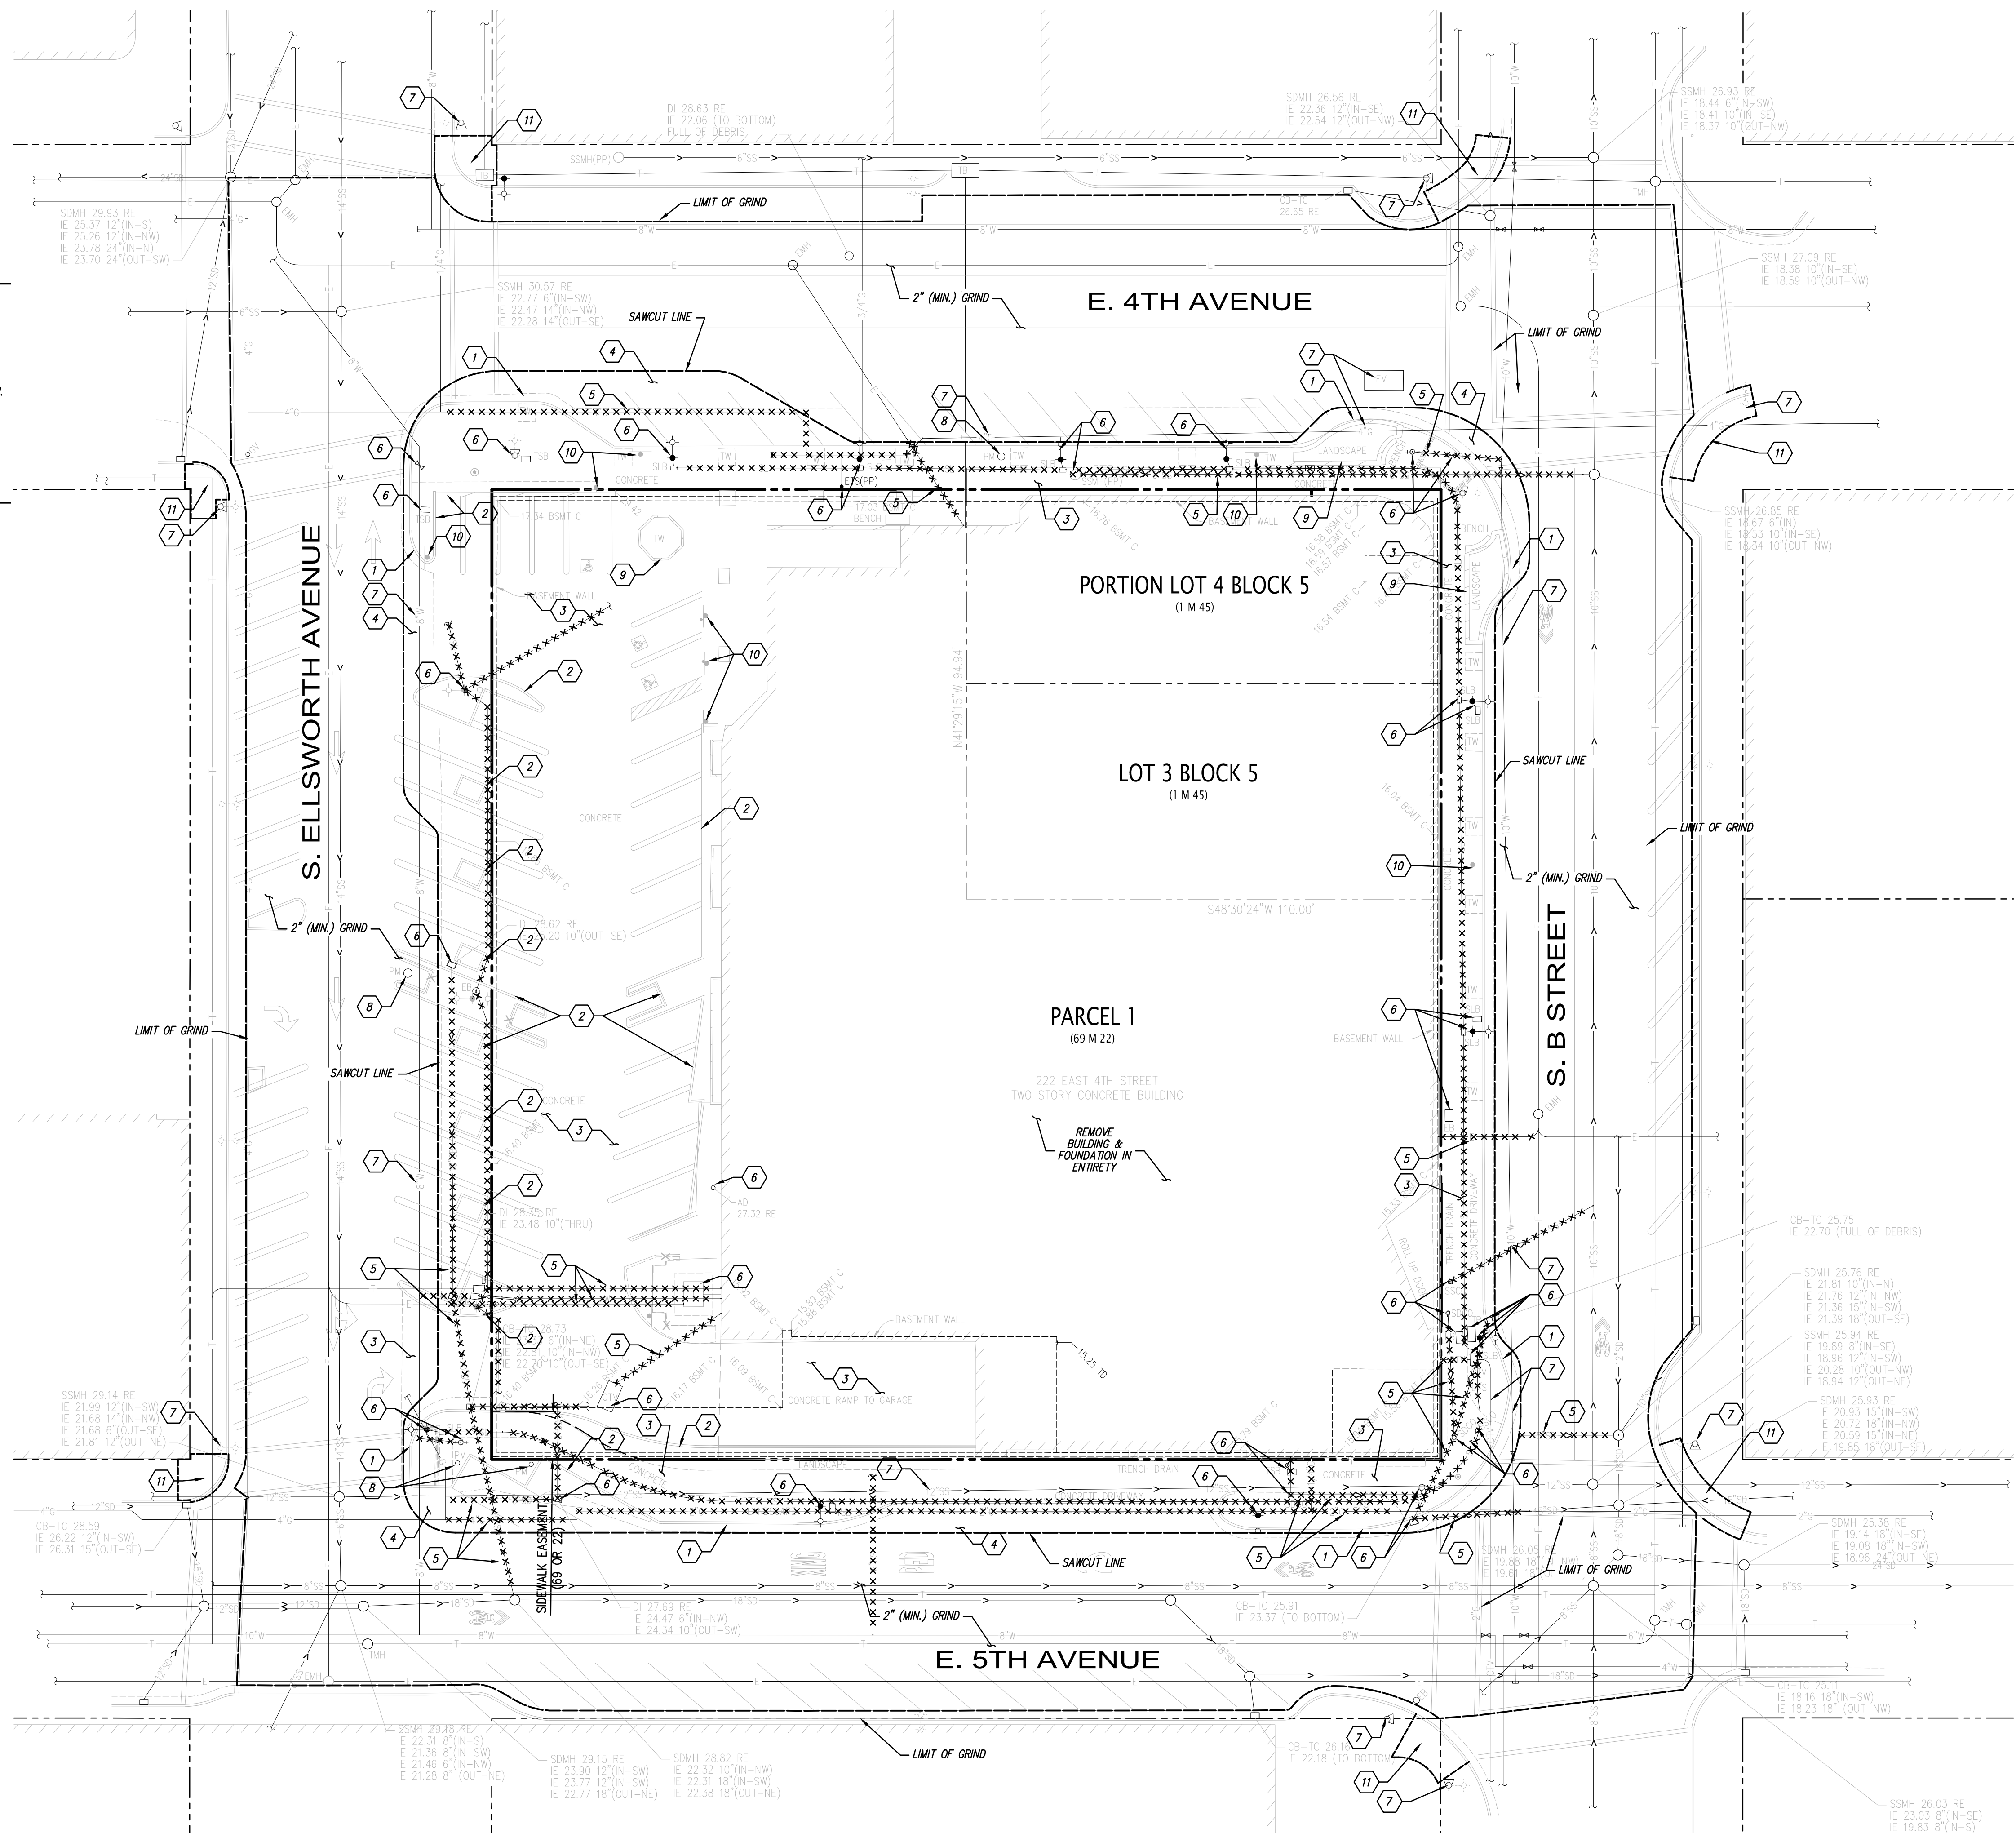

222 EAST 4TH

LANE PARTNERS

LANE PARTNERS



ARCHITECTS
KORTH SUNSERI HAGEY



3350 Scott Boulevard, Building 22 Phone: (408) 727-6665
Santa Clara, California 95054 www.kierwright.com

ISSUES AND REVISIONS

No.	Date	Description
A	05/05/2020	Pre-Application Set
B	10/21/2020	Pre-App Resubmittal
C	03/19/2021	Pre-App Resubmittal
D	10/15/2021	Pre-App Resubmittal
E	02/04/2022	Pre-App Resubmittal
F	04/22/2022	Pre-App Resubmittal
G	06/15/2022	Pre-App Resubmittal

PROJECT NUMBER
A19538-1

SHEET TITLE
DEMOLITION
PLAN

SCALE
AS SHOWN

SHEET NUMBER

C1.01

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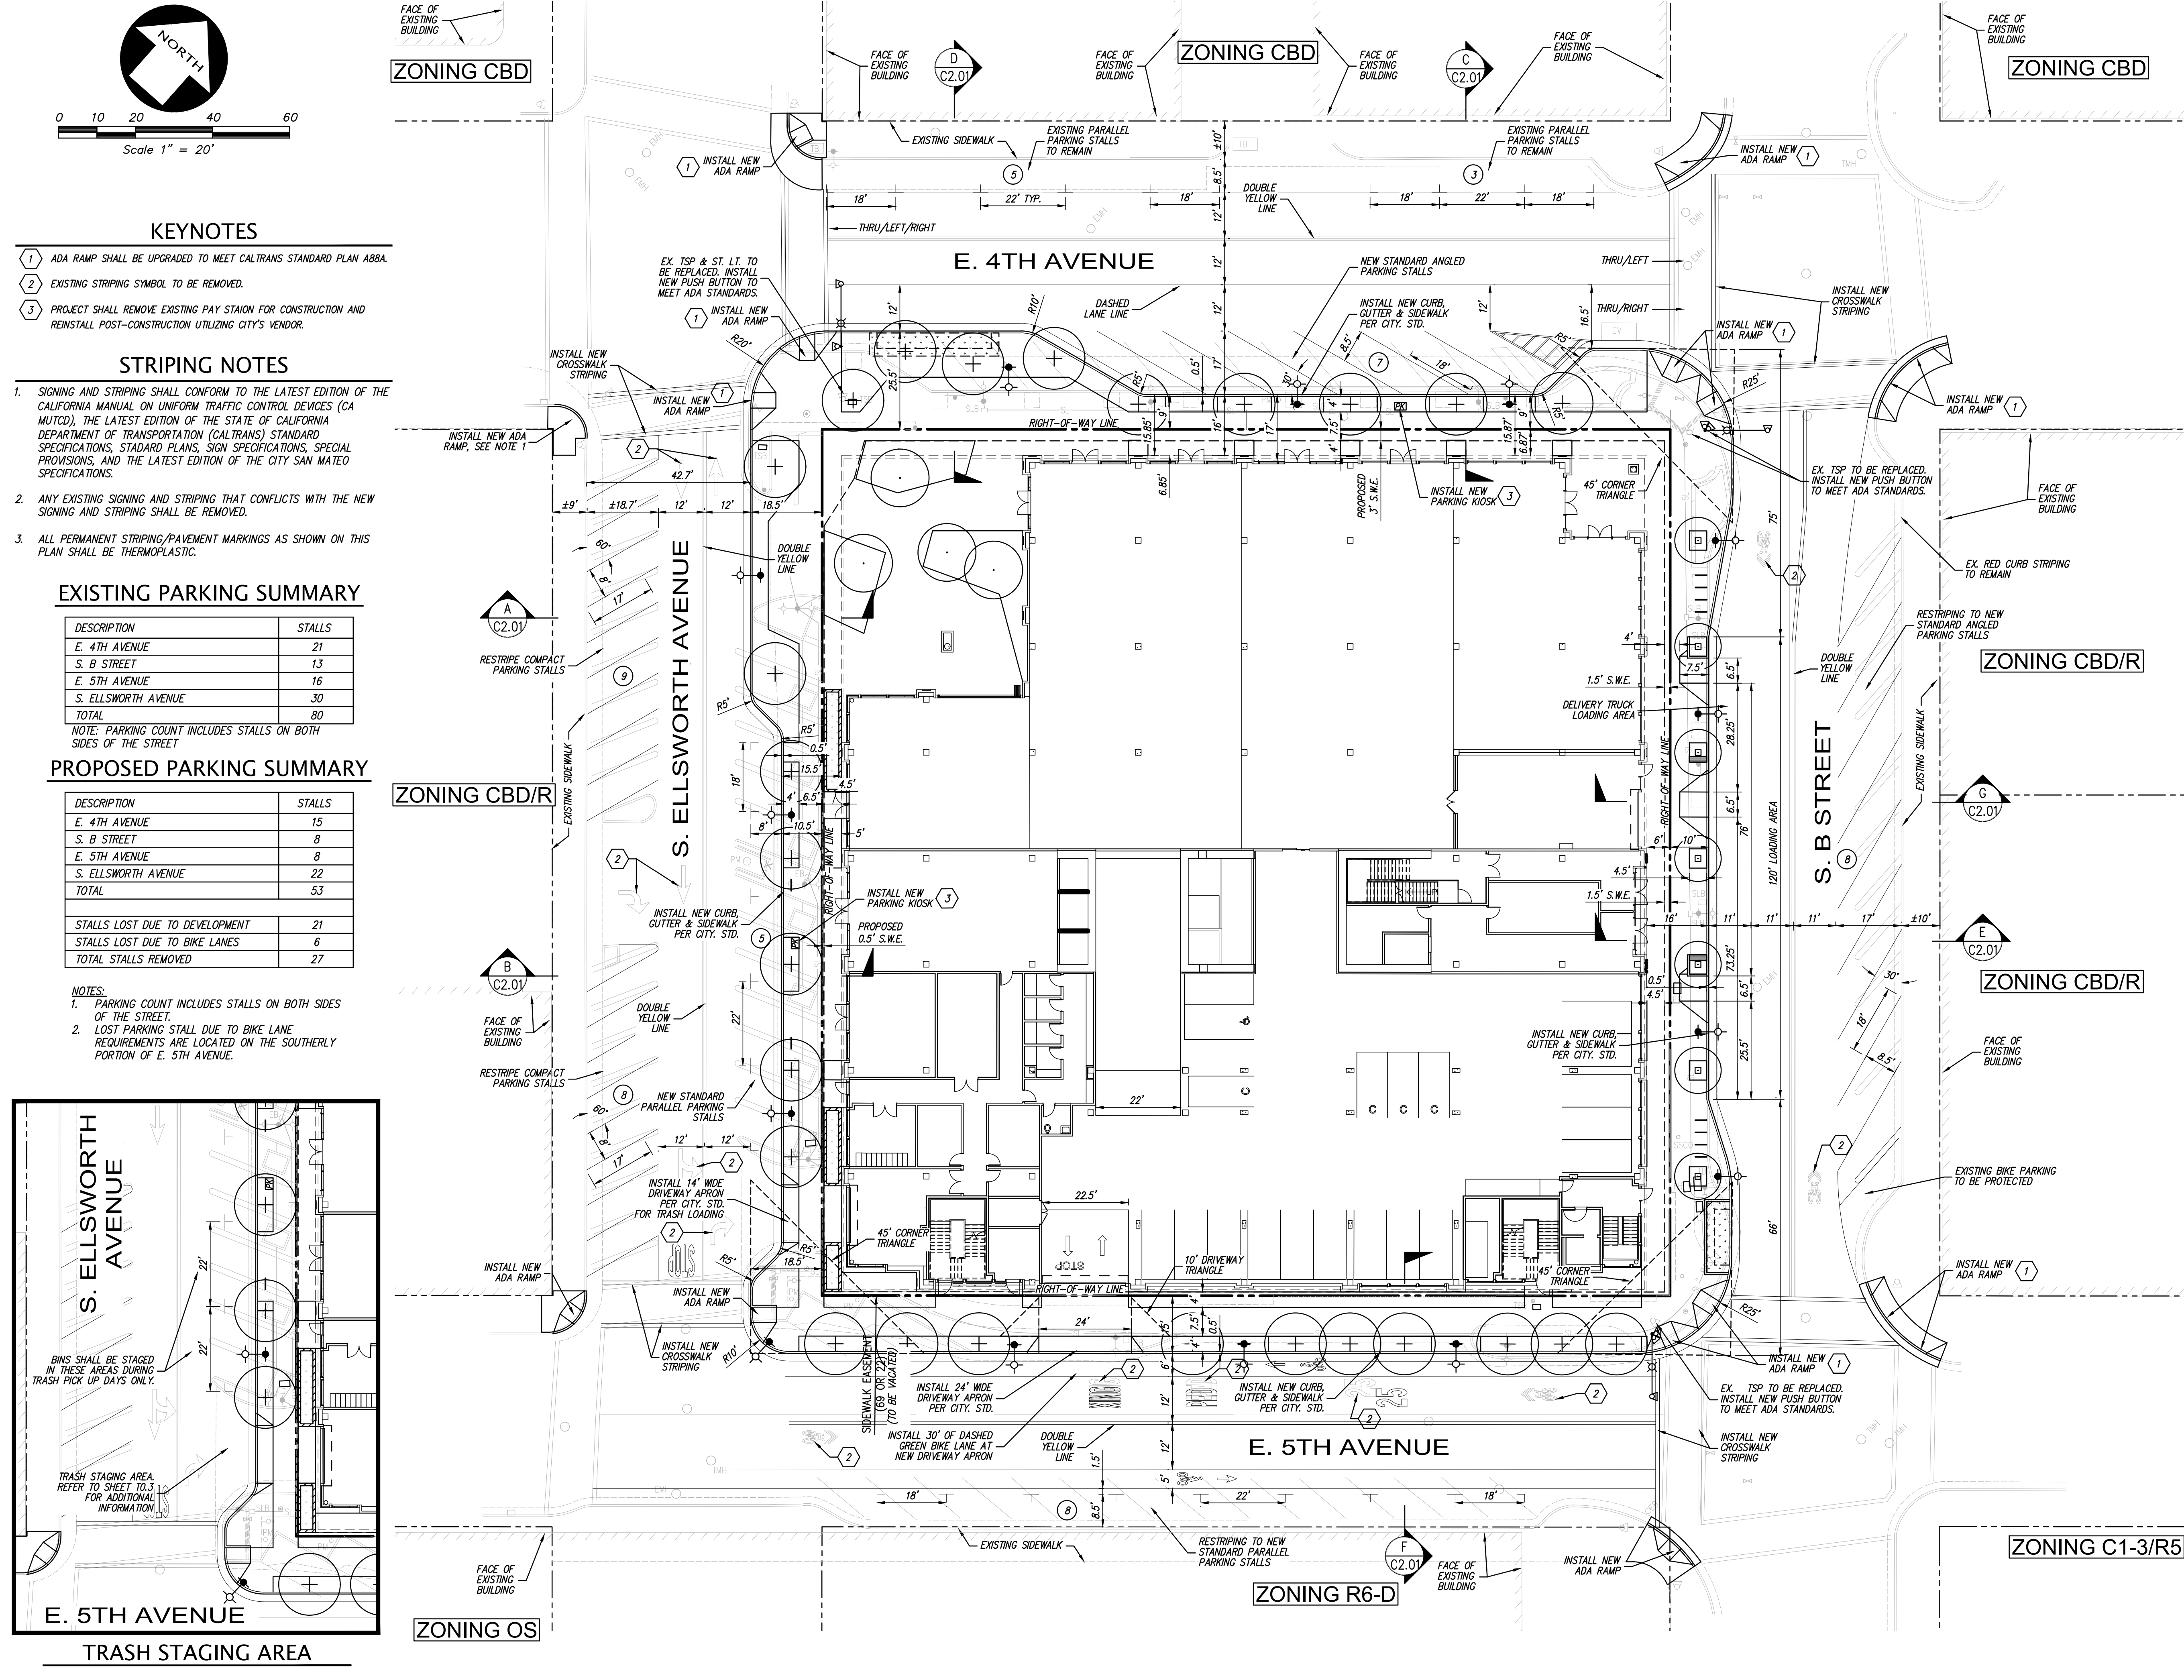
PROJECT NUMBER
A19538-1

SHEET TITLE
PRELIMINARY
STREET
LAYOUT PLAN








SCALE
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SHEET NUMBER

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G	06/15/2022	Pre-App Resubmittal

PROJECT NUMBER
A19538-1

SHEET TITLE
TYPICAL
SECTIONS

SCALE
AS SHOWN

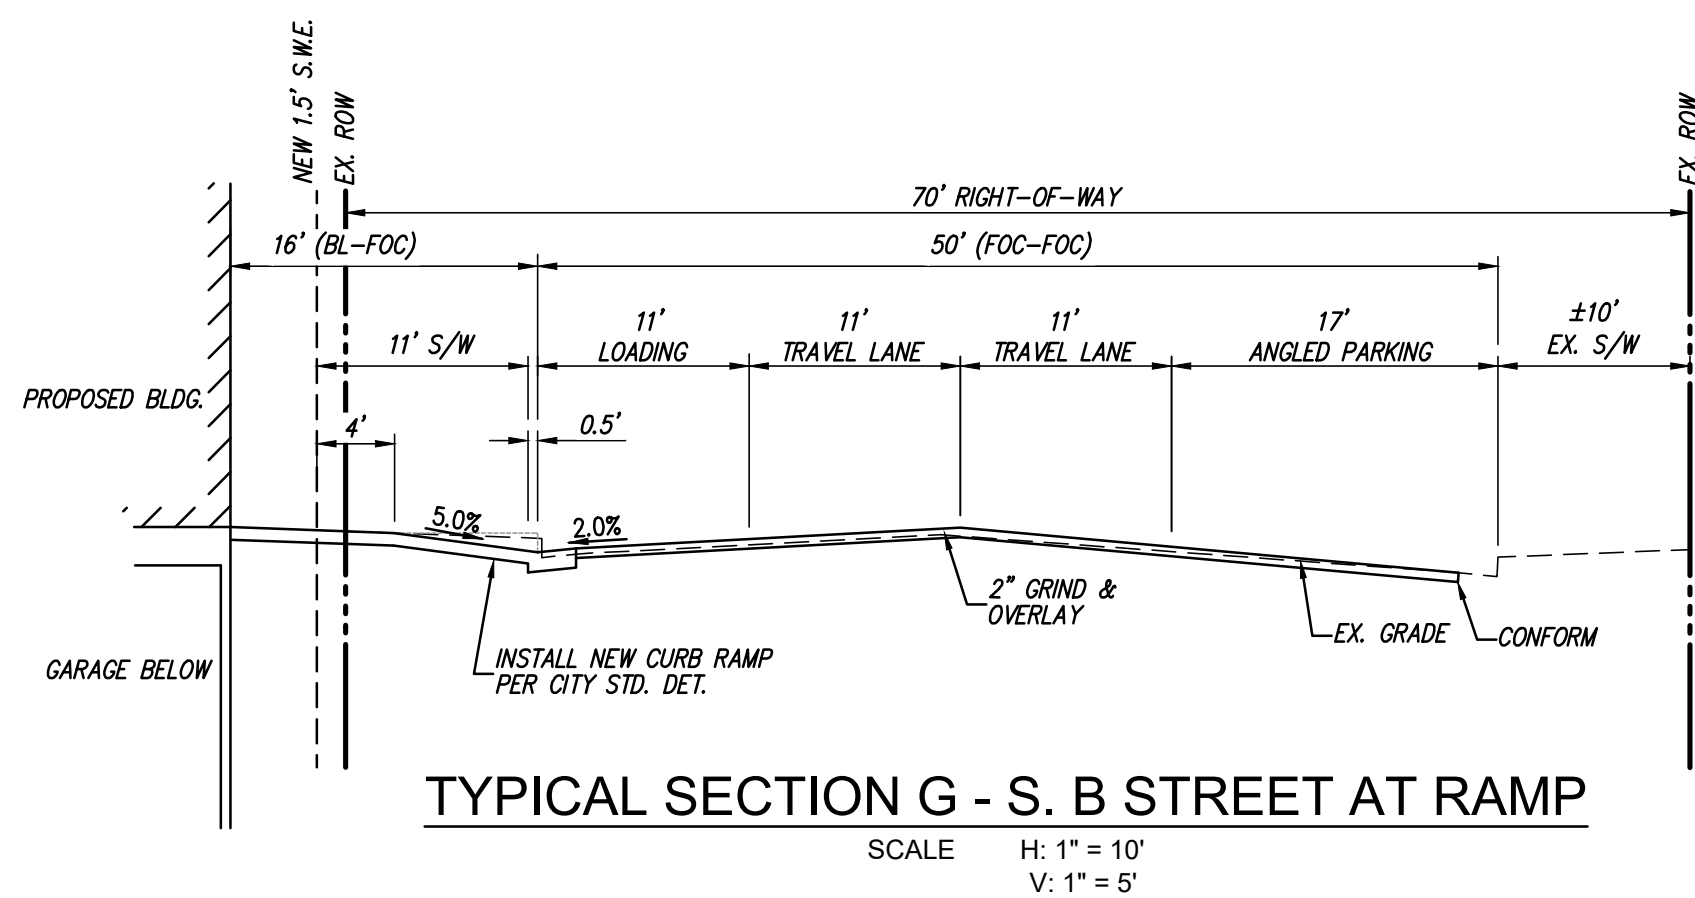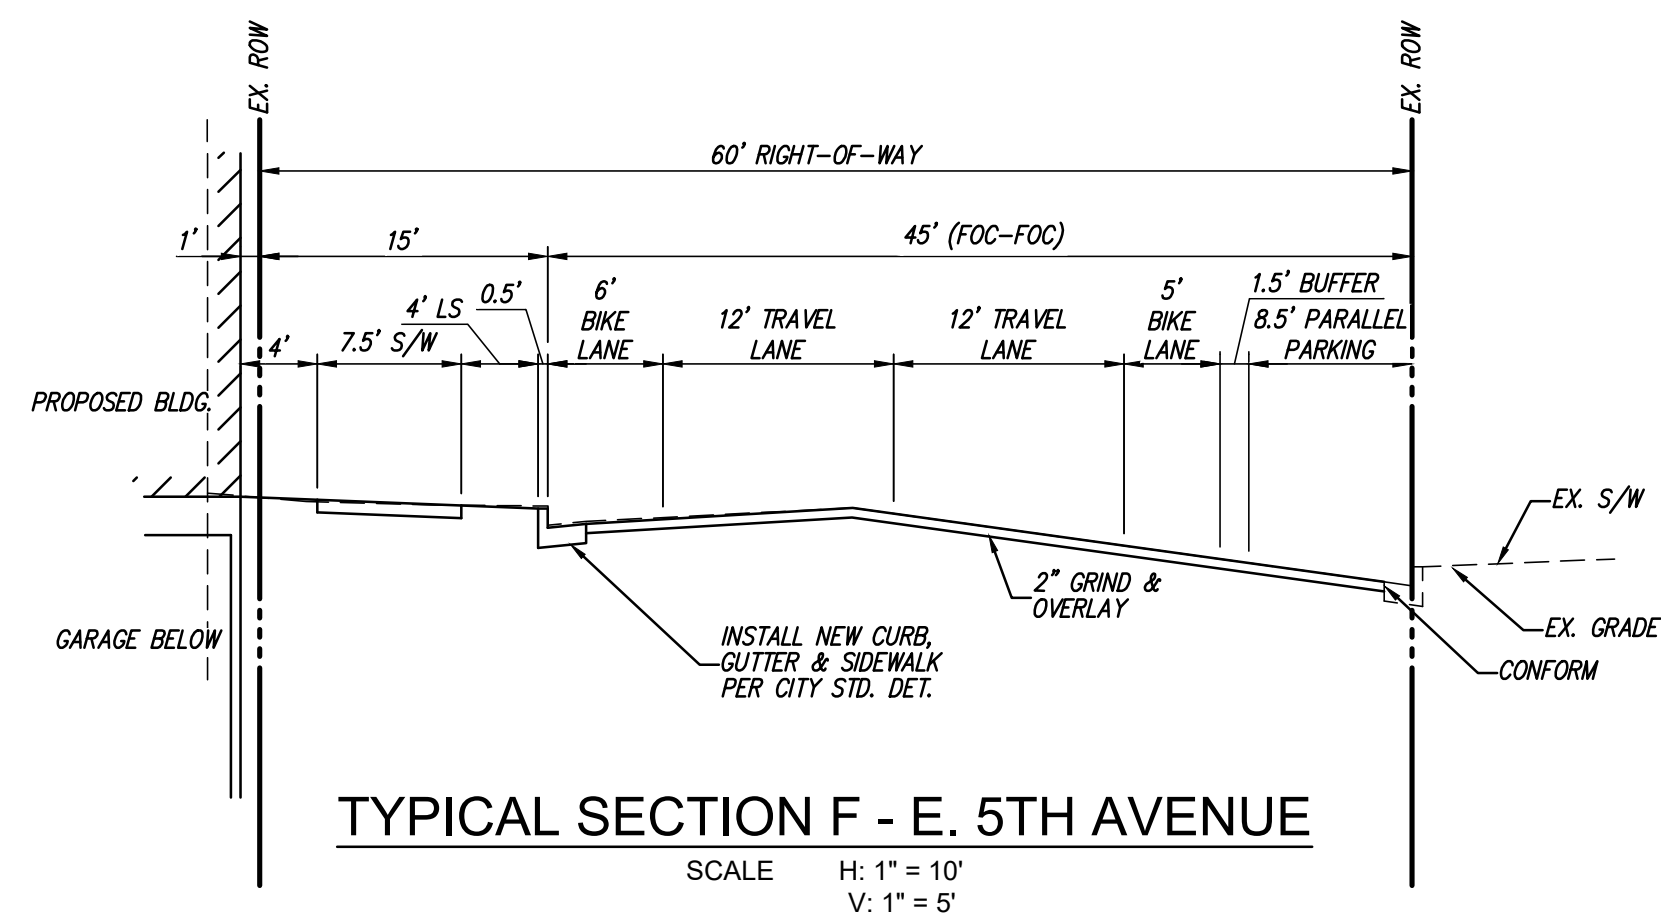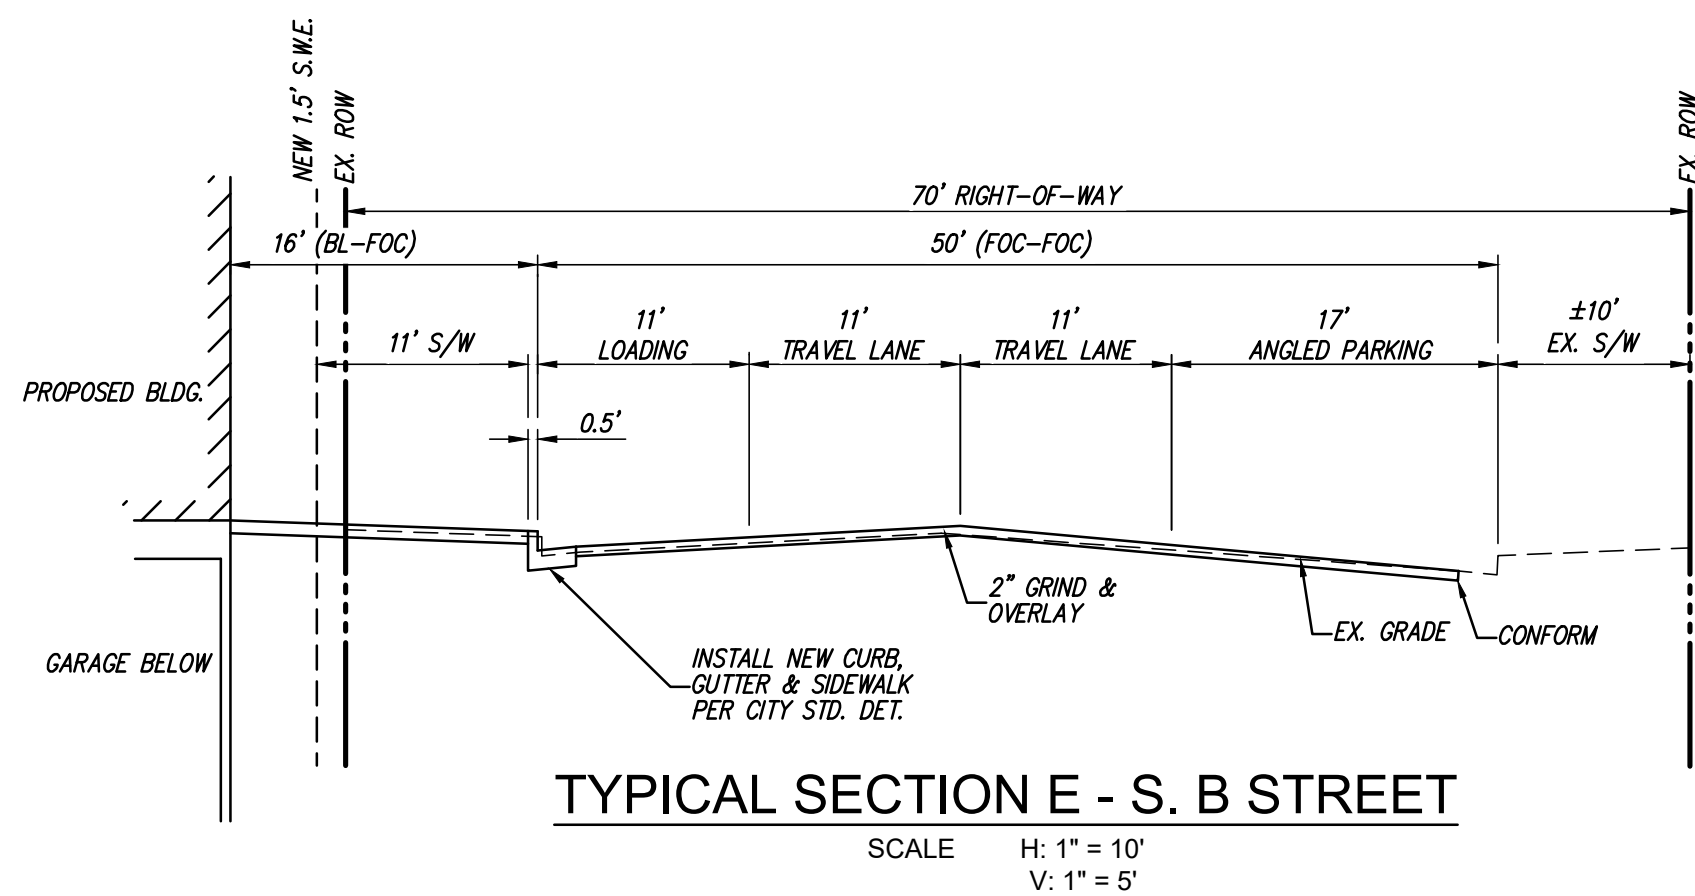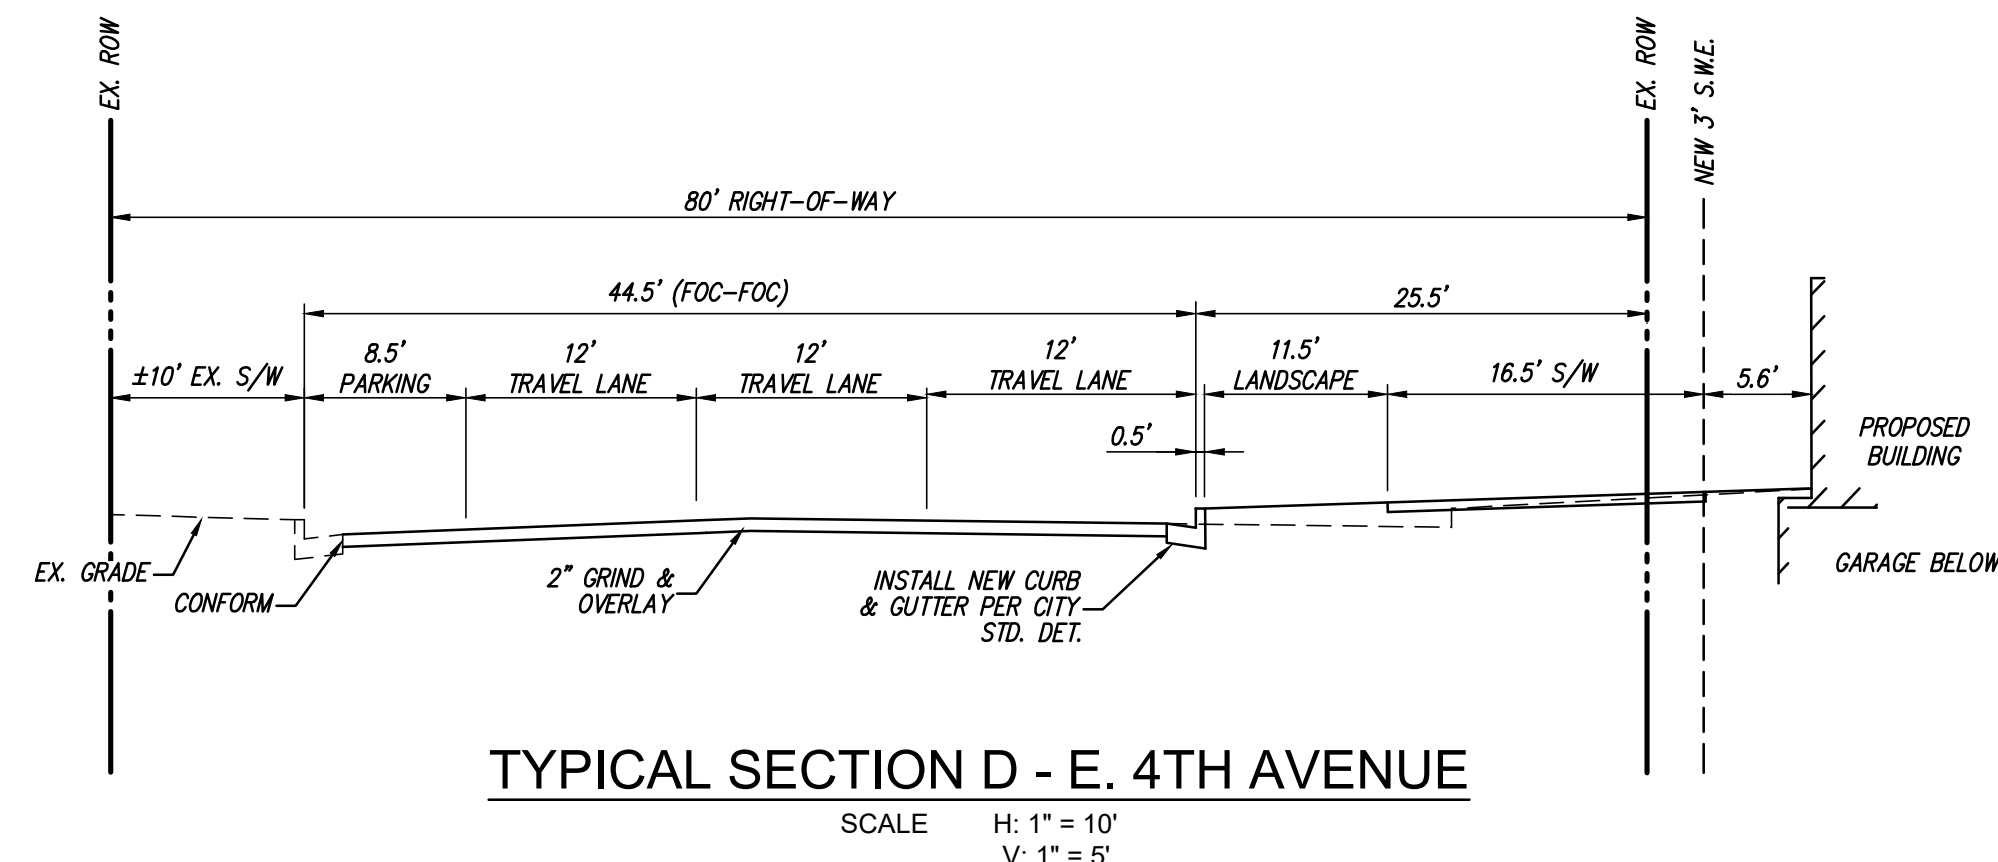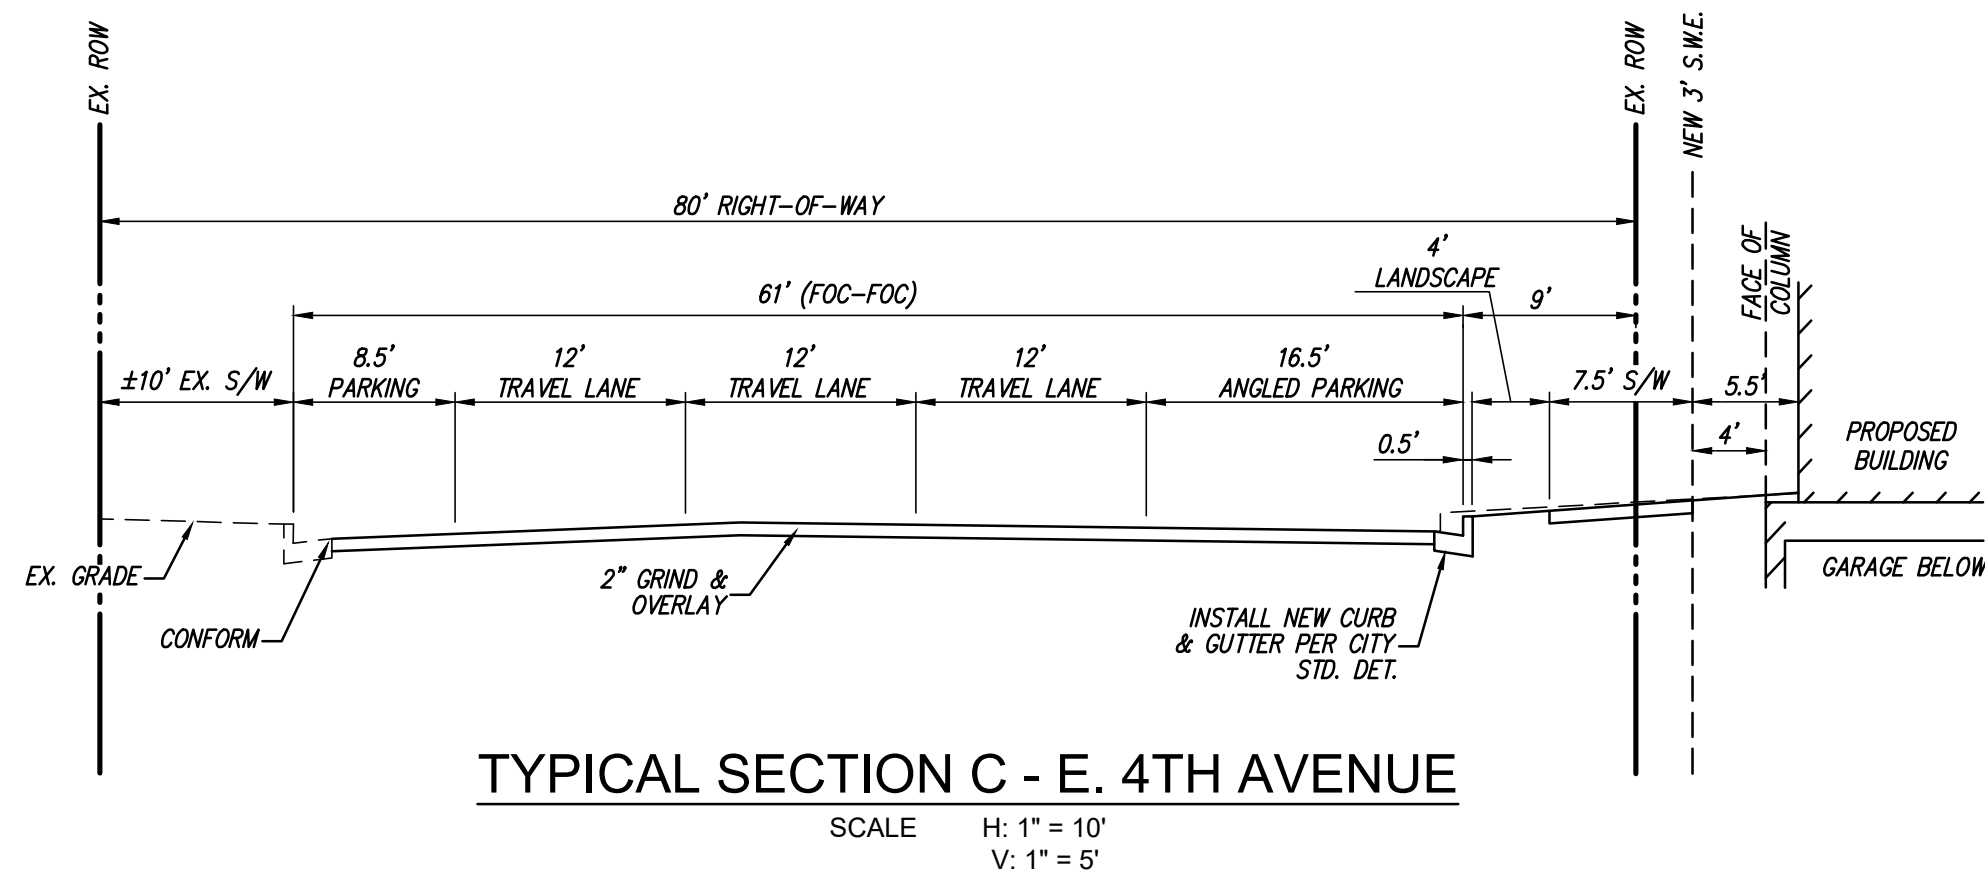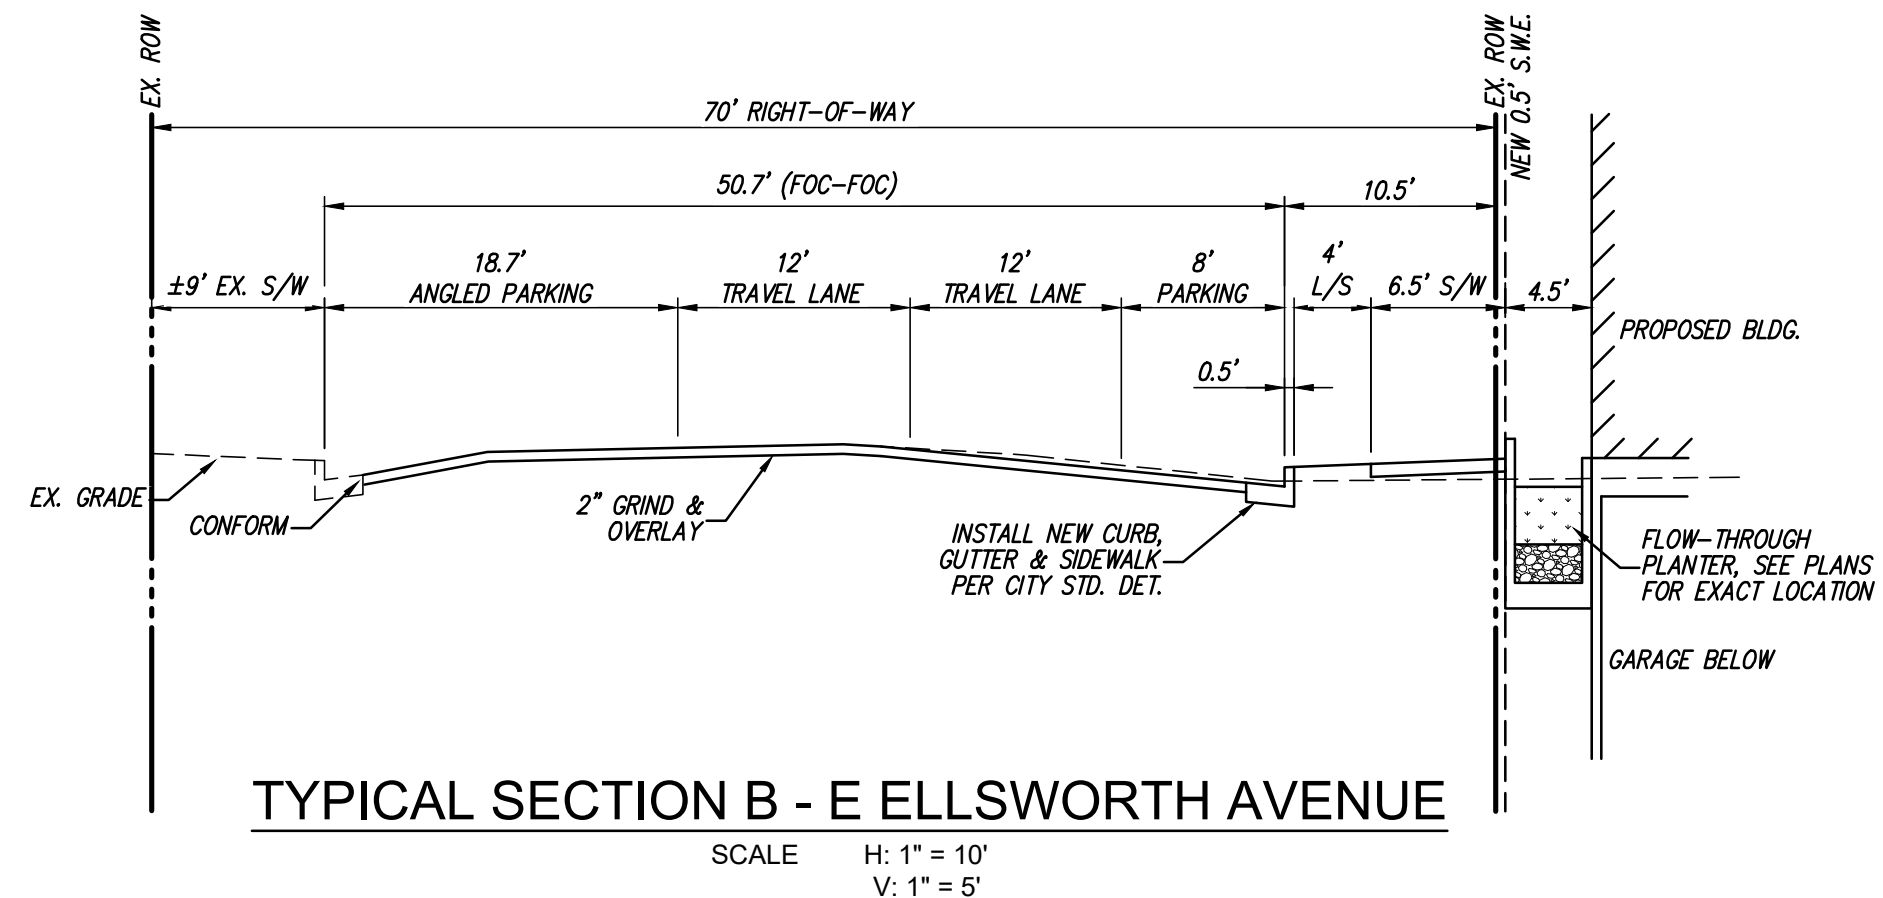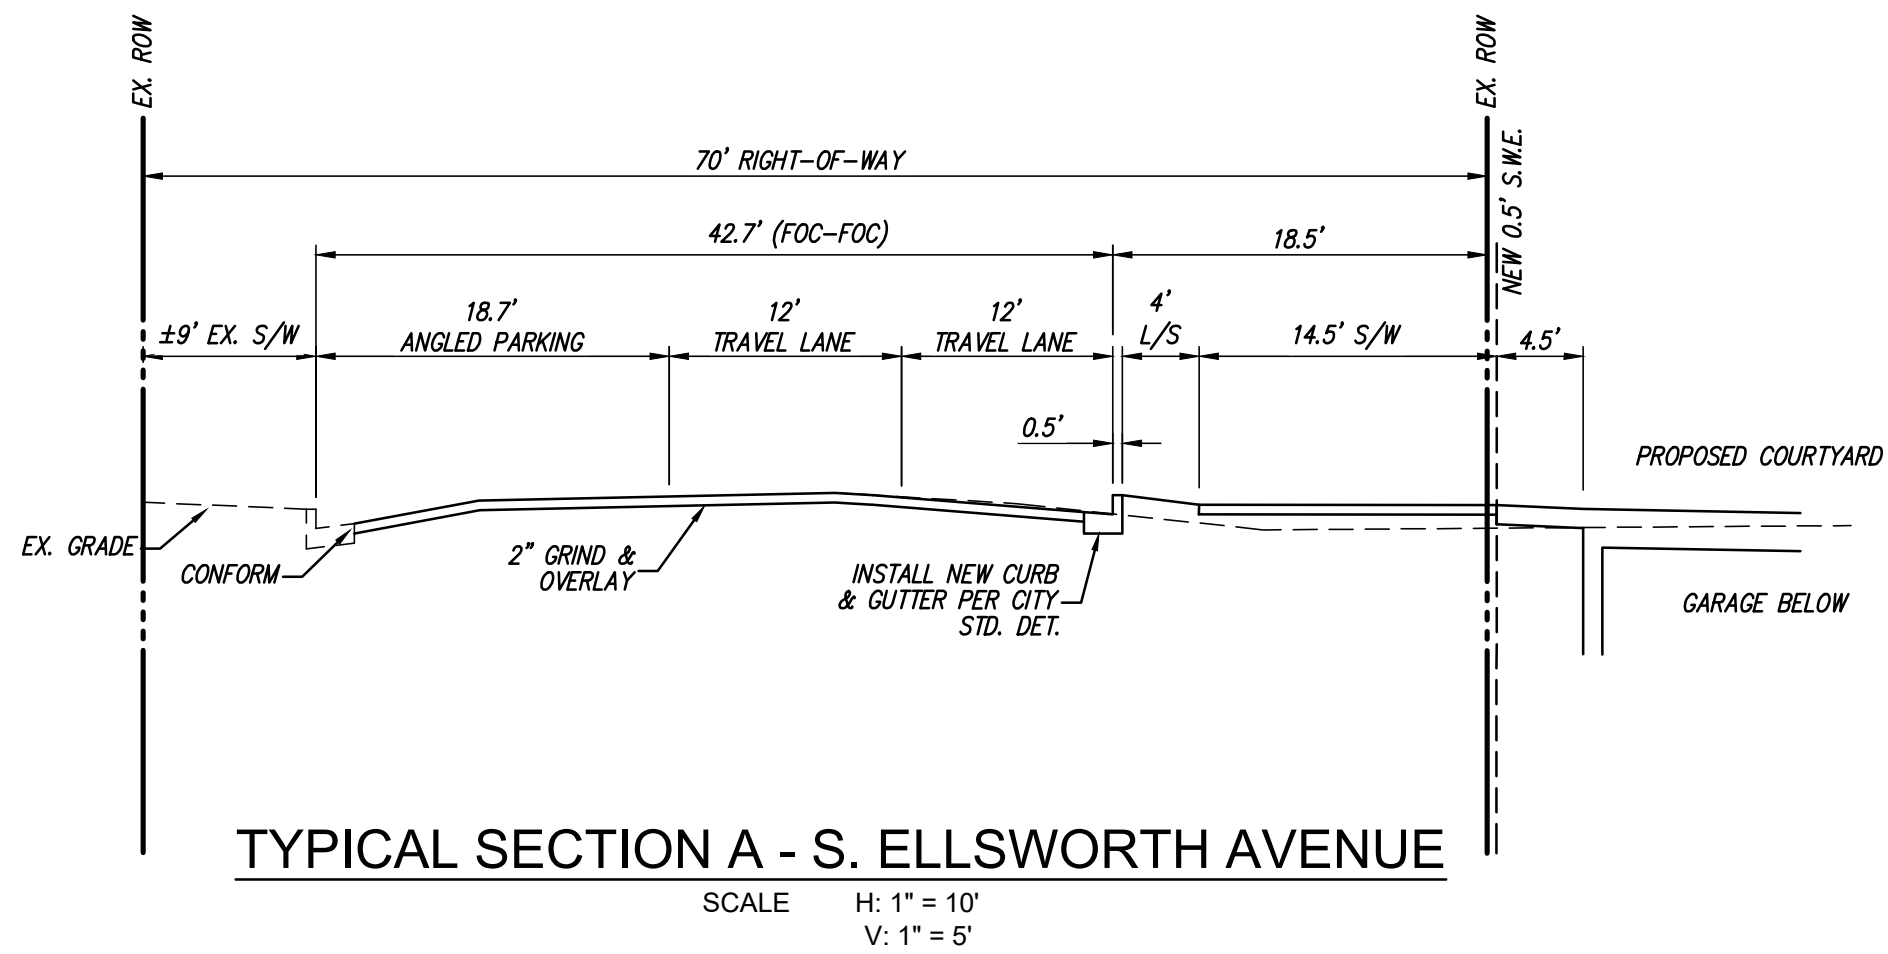SHEET NUMBER

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PROJECT NUMBER
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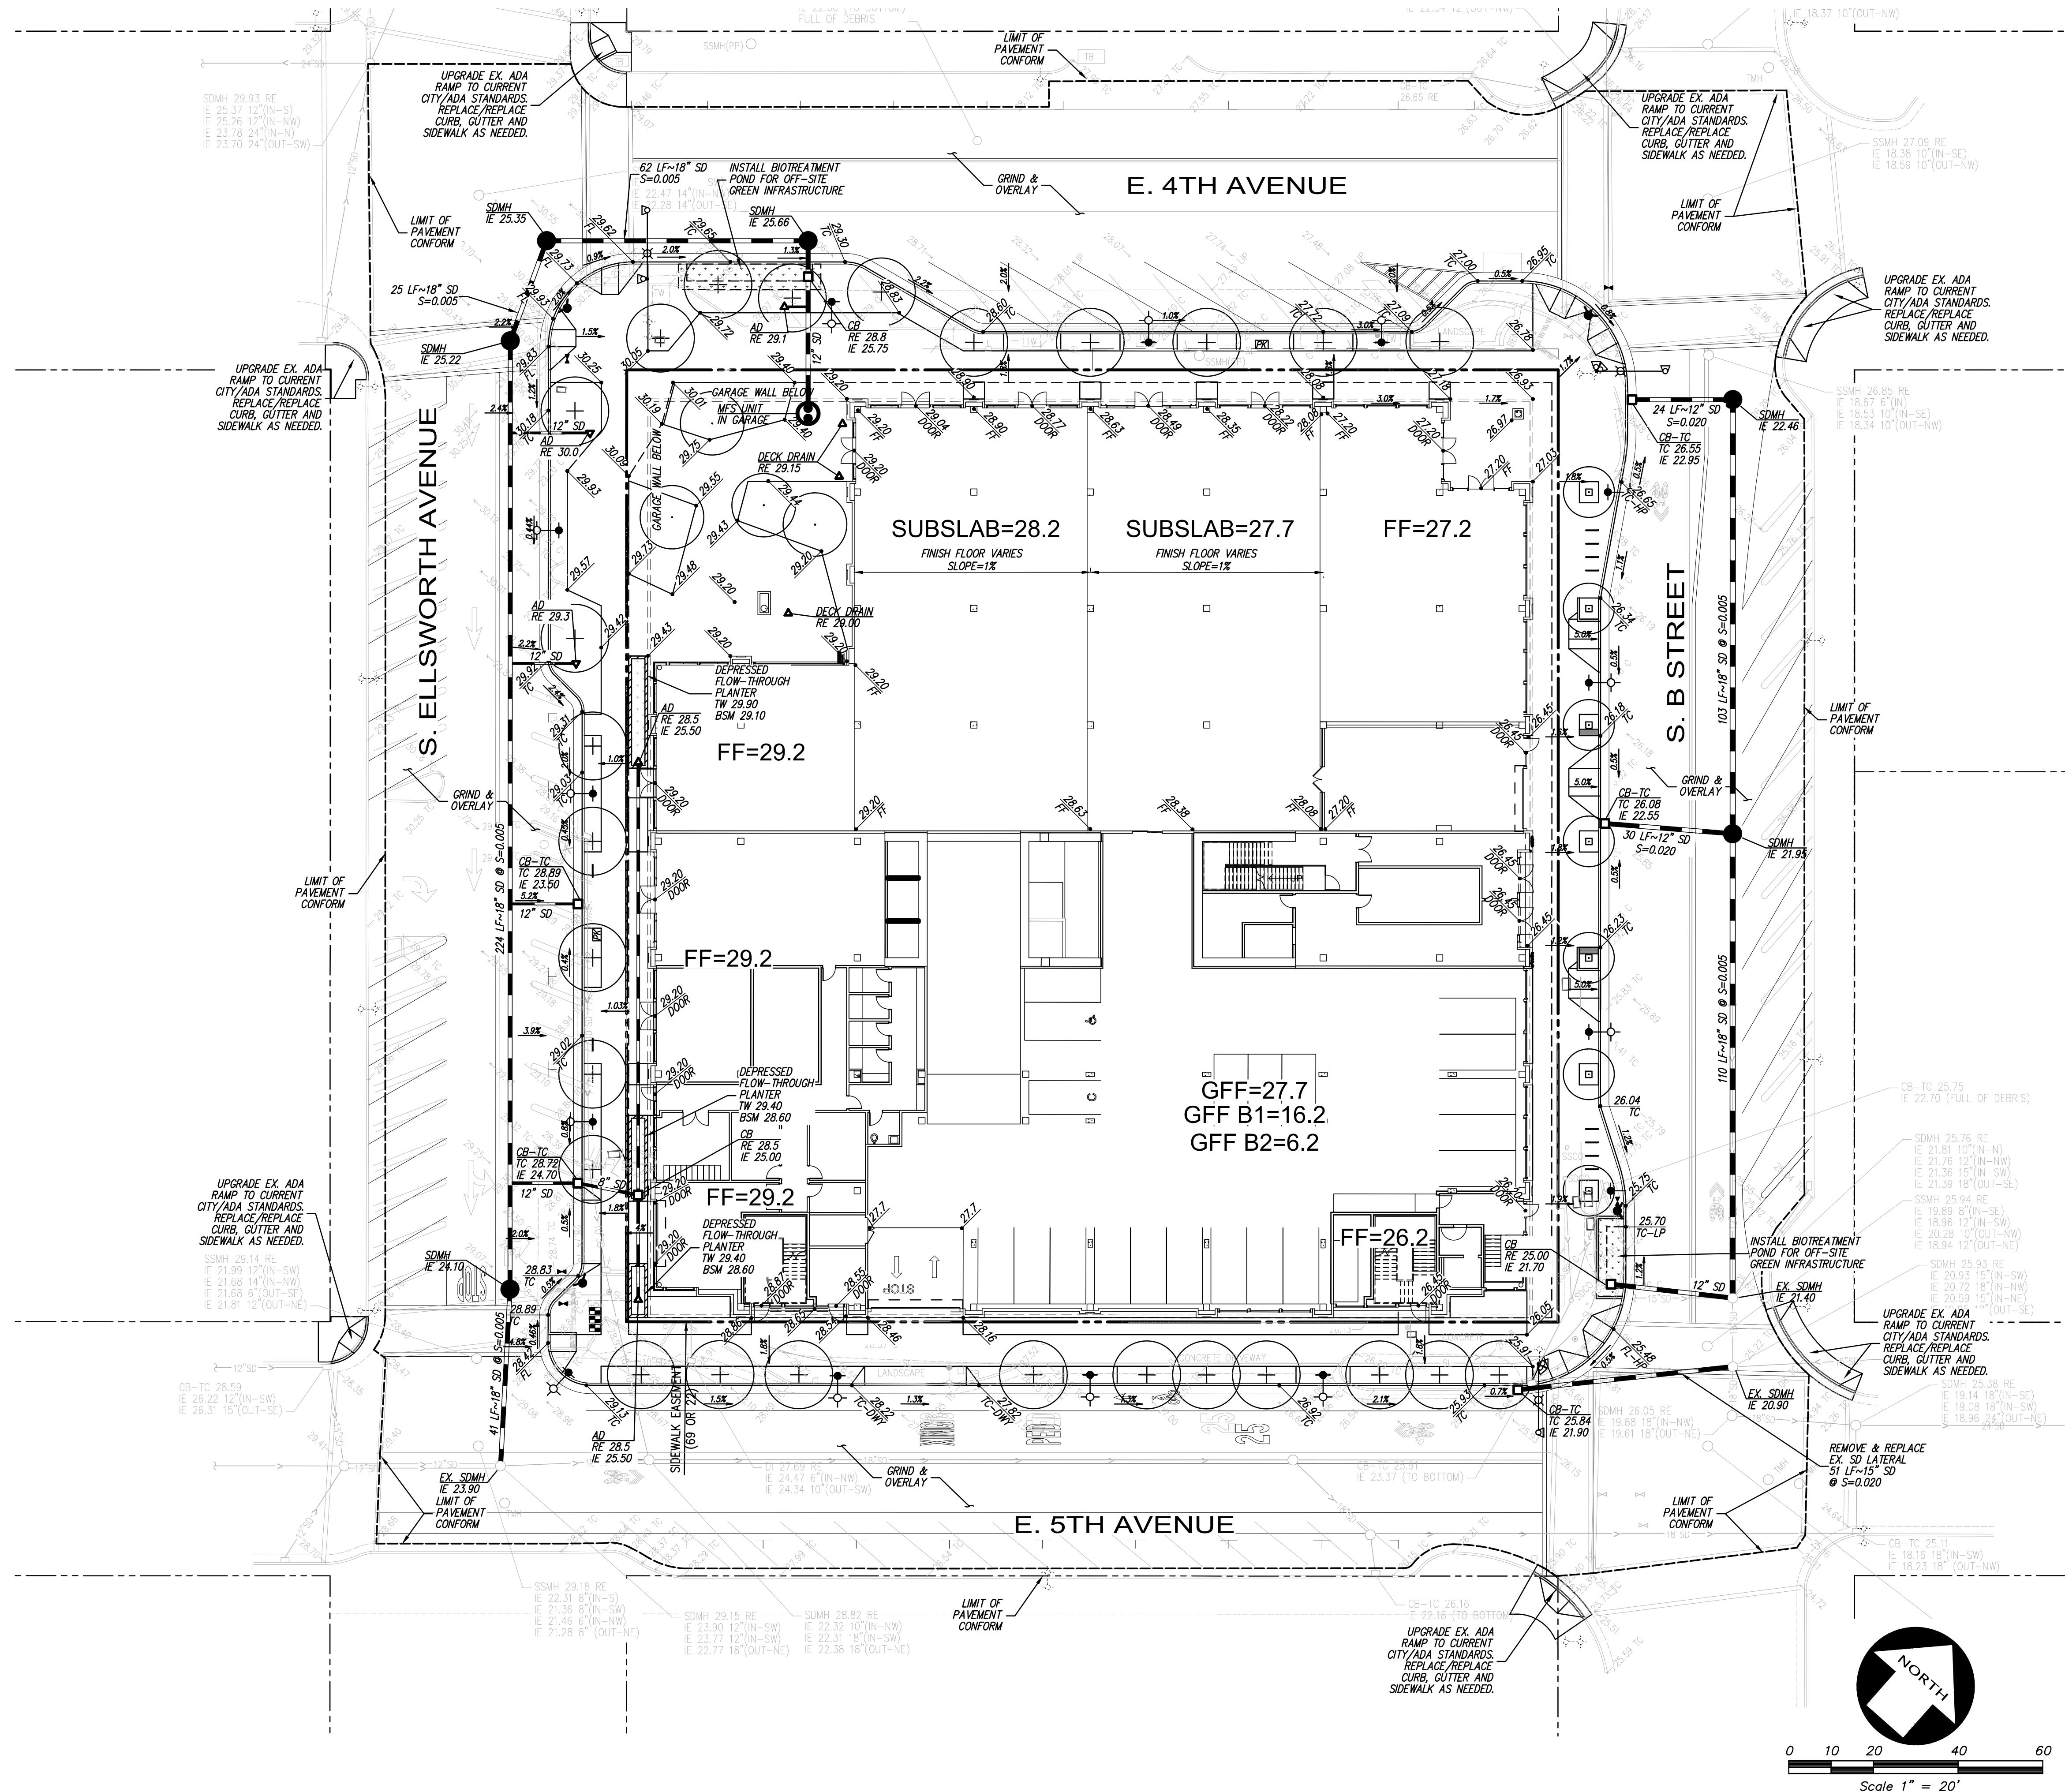
SHEET TITLE
**PRELIMINARY
GRADING,
DRAINAGE
PLAN**
SCALE
AS SHOWN

SHEET NUMBER

C3.00

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LEGEND	
AD	AREA DRAIN
BSM	BIO SOIL MIX
FL	FLOW LINE
GFF	GARAGE FINISHED FLOOR
HP	HIGH POINT
IE	INVERT
RE	RIM ELEVATION
TC	TOP OF CURB
TW	TOP OF WALL
STORM DRAIN LINE	
AREA DRAIN	
STORM DRAIN CATCH BASIN	
STORM DRAIN JUNCTION BOX	
STORM DRAIN MANHOLE	
BACK FLOW PREVENTION DEVICE	
FIRE DEPARTMENT CONNECTION	
FIRE HYDRANT & VALVE	
POST INDICATOR VALVE	
SANITARY SEWER MANHOLE	
SINGLE CHECK VALVE	
STORM DRAIN MANHOLE	
WATER METER	



COMMERCIAL: $0.00685\text{CFS}/\text{ACRE} \times 1.377\text{AC} = 0.0094\text{ CFS}$
 $0.0094\text{ CFS} = 6,075\text{ GAL/DAY}$
TOTAL: 6,075 GAL/DAY (DRY CONDITIONS)
PEAK TOTAL: $6,075 \times 2.5 = 15,188\text{ GAL/DAY}$



COMMERCIAL: $0.00685\text{CFS}/\text{ACRE} \times 3.389\text{AC} = 0.0232\text{ CFS}$
 $0.0232\text{ CFS} = 14,995\text{ GAL/DAY}$
TOTAL: 14,995 GAL/DAY (DRY CONDITIONS)
PEAK TOTAL: $14,995 \times 2.5 = 37,488\text{ GAL/DAY}$

NET TOTAL: 14,995 - 6,075 = 8,920 GAL/DAY
8,920 GAL/DAY (DRY CONDITIONS)
NET PEAK TOTAL: 37,488 - 15,188 = 22,300 GAL/DAY
22,300 GAL/DAY (PEAK CONDITIONS)

OFFICE: (14,995 GAL/DAY) / 0.95 = 15,784 GAL/DAY
TOTAL: 15,784 GAL/DAY (DRY CONDITIONS)
PEAK TOTAL: 15,784 X 2.5 = 39,460 GAL/DAY

1. GAS METERS SHALL BE LOCATED WITHIN THE BUILDING.
2. ALL HYDRANTS ALONG THE PROJECT FRONTAGE SHALL BE CLOW MODEL 960. EXISTING HYDRANTS TO BE PROTECTED SHALL BE UPGRADED.
3. TRASH CAPTURE DEVICE SHALL BE INSTALLED ON DOWNSTREAM PRIVATE CATCH BASIN PRIOR TO DISCHARGING TO PUBLIC SYSTEM.

AD	AREA DRAIN
BSM	BIO SOIL MIX
FL	FLOW LINE
GF	GARAGE FINISHED FLOOR
HP	HIGH POINT
IE	INVERT
RE	RIM ELEVATION
TC	TOP OF CURB
TW	TOP OF WALL
	STORM DRAIN LINE
▲	AREA DRAIN
▣	STORM DRAIN CATCH BASIN
■	STORM DRAIN JUNCTION BOX
●	STORM DRAIN MANHOLE
—	BACK FLOW PREVENTION DEVICE
+	FIRE DEPARTMENT CONNECTION
⊕	FIRE HYDRANT & VALVE
—	POST INDICATOR VALVE
SSMH●	SANITARY SEWER MANHOLE
SM●	SEWER CHECK VALVE
SDMH●	STORM DRAIN MANHOLE
—	WATER METER

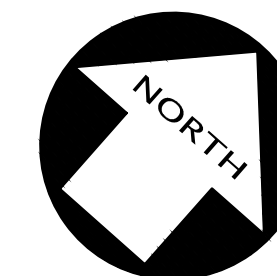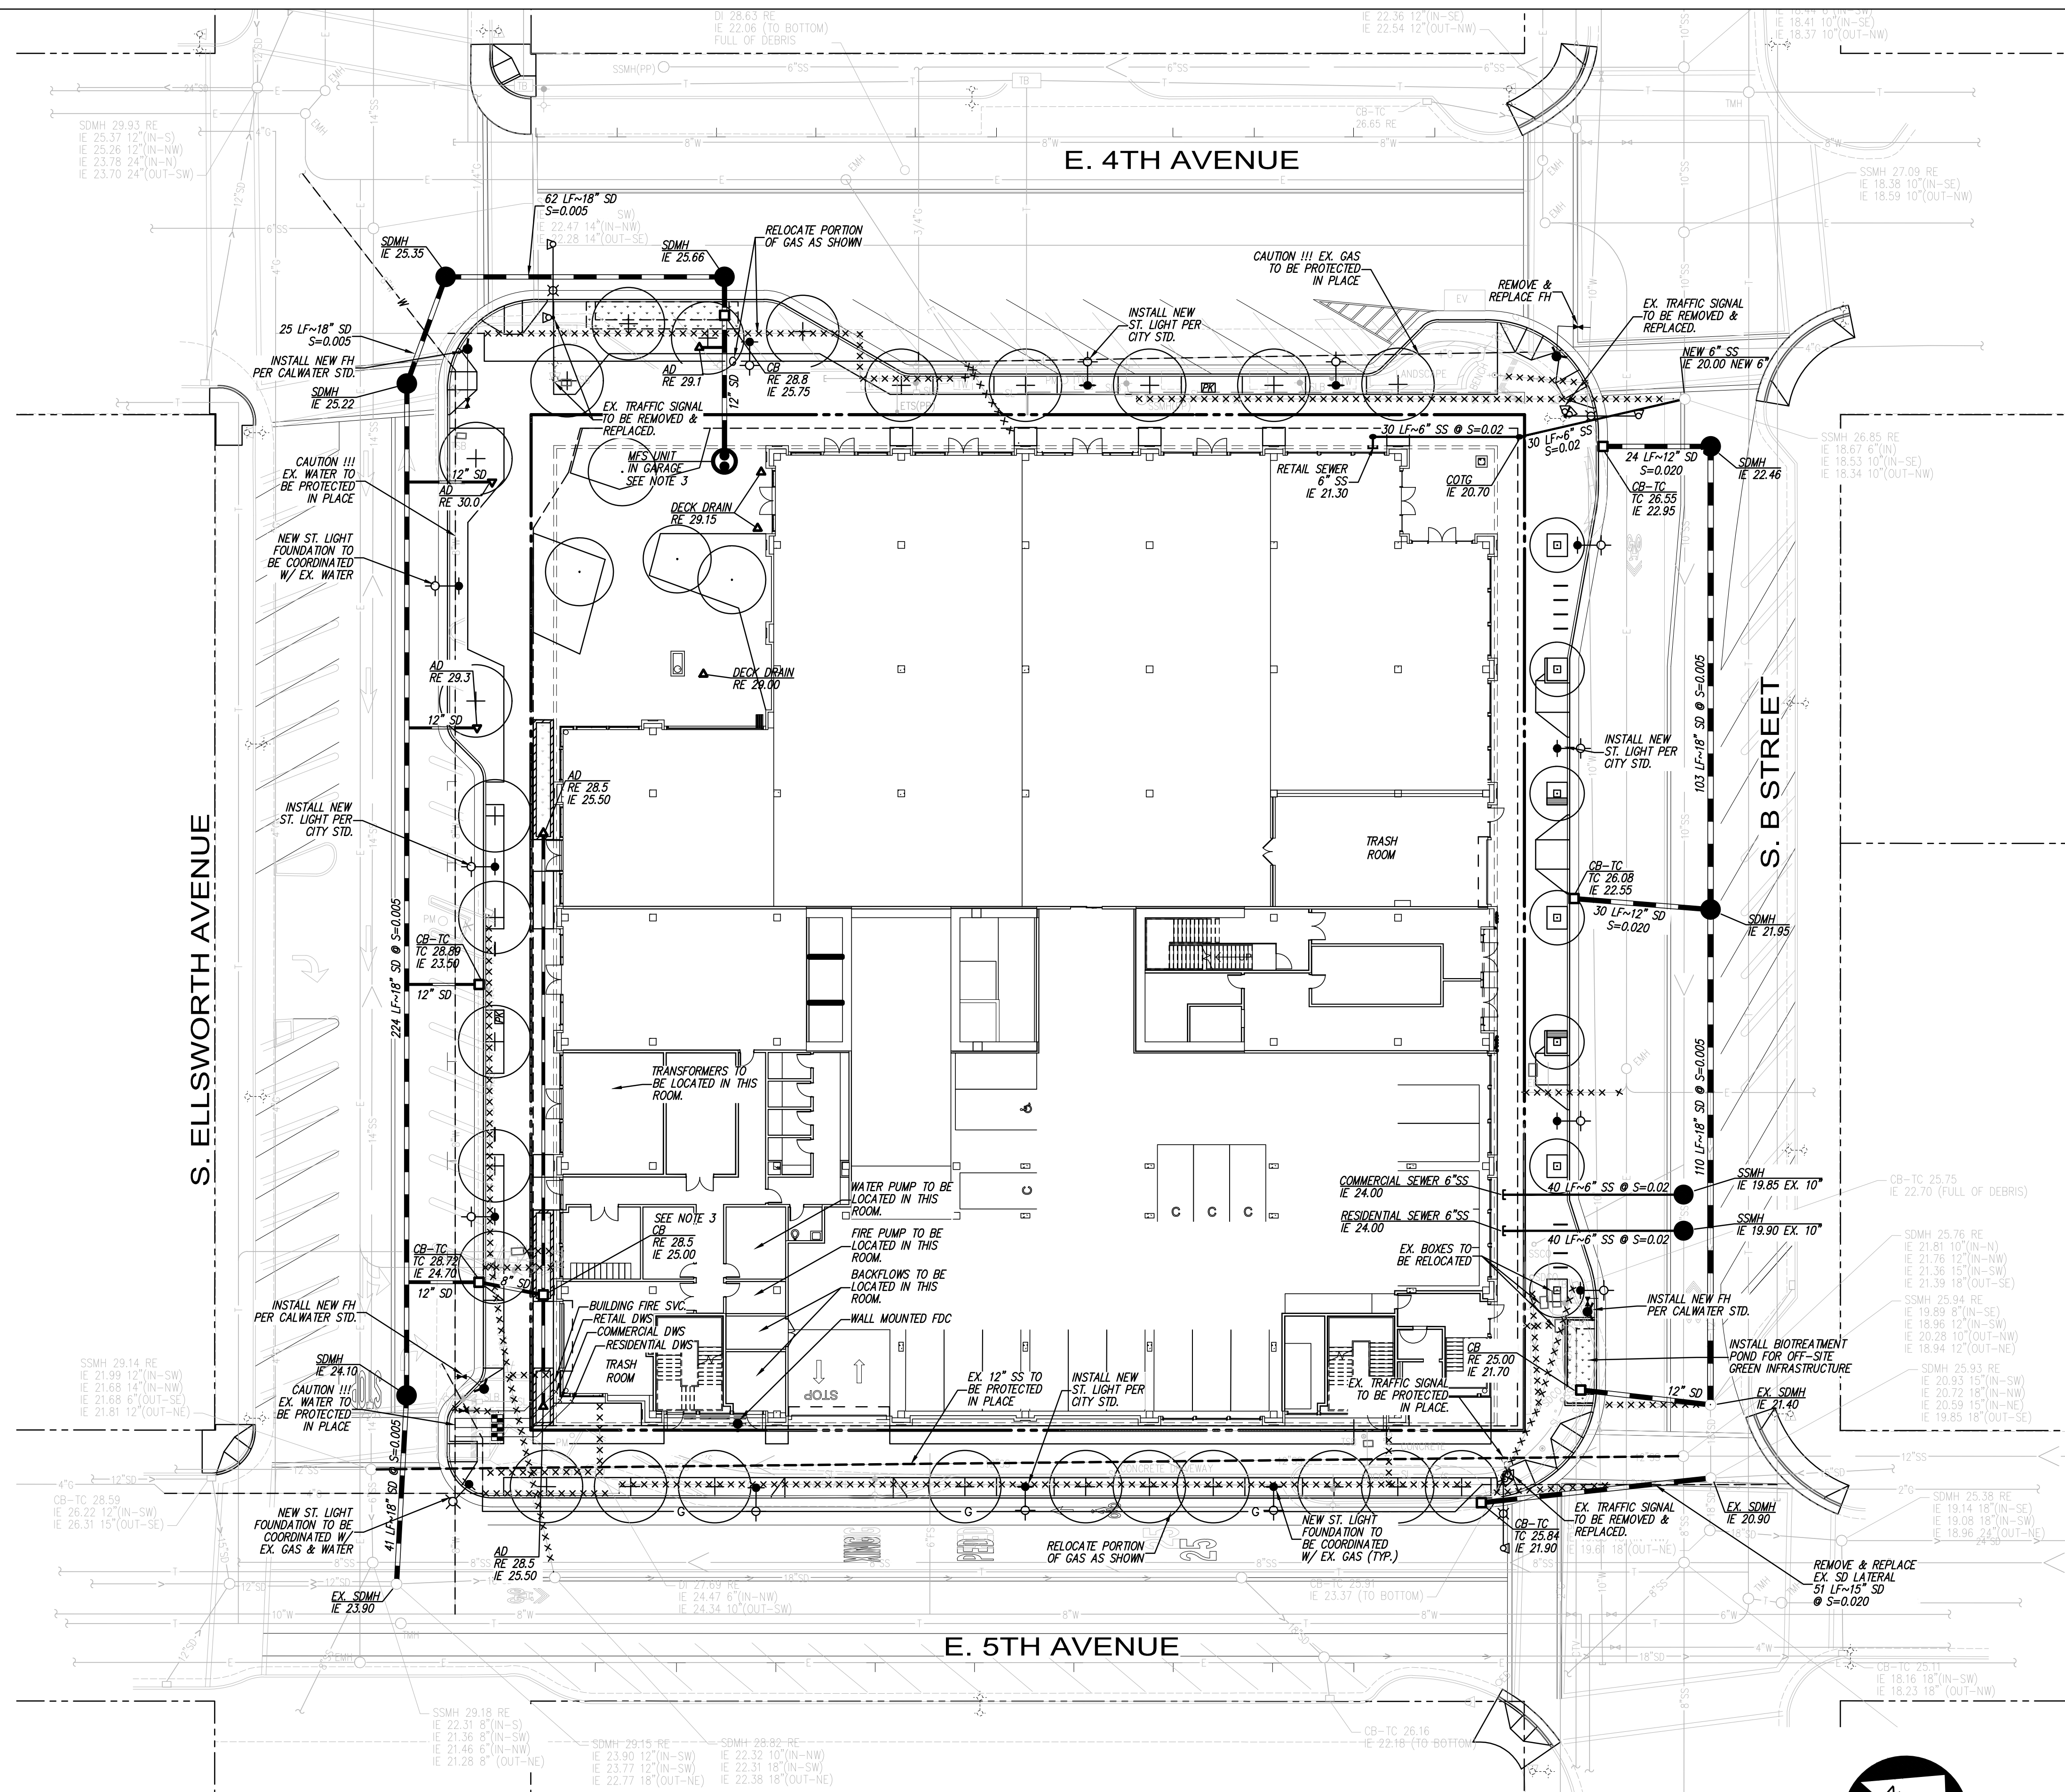

C4.00

Manufactured Stormwater Treatment Measure Maintenance Plan
for

222 E. 4TH STREET

February 2020

Manufactured Stormwater Treatment Measures are **PROPRIETARY** treatment devices that tend to be installed below ground and operate using some type of proprietary filter media, hydrodynamic separation, or sedimentation and screening. Common examples of manufactured treatment measures include manufactured media filters, inlet filters or drain inserts, oil/water separators and hydrodynamic separators. In August 2004, the Regional Water Board's Executive Office wrote a letter stating that a project relying on inlet filters or oil/water separators as the sole treatment measure would be unlikely to meet the maximum extent practicable standard of the National Pollutant Discharge Elimination System Permit. See the Countywide C.3 Technical Guidance (www.flowstobay.org) for more information.

Project Address: 222 E. 4th Street

Assessor's parcel #: APN 034-017-176

Property Owner: Lane Partners Phone No.: (650)-838-0100

Designated Contact: Marcus Gilmour Phone No.: (650)-838-0100

Mailing Address: 644 Menlo Avenue 2nd Floor, Menlo Park, CA 94025

The property contains one Oldcastle Perk Filter located as described below and as shown in the attached site plan.

Perk Filter is located at Southeasterly corner of property.

I. Routine Maintenance Activities

The principal maintenance objective is to prevent sediment buildup and clogging, which reduces pollutant removal efficiency and may lead to failure of the manufactured treatment measure. Routine maintenance activities, and the frequency at which they will be conducted, are shown in Table 1.

Table 1 Routine Maintenance Activities for Manufactured Treatment Measures		
No.	Maintenance Task	Frequency of Task
1	Inspect for standing water, sediment, trash and debris.	Monthly during rainy season
2	Remove sediment, trash and debris from sedimentation basin, riser pipe and filter bed, using vector truck method. Dispose of sediment, trash, filters and debris properly.	As needed
3	Ensure that manufactured treatment measure drains completely within five days.	After major storm events and as needed.
4	Inspect outlets to ensure proper drainage.	Monthly during rainy season, or as needed after storm events

5	Follow manufacturer's guidelines for maintenance and cartridge replacement.	As per manufacturer's specifications.
6	Inspect manufactured treatment measure, using the attached inspection checklist.	Monthly, or after large storm events, and after removal of accumulated debris or material

II. Prohibitions

Trees and other large vegetation shall be prevented from growing adjacent to the manufactured treatment measure to prevent damage.

Standing water shall not remain in the treatment measures for more than five days, to prevent mosquito generation. Should any mosquito issues arise, contact the San Mateo County Mosquito Abatement District (SMCMAD), as needed for assistance. Mosquito larvicides shall be applied only when absolutely necessary, as indicated by the SMCMAD, and then only by a licensed professional or contractor. Contact information for SMCMAD is provided below.

III. Mosquito Abatement Contact Information


San Mateo County Mosquito Abatement District
1351 Rollins Road
Burlingame, CA 94010
PH: (650) 344-8592
FAX: (650) 344-3843
Email: info@smcmad.org

IV. Inspections

The attached Treatment Measure Inspection and Maintenance Checklist shall be used to conduct inspections monthly (or as needed), identify needed maintenance, and record maintenance that is conducted.


TREATMENT CONTROL MEASURE SUMMARY TABLE																			
DMA #	TCM #	Location	Treatment Type	LID or Non-LID	Sizing Method	Drainage Area (s.f.)	Impervious Area (s.f.)	Pervious Area (Permeable Pavement) (s.f.)	Pervious Area (Other) (s.f.)	% Onsite Area Treated by LID or Non-LID TCM	Bioretention Area Required (s.f.)	Bioretention Area Provided (s.f.)	Overflow Riser Height (in)	Storage Depth Required (ft)	Storage Depth Provided (ft)	# of Cartridges Required	# of Cartridges Provided	Media Type	Cartridge Height (inches)
1	N/A	Onsite	Proprietary Media Filter System (MFS)	Non-LID	N/A	14,204	13,138	0	1,066	28.71%	N/A	N/A	N/A	N/A	N/A	3	3		18
2	2	Onsite	Flow-Through planter (concrete lined) w/ underdrain	LID	3. Flow-Volume Combo	2,243	2,024	0	219	4.53%	81 sf	81	6	6	6	N/A	N/A	N/A	N/A
3	3	Onsite	Flow-Through planter (concrete lined) w/ underdrain	LID	3. Flow-Volume Combo	1,728	1,649	0	79	3.49%	66 sf	66	6	6	6	N/A	N/A	N/A	N/A
4	4	Onsite	Flow-Through planter (concrete lined) w/ underdrain	LID	3. Flow-Volume Combo	1,535	1,455	0	80	3.10%	58 sf	58	6	6	6	N/A	N/A	N/A	N/A
5	5	Onsite	Flow-Through planter (concrete lined) w/ underdrain	LID	3. Flow-Volume Combo	2,386	2,286	0	100	4.82%	91 sf	91	6	6	6	N/A	N/A	N/A	N/A
6	6	Onsite	Flow-Through planter (concrete lined) w/ underdrain	LID	3. Flow-Volume Combo	3,314	3,186	0	128	6.70%	127 sf	127	6	6	6	N/A	N/A	N/A	N/A
7	7	Onsite	Flow-Through planter (concrete lined) w/ underdrain	LID	3. Flow-Volume Combo	2,351	2,259	0	92	4.75%	90 sf	90	6	6	6	N/A	N/A	N/A	N/A
8	8	Onsite	Flow-Through planter (concrete lined) w/ underdrain	LID	3. Flow-Volume Combo	4,102	3,942	0	160	8.29%	158 sf	158	6	6	6	N/A	N/A	N/A	N/A
9	9	Onsite	Flow-Through planter (concrete lined) w/ underdrain	LID	3. Flow-Volume Combo	2,577	2,466	0	111	5.21%	99 sf	99	6	6	6	N/A	N/A	N/A	N/A
10	10	Onsite	Flow-Through planter (concrete lined) w/ underdrain	LID	3. Flow-Volume Combo	1,515	1,455	0	60	3.06%	58 sf	58	6	6	6	N/A	N/A	N/A	N/A
11	11	Onsite	Flow-Through planter (concrete lined) w/ underdrain	LID	3. Flow-Volume Combo	525	343	0	182	1.08%	14 sf	14	6	6	6	N/A	N/A	N/A	N/A
12	12	Onsite	Flow-Through planter (concrete lined) w/ underdrain	LID	3. Flow-Volume Combo	2,490	2,390	0	100	5.03%	96 sf	96	6	6	6	N/A	N/A	N/A	N/A
13	13	Onsite	Flow-Through planter (concrete lined) w/ underdrain	LID	3. Flow-Volume Combo	3,306	3,178	0	128	6.68%	127 sf	127	6	6	6	N/A	N/A	N/A	N/A
14	14	Onsite	Flow-Through planter (concrete lined) w/ underdrain	LID	3. Flow-Volume Combo	3,306	3,178	0	128	6.68%	127 sf	127	6	6	6	N/A	N/A	N/A	N/A
15	15	Onsite	Flow-Through planter (concrete lined) w/ underdrain	LID	3. Flow-Volume Combo	3,885	3,716	0	169	7.85%	149 sf	149	6	6	6	N/A	N/A	N/A	N/A
Totals:						49,487	46,665	0	2,802	100.00%									

DMA #	TCM #	Location	Treatment Type	LID or Non-LID	Sizing Method	Drainage Area (s.f.)	Impervious Area (s.f.)	Pervious Area (Permeable Pavement) (s.f.)	Pervious Area (Other) (s.f.)	% Off-Site Area Treated by LID or Non-LID TCM	Bioretention Area Required (s.f.)	Bioretention Area Provided (s.f.)	Overflow Riser Height (in)	Storage Depth Required (ft)	Storage Depth Provided (ft)	# of Cartridges Required	# of Cartridges Provided	Media Type	Cartridge Height (inches)
16	16	Onsite	Bioretention unlined w/ underdrain	LID	2C. Flow. 4% Method **	1,922	1,652	0	270	45.26%	66 sf	66	6	6	6	N/A	N/A	N/A	N/A
17	17	Onsite	Bioretention unlined w/ underdrain	LID	2C. Flow. 4% Method **	2,325	1,765	0	560	54.74%	71 sf	71	6	6	6	N/A	N/A	N/A	N/A
Totals:						4,247	3,417	0	830	100.00%									

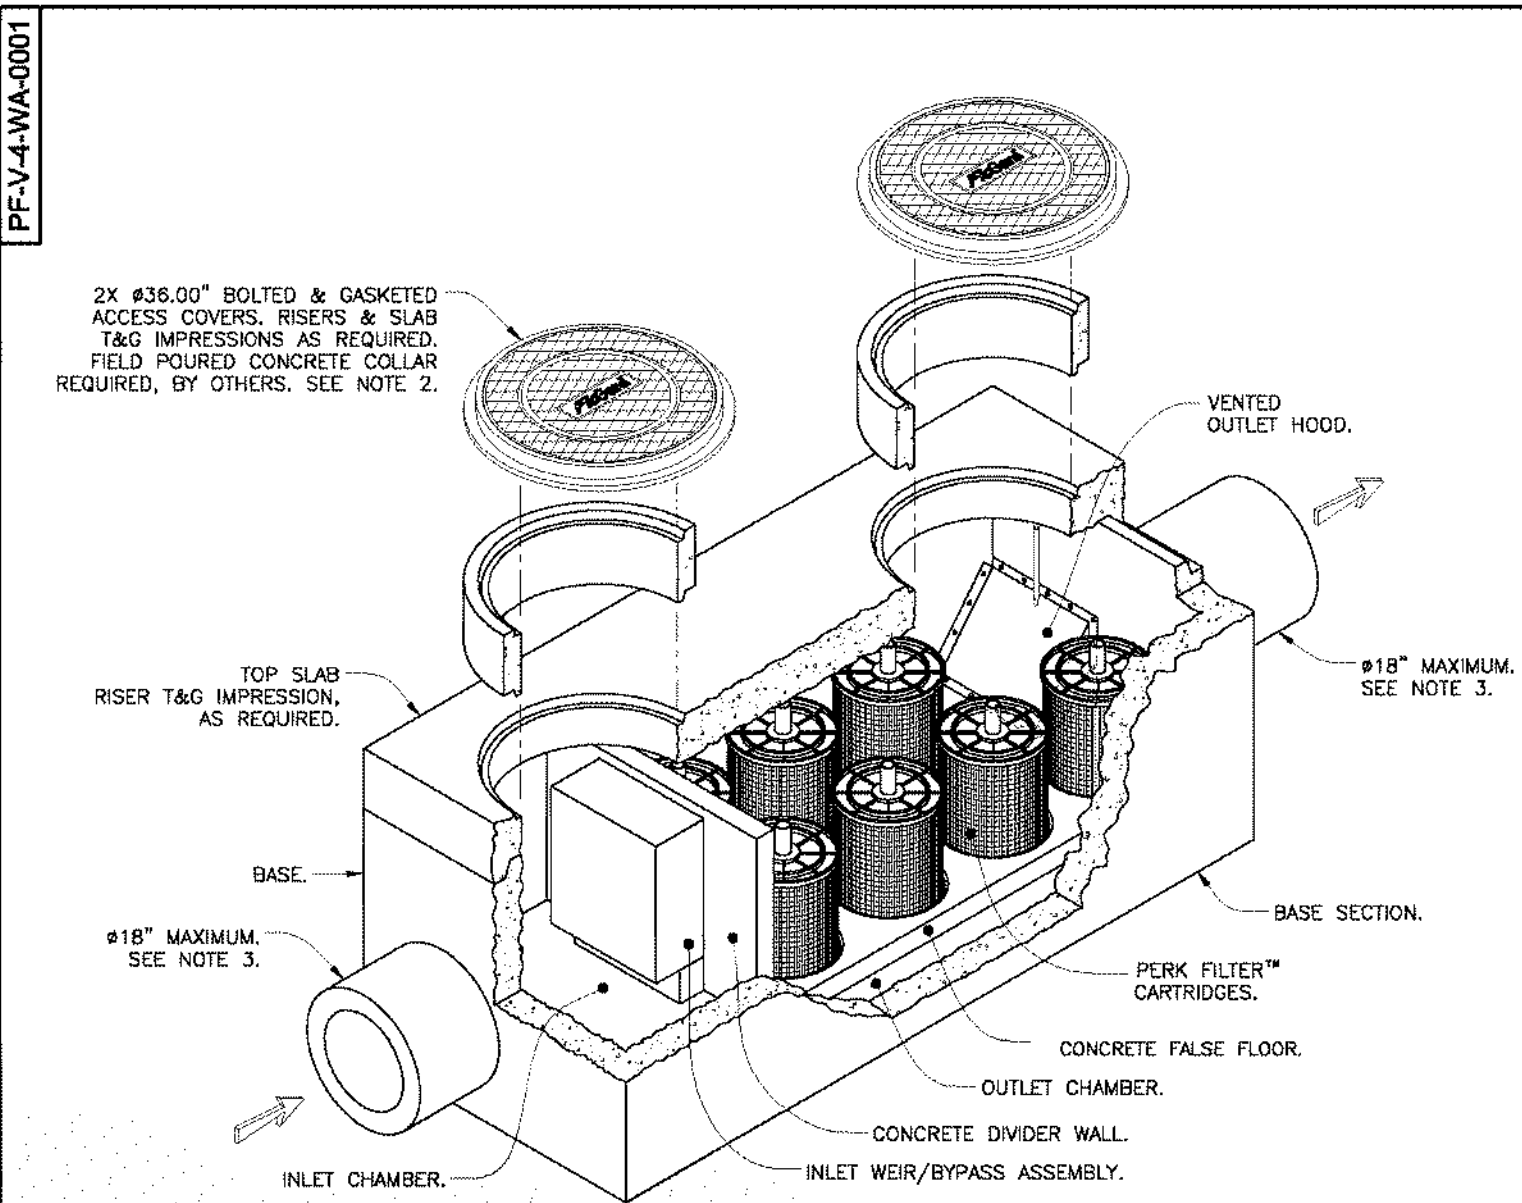

Notes:


- Precast concrete structure shall be manufactured in accordance with ASTM Designation C857 and C858.
- Filter system shall be supplied with traffic rated (H20) bolted & gasketed Ø36" circular access covers with risers as required. Shallow applications may require configurations with (H20) bolted & gasketed square/rectangular access hatches. Field poured concrete collars required, by others.
- Inlet & outlet pipe(s) (Ø 18" maximum) may enter device on all three sides of the inlet & outlet chambers respectively.
- Inlet chamber shall be supplied with a drain-down device designed to remove standing water between storm events.
- For depths less than specified minimums contact Oldcastle® Stormwater Solutions for engineering assistance.

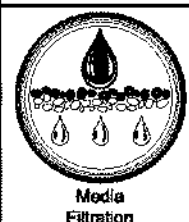

Perk Filter™
4' Wide Concrete Vault
Washington State GULD
Three to Seven Cartridges / Stacks




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Drawing No. PF-V-4-WA-0001 D ECD-0122 JPR 10/3/14 JPR 3/2/11 SHEET 1 OF 2

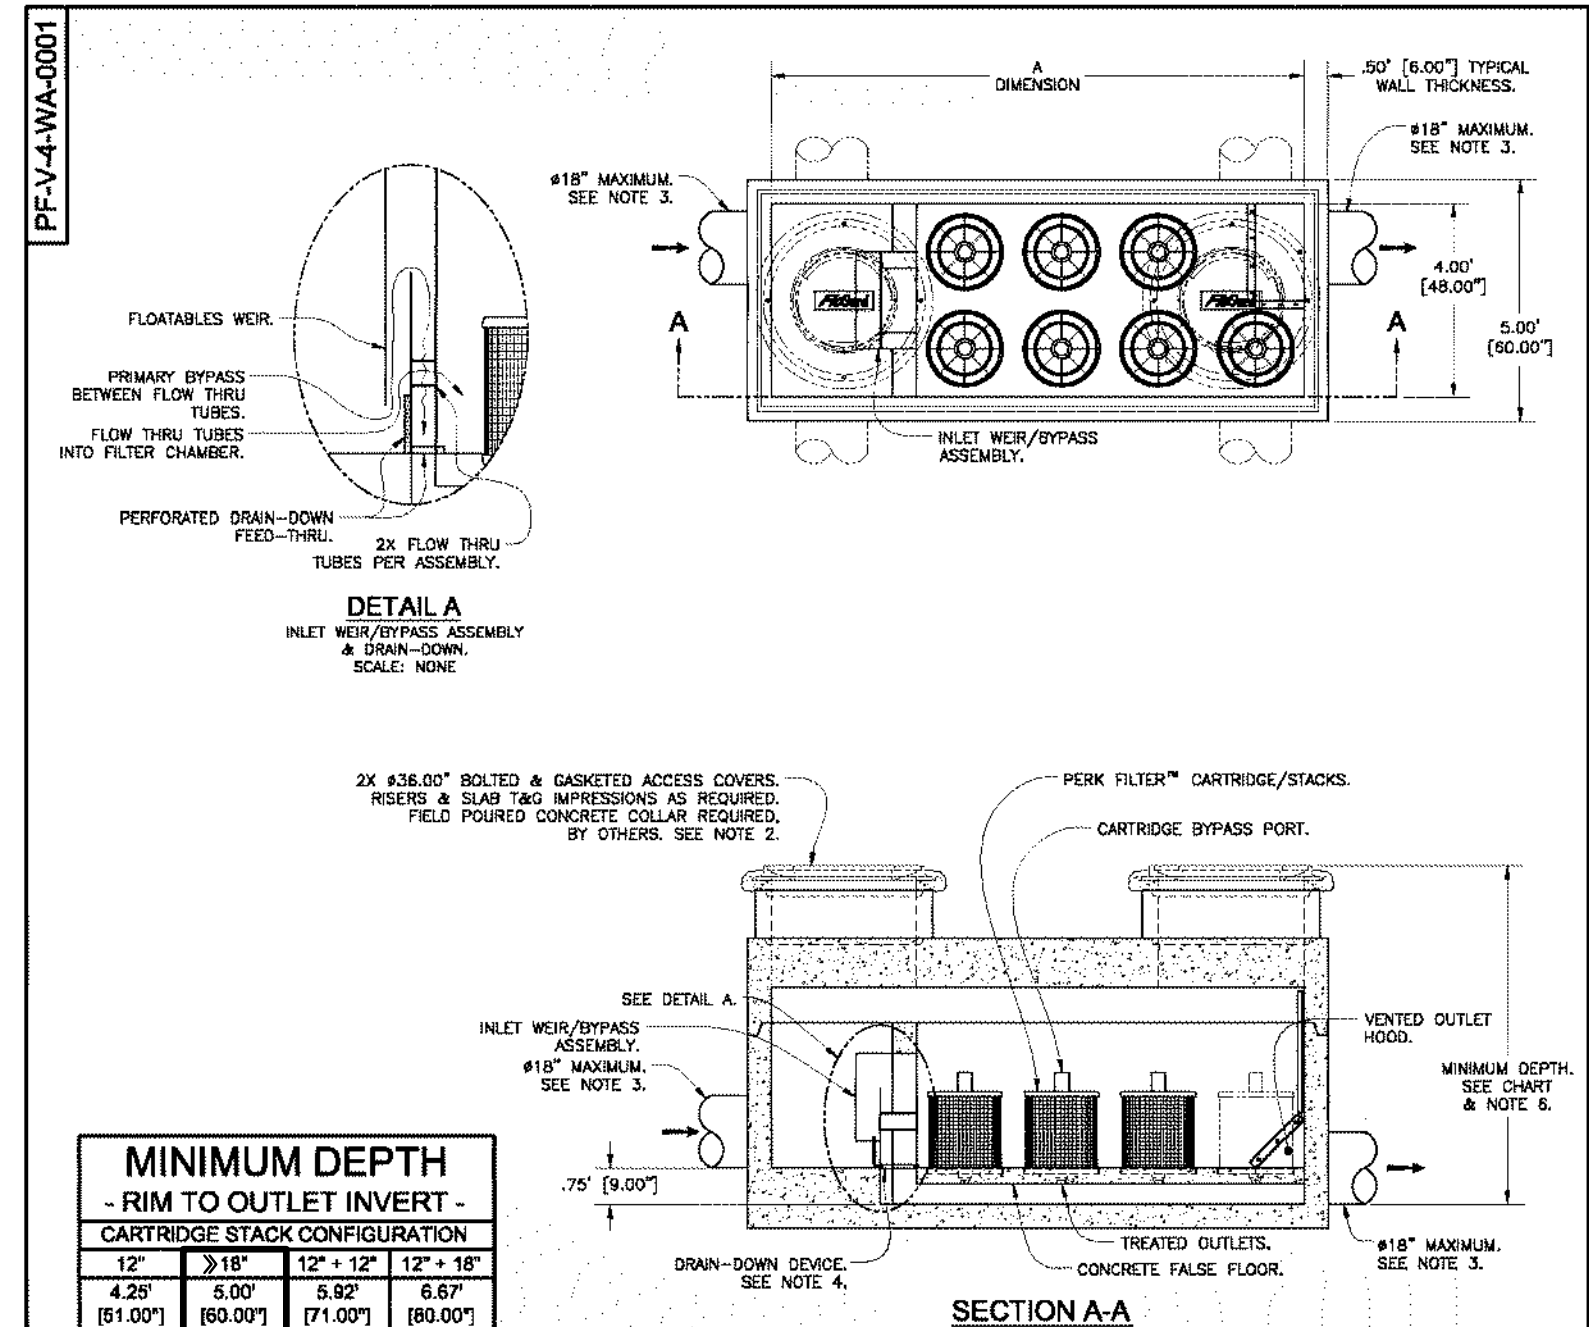

MINIMUM DEPTH RIM TO OUTLET INVERT - CARTRIDGE STACK CONFIGURATION			
12"	3'18"	12" x 12"	12" x 18"
4.26'	5.00'	5.82'	6.67'
[81.00"]	[80.00"]	[71.00"]	[80.00"]

4' VAULT TREATMENT FLOW RATES, TOTAL FLOW CAPACITIES & MAXIMUM HEAD LOSS									
CARTRIDGE STACK QUANTITY	A DIMENSION (ID-FEET)	12"				12" x 12"			
		TREATMENT FLOW RATE (GPM/CFS)	TOTAL FLOW CAPACITY (CFS)	TREATMENT FLOW RATE (GPM/CFS)	TOTAL FLOW CAPACITY (CFS)	TREATMENT FLOW RATE (GPM/CFS)	TOTAL FLOW CAPACITY (CFS)	TREATMENT FLOW RATE (GPM/CFS)	TOTAL FLOW CAPACITY (CFS)
3	7	20.4 / 0.045	2.9	30.8 / 0.068	4.3	40.8 / 0.091	5.0	51.2 / 0.114	6.7
4	9	27.2 / 0.061	2.9	40.8 / 0.091	4.4	54.4 / 0.121	5.0	68.0 / 0.152	6.8
5	9	34.0 / 0.075	2.9	51.0 / 0.114	4.4	68.0 / 0.152	5.1	85.0 / 0.190	6.8
6	11	40.8 / 0.091	3.0	61.2 / 0.136	4.5	81.6 / 0.182	5.1	102.0 / 0.227	6.9
7	11	47.6 / 0.106	3.0	71.4 / 0.159	4.5	98.2 / 0.212	5.2	118.0 / 0.265	7.0
MAXIMUM HEAD LOSS		1.7 FEET				2.9 FEET			

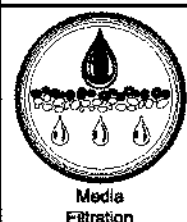

Perk Filter™
4' Wide Concrete Vault
Washington State GULD
Three to Seven Cartridges / Stacks



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Drawing No. PF-V-4-WA-0001 D ECD-0122 JPR 10/3/14 JPR 3/2/11 SHEET 2 OF 2

222 EAST 4TH

LANE PARTNERS

LANE PARTNERS



ARCHITECTS
KORTH SUNSERI HAGEY



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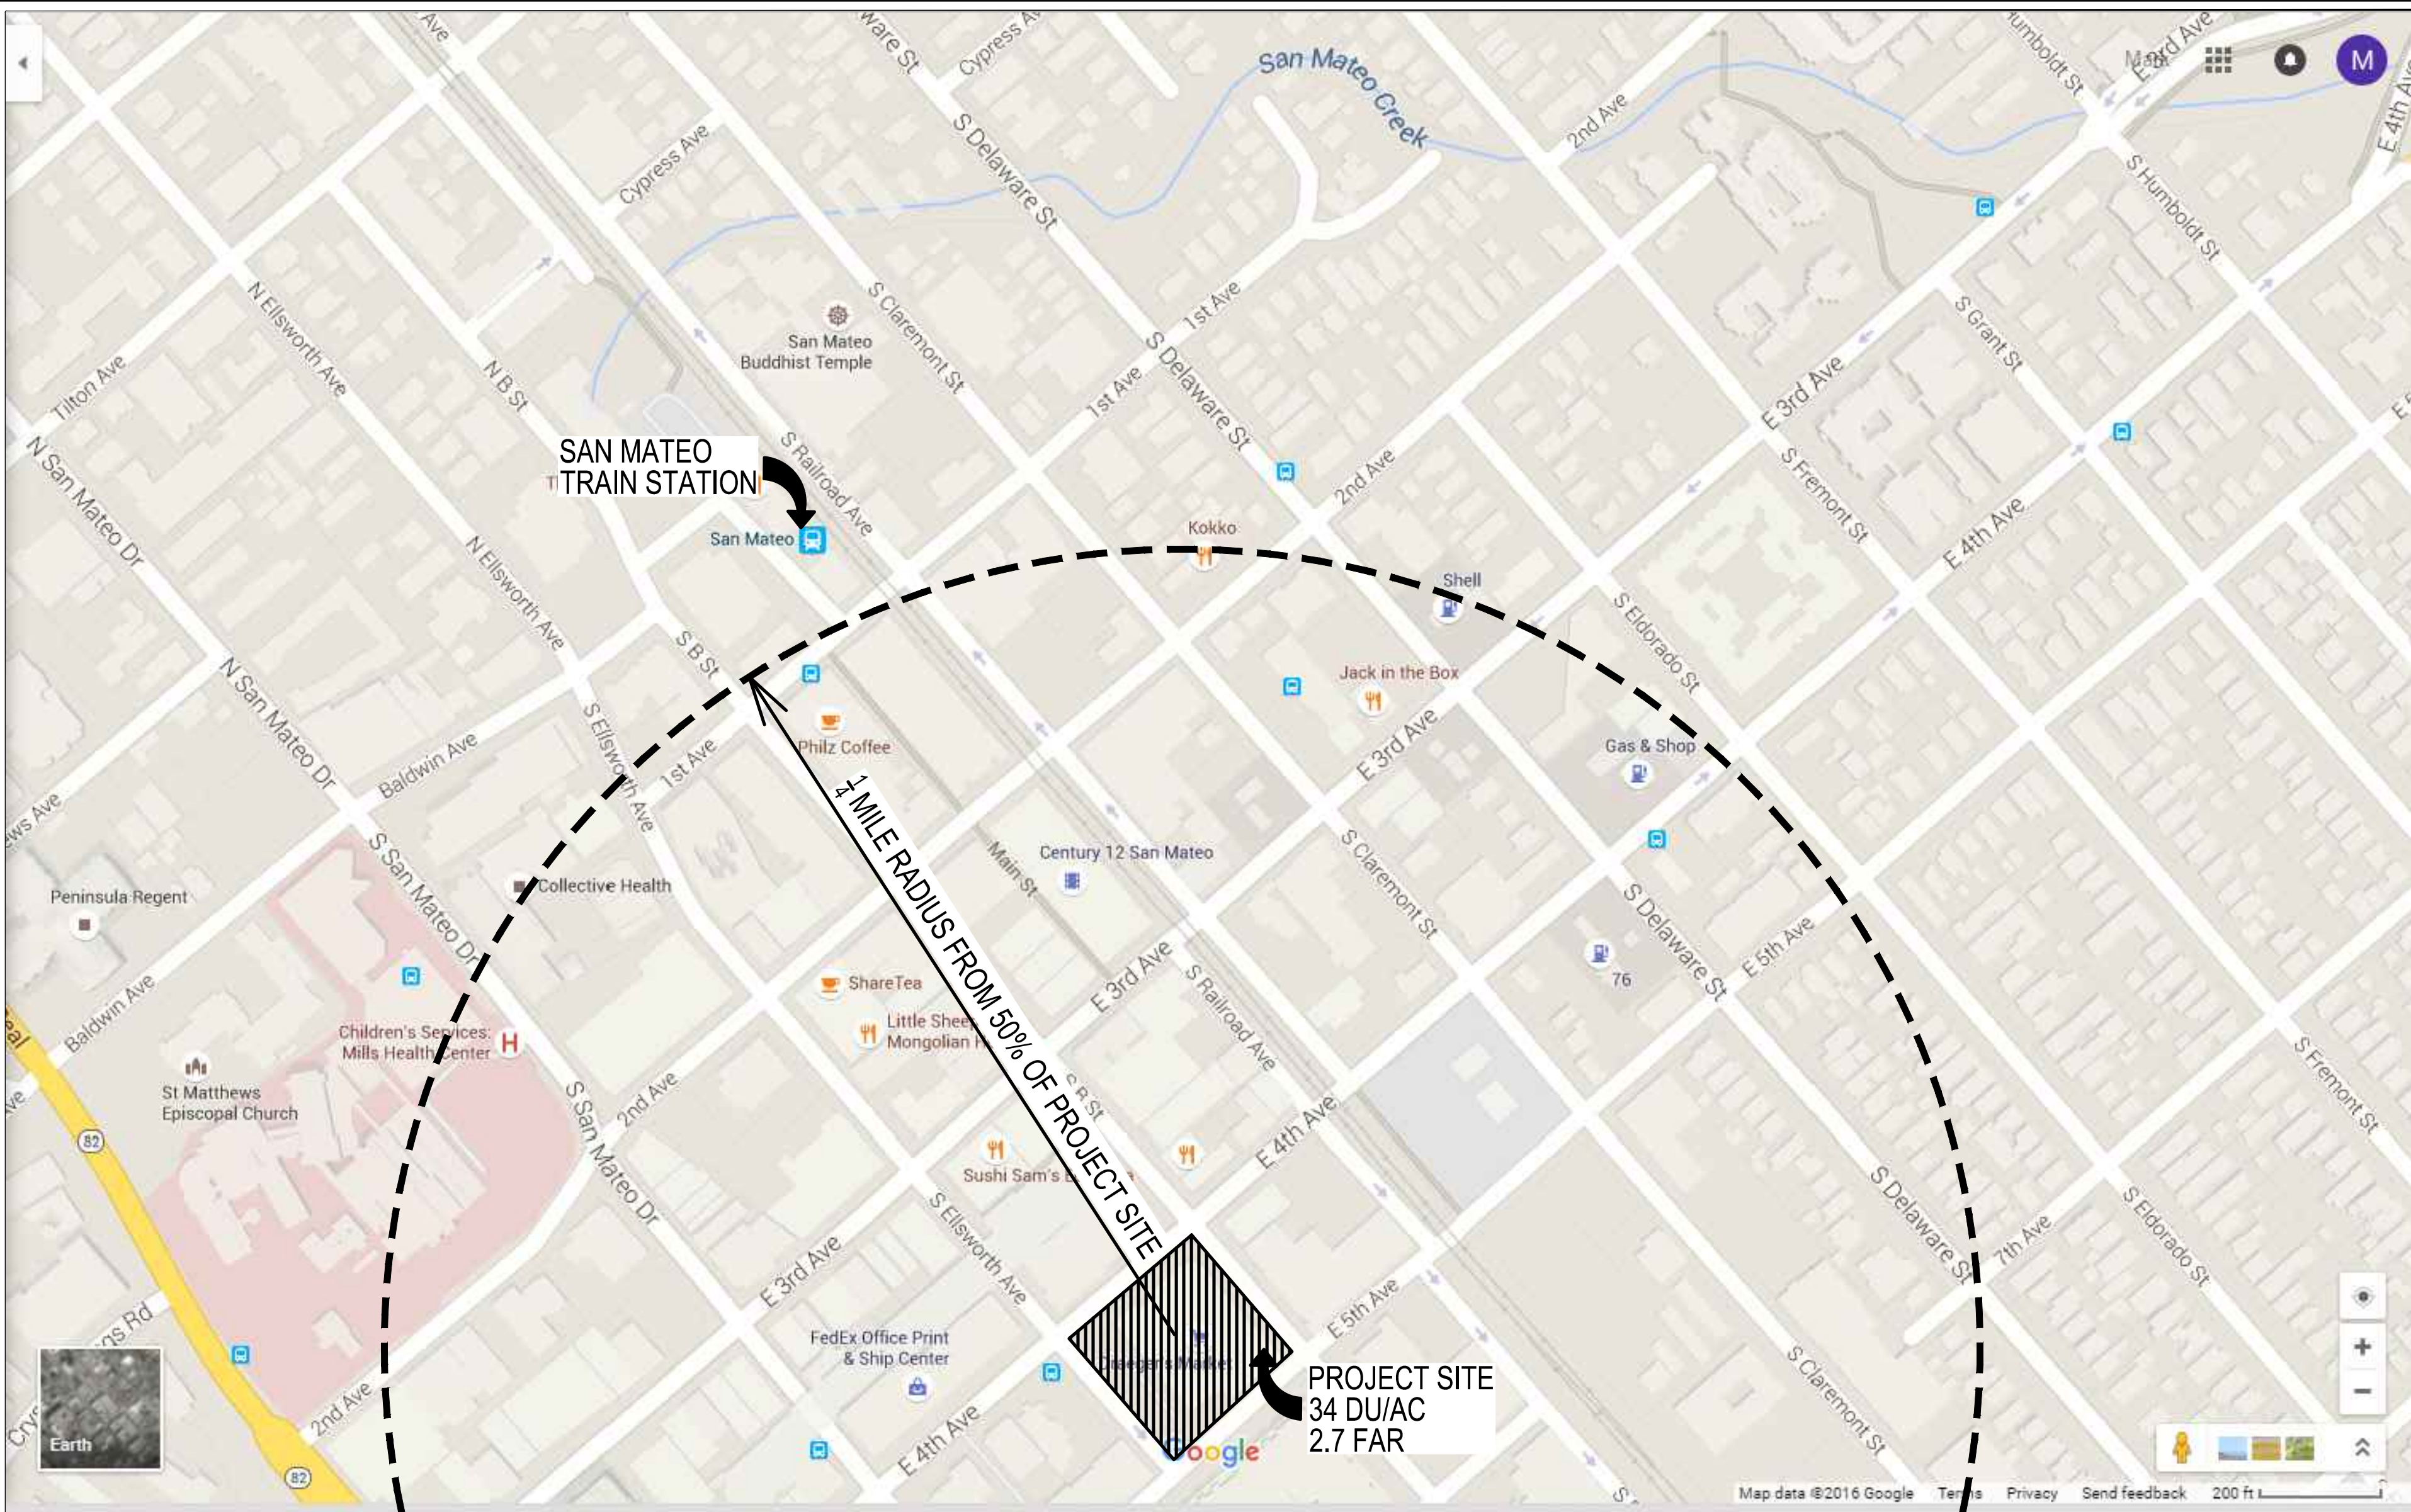
SHEET TITLE
**PRELIMINARY
STORMWATER QUALITY
CONTROL NOTES, DETAILS
& CALCULATIONS**

SCALE
AS SHOWN

SHEET NUMBER

C5.01

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J.4 Category C: Transit-Oriented Development

The defining criteria and LID treatment reduction credits for Category C projects are described below.

CRITERIA FOR CATEGORY C (TRANSIT ORIENTED DEVELOPMENT) SPECIAL PROJECTS

To be considered a Category C Special Project, a Provision C.3 Regulated Project must meet all of the following criteria:

1. Be characterized as a non-auto-related land use project. That is, Category C specifically excludes any Regulated Project that is a stand-alone surface parking lot; car dealership; auto and truck rental facility with onsite surface storage; fast-food restaurant, bank or pharmacy with drive-through lanes; gas station, car wash, auto repair and service facility; or other auto-related project unrelated to the concept of Transit-Oriented Development.
2. If a commercial project, achieve at least an FAR of 2:1.
3. If a residential development project, achieve at least a gross density of 25 DU/AC.
4. If a mixed-use development project, achieve an FAR of at least 2:1, or a gross density of 25 DU/AC.

Worksheet F
Special Projects

C.3 and C.6 Development Review Checklist

Complete this worksheet for projects that appear to meet the definition of "Special Project," per Provision C.3.e.ii of the Municipal Regional Stormwater Permit (MRP). The form assists in determining whether a project meets Special Project criteria, and the percentage of low impact development (LID) treatment reduction credit. Special Projects that implement less than 100% LID treatment must provide a narrative discussion of the feasibility or infeasibility of 100% LID treatment. See Appendix J of the C.3 Technical Guidance Handbook (download at www.flowstobay.org) for more information.

F.1 "Special Project" Determination (Check the boxes to determine if the project meets any of the following categories.)

Special Project Category "A"

Does the project have ALL of the following characteristics?

- ☐ Located in a municipality's designated central business district, downtown core area or downtown core zoning district, neighborhood business district or comparable pedestrian-oriented commercial district, or historic preservation site and/or district¹⁵;
 - ☐ Creates and/or replaces 0.5 acres or less of impervious surface;
 - ☐ Includes no surface parking, except for incidental parking for emergency vehicle access, ADA access, and passenger or freight loading zones;
 - ☐ Has at least 85% coverage of the entire site by permanent structures. The remaining 15% portion of the site may be used for safety access, parking structure entrances, trash and recycling service, utility access, pedestrian connections, public uses, landscaping and stormwater treatment.
- ☐ No (continue) ☐ Yes – Complete Section F.2 below

Special Project Category "B"

Does the project have ALL of the following characteristics?

- ☐ Located in a municipality's designated central business district, downtown core area or downtown core zoning district, neighborhood business district or comparable pedestrian-oriented commercial district, or historic preservation site and/or district¹⁵;
 - ☐ Creates and/or replaces more than 0.5 acres of impervious area and less than 2.0 acres;
 - ☐ Includes no surface parking, except for incidental parking for emergency access, ADA access, and passenger or freight loading zones;
 - ☐ Has at least 85% coverage of the entire site by permanent structures. The remaining 15% portion of the site may be used for safety access, parking structure entrances, trash and recycling service, utility access, pedestrian connections, public uses, landscaping and stormwater treatment;
 - ☐ Minimum density of either 50 dwelling units per acre (for residential projects) or a Floor Area Ratio (FAR) of 2:1 (for commercial projects) - mixed use projects may use either criterion. **Note Change on 7/1/16¹⁶**
- ☐ No (continue) ☐ Yes – Complete Section F-2 below

Special Project Category "C"

Does the project have ALL of the following characteristics?

- ☒ At least 50% of the project area is within 1/2 mile of an existing or planned transit hub¹⁷ or 100% within a planned Priority Development Area¹⁸;
 - ☒ The project is characterized as a non-auto-related use¹⁹; and
 - ☒ Minimum density of either 25 dwelling units per acre (for residential projects) or a Floor Area Ratio (FAR) of 2:1 (for commercial projects) - mixed use projects may use either criterion. **Note Change on 7/1/16¹⁶**
- ☐ No (continue) ☒ Yes – Complete Section F-2 below

¹⁵ And built as part of a municipality's stated objective to preserve/enhance a pedestrian-oriented type of urban design.

¹⁶ **Effective 7/1/16**, the MRP establishes definitions for "Gross Density" (GD) & FAR. GD is defined as, "the total number of residential units divided by the acreage of the entire site area, including land occupied by public right-of-ways, recreational, civic, commercial and other non-residential uses." FAR is defined as, "the Ratio of the total floor area on all floors of all buildings at a project site (except structures, floors, or floor areas dedicated to parking) to the total project site area."

¹⁷ "Transit hub" is defined as a rail, light rail, or commuter rail station, ferry terminal, or bus transfer station served by three or more bus routes. (A bus stop with no supporting services does not qualify.)

¹⁸ A "planned Priority Development Area" is an infill development area formally designated by the Association of Bay Area Government's / Metropolitan Transportation Commission's FOCUS regional planning program.

¹⁹ Category C specifically excludes stand-alone surface parking lots; car dealerships; auto and truck rental facilities with onsite surface storage; fast-food restaurants, banks or pharmacies with drive-through lanes; gas stations; car washes; auto repair and service facilities; or other auto-related project unrelated to the concept of transit oriented development.

8

5/8/18

C.3 and C.6 Development Review Checklist

F.2 LID Treatment Reduction Credit Calculation

(If more than one category applies, choose only one of the applicable categories and fill out the table for that category.)

Category	Impervious Area Created/Replaced (sq. ft.)	Site Coverage (%)	Project Density ¹⁹ or FAR ¹⁶	Density/Criteria	Allowable Credit (%)	Applied Credit (%)
A			N.A.	N.A.	100%	
B				Res ≥ 50 DU/ac or FAR ≥ 2:1 Res ≥ 75 DU/ac or FAR ≥ 3:1 Res ≥ 100 DU/ac or FAR ≥ 4:1	50% 75% 100%	
C	46,665	100	2.98	Location credit (select one)²⁰: Within ½ mile of transit hub Within ½ mile of transit hub Within a planned PDA Density credit (select one): Res ≥ 30 DU/ac or FAR ≥ 2:1 Res ≥ 60 DU/ac or FAR ≥ 4:1 Res ≥ 100 DU/ac or FAR ≥ 6:1 Parking credit (select one): ≤ 10% at-grade surface parking ²¹ No surface parking TOTAL TOD CREDIT =	 50% 25% 25% 10% 20% 30% 10% 20% 55	 25 10 20

F.3 Narrative Discussion of the Feasibility/Infeasibility of 100% LID Treatment:

If project will implement less than 100% LID, prepare a discussion of the feasibility or infeasibility of 100% LID treatment, as described in Appendix K of the C.3 Technical Guidance.

F.4 Select Certified Non-LID Treatment Measures:

If the project will include non-LID treatment measures, select a treatment measure certified for "Basic" General Use Level Designation (GULD) by the Washington State Department of Ecology's Technical Assessment Protocol – Ecology (TAPE). Guidance is provided in Appendix K of the C.3 Technical Guidance (download at www.flowstobay.org).²²

²⁰ To qualify for the location credit, at least 50% of the project's site must be located within the ½ mile or ¼ mile radius of an existing or planned transit hub, as defined on page 1, footnote 2. A planned transit hub is a station on the MTC's Regional Transit Expansion Program list, per MTC's Resolution 3434 (revised April 2006), which is a regional priority funding plan for future transit stations in the San Francisco Bay Area. To qualify for the PDA location credit, 100% of the project site must be located within a PDA, as defined on page 1, footnote 3.

²¹ The at-grade surface parking must be treated with LID treatment measures.

²² TAPE certification is used in order to satisfy Special Project's reporting requirements in the MRP.

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Phone: (408) 727-6665
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ISSUES AND REVISIONS

No.	Date	Description
A	05/05/2020	Pre-Application Set
B	10/21/2020	Pre-App Resubmittal
C	03/19/2021	Pre-App Resubmittal
D	10/15/2021	Pre-App Resubmittal
E	02/04/2022	Pre-App Resubmittal
F	04/22/2022	Pre-App Resubmittal
G	06/15/2022	Pre-App Resubmittal

PROJECT NUMBER
A19538-1

SHEET TITLE
PRELIMINARY LOW IMPACT
DEVELOPMENT REDUCTION
CALCULATIONS

SCALE
AS SHOWN

SHEET NUMBER

C5.02



Phone: (408) 727-6666
www.kierwright.com

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E	02/04/2022	Pre-App Resubmittal
F	04/22/2022	Pre-App Resubmittal
G	06/15/2022	Pre-App Resubmittal


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A19538-

SHEET TITLE
VEHICLE
TURNING
ANALYSIS


SCALE
AS SHOWN

SHEET NUMBER


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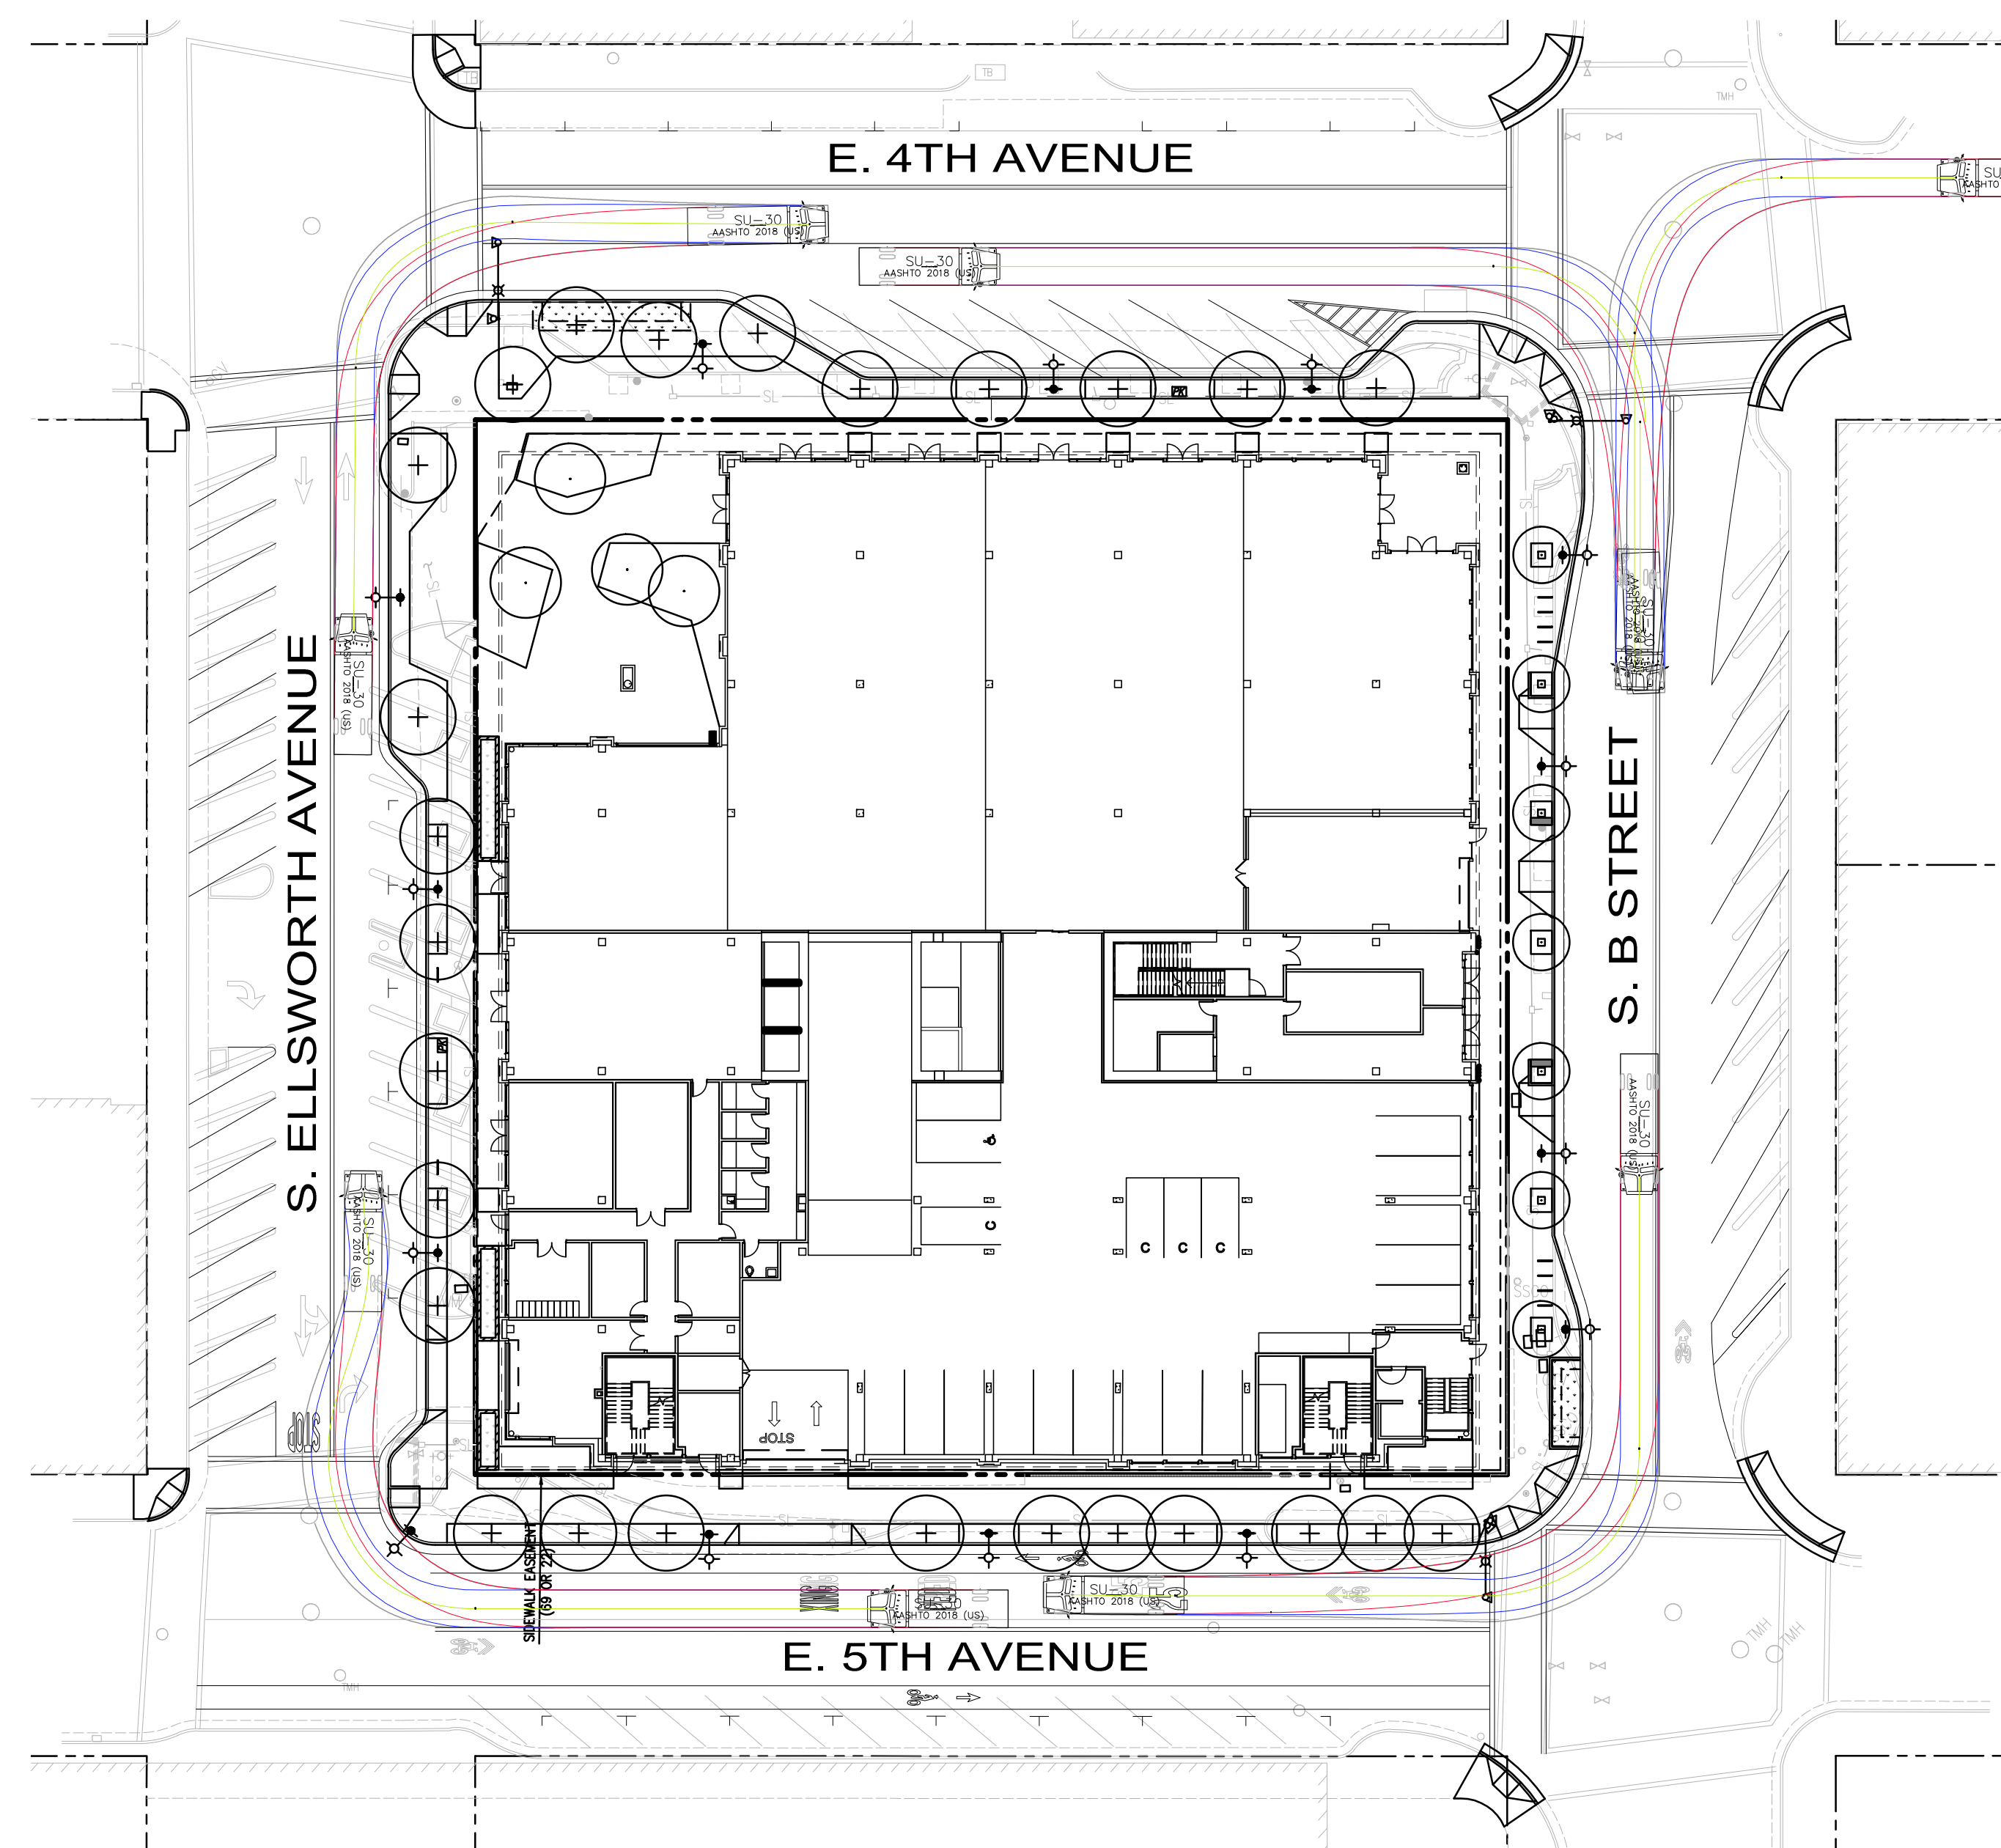
FIRE TRUCK TURNING

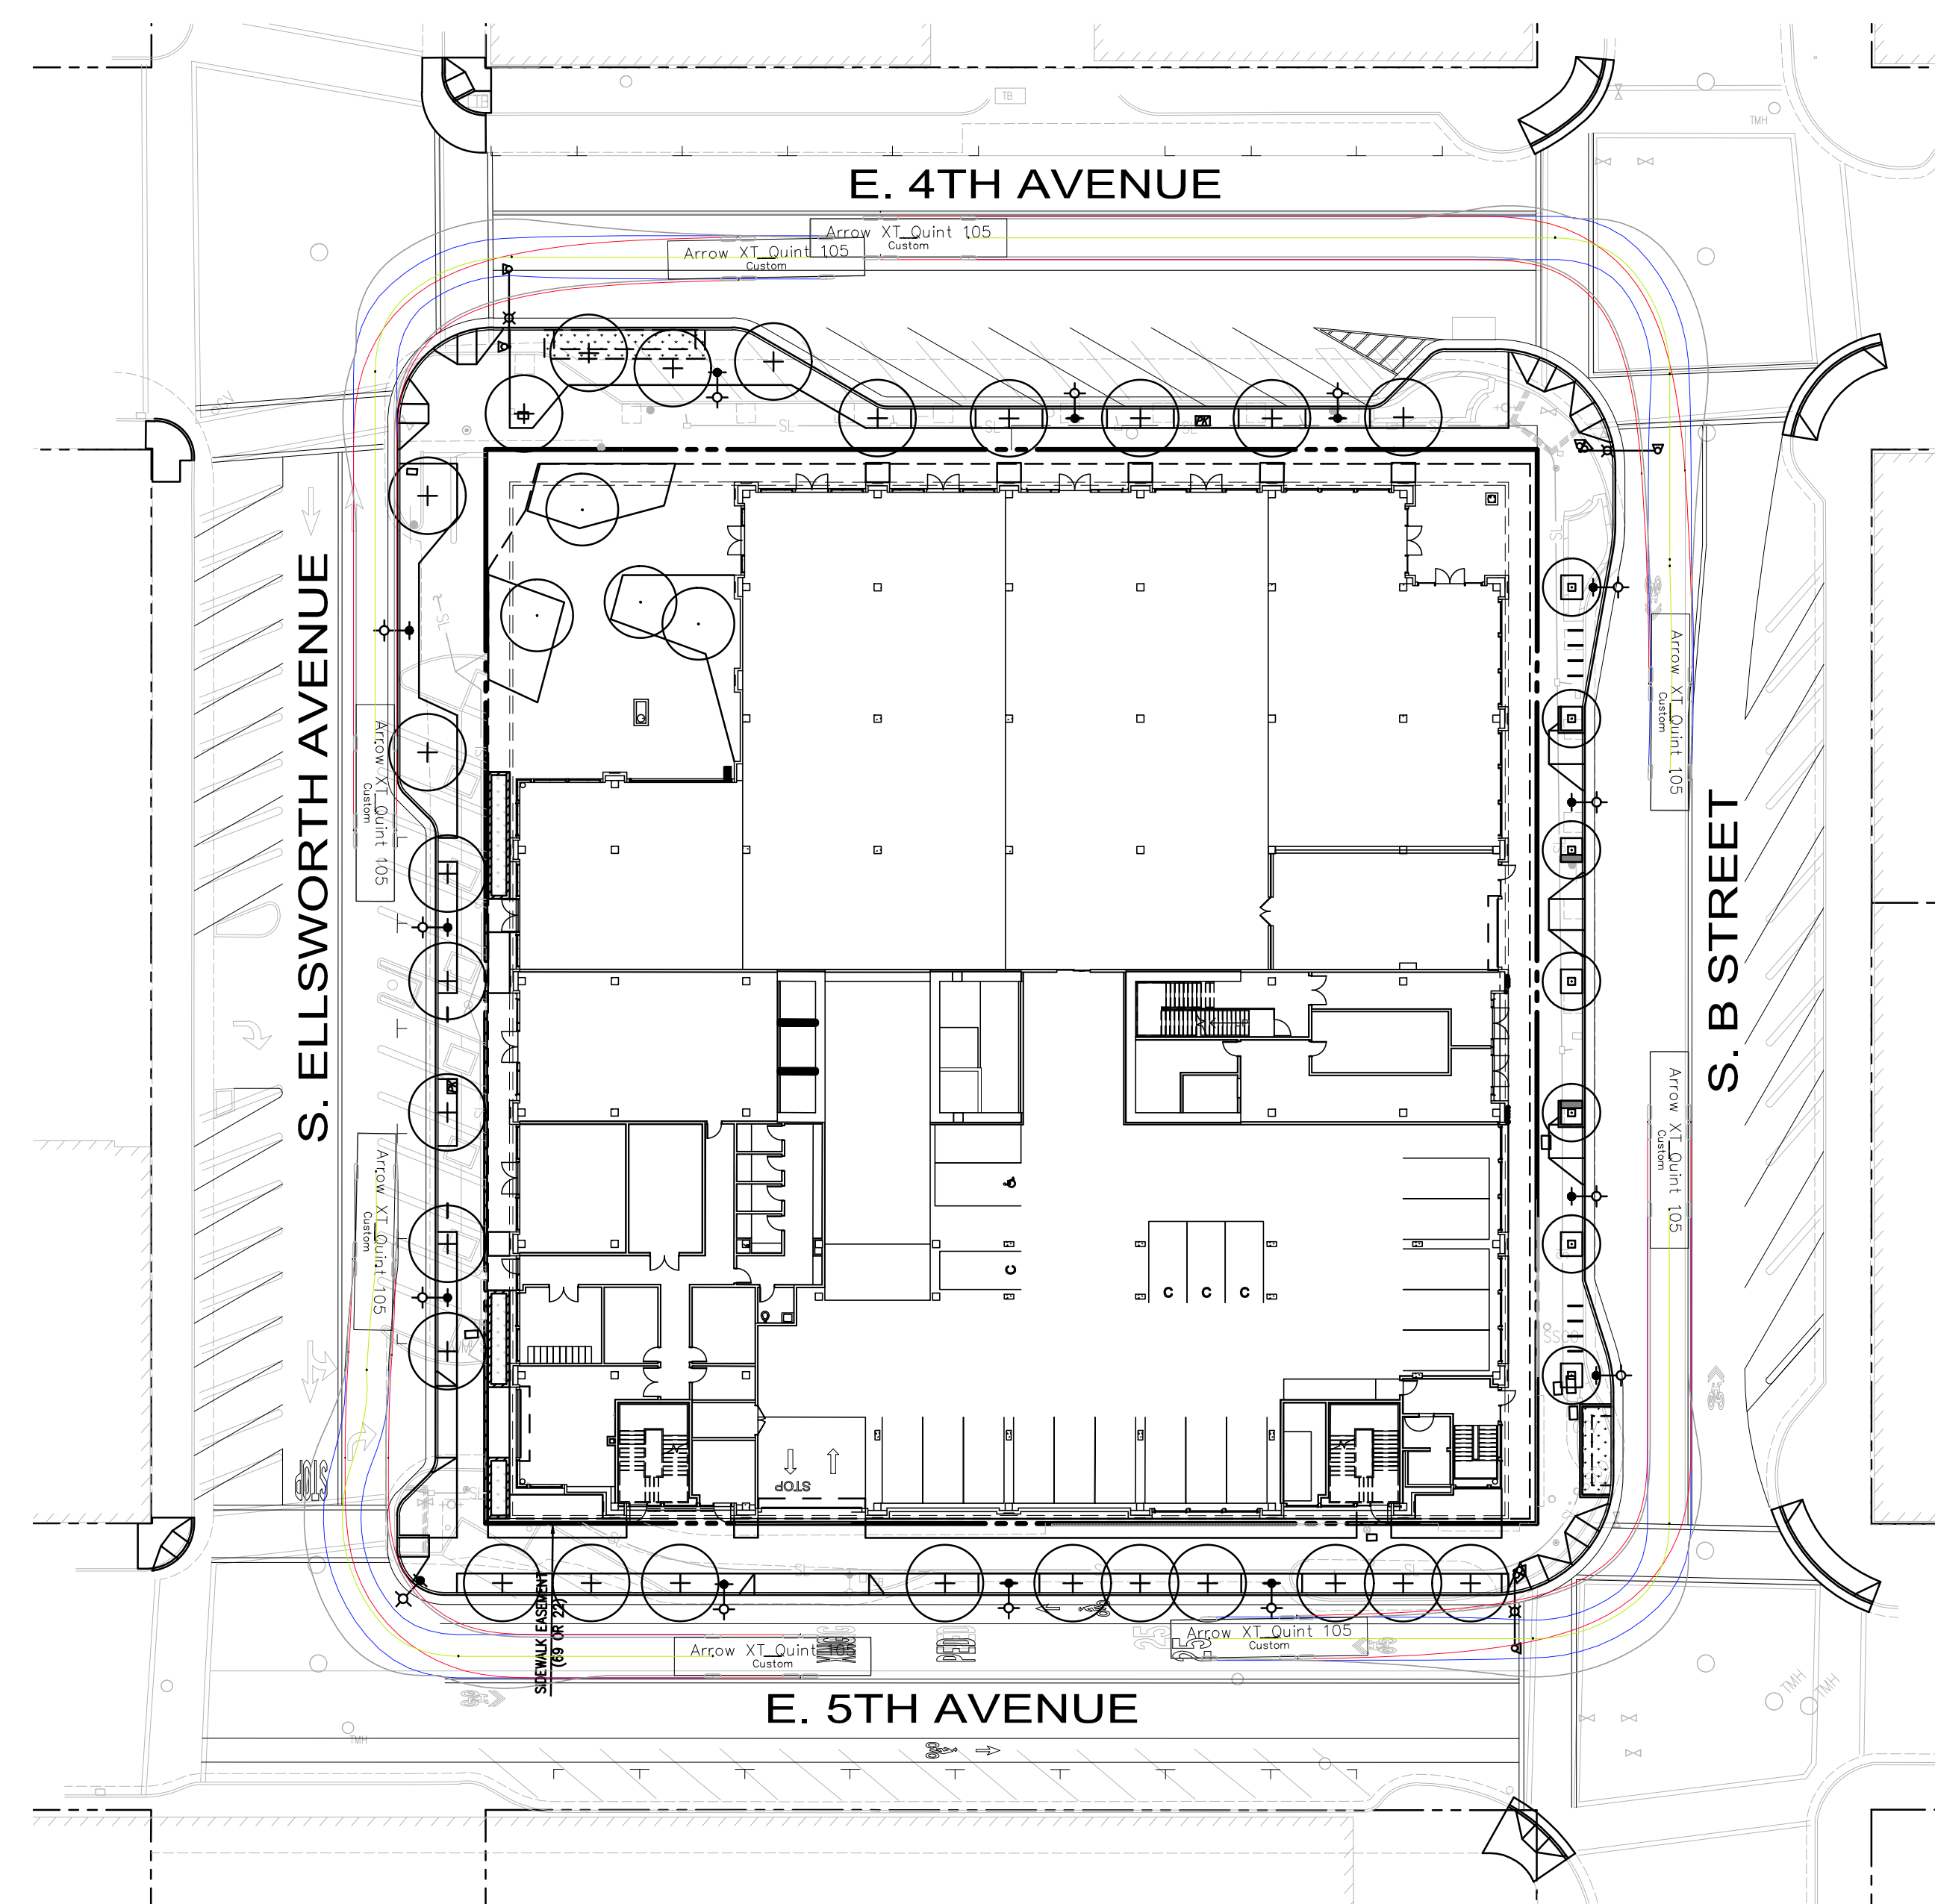

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[ft]

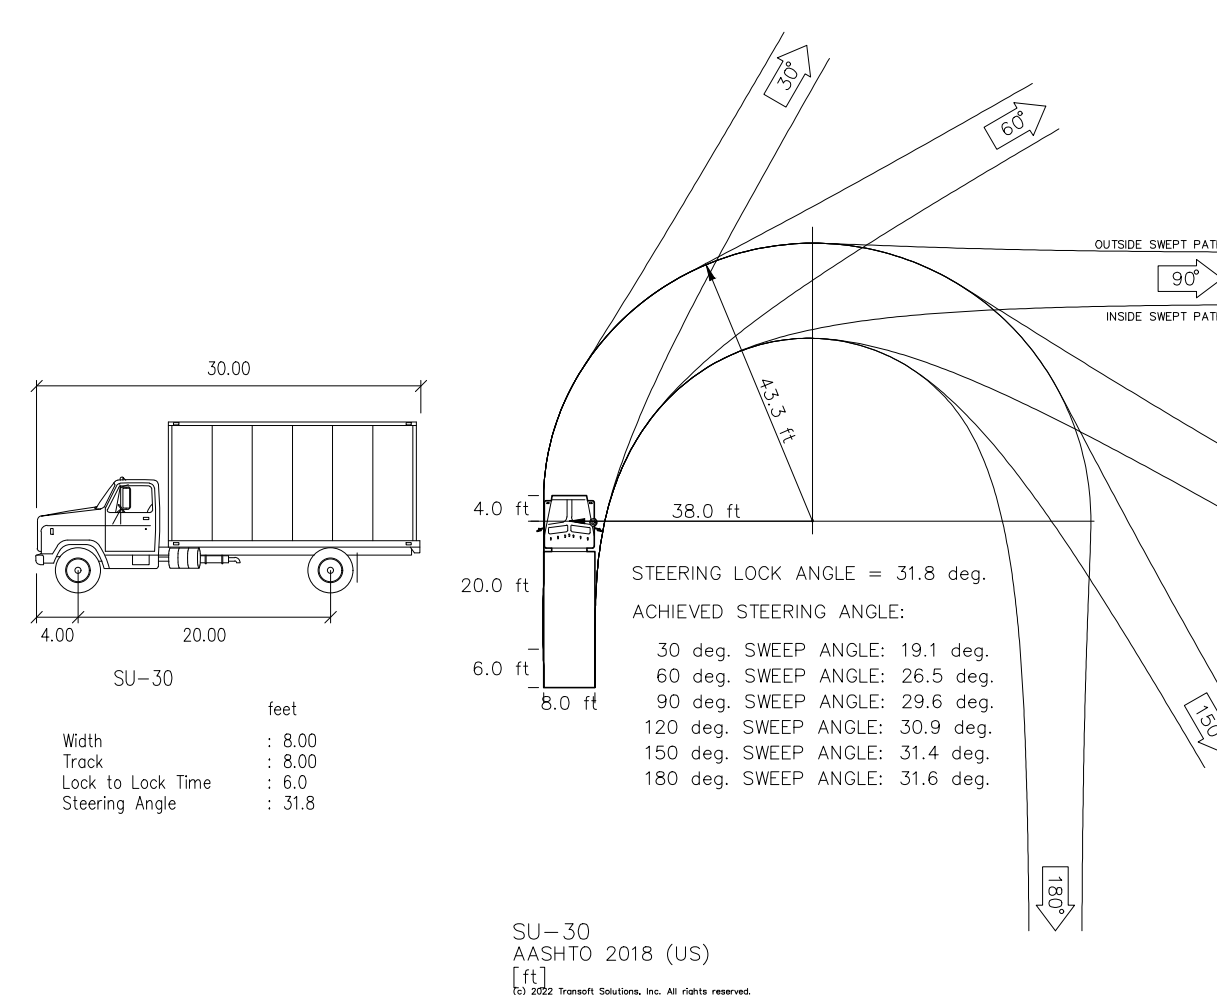


Arrow XT Quint 105
Custom
[ft]

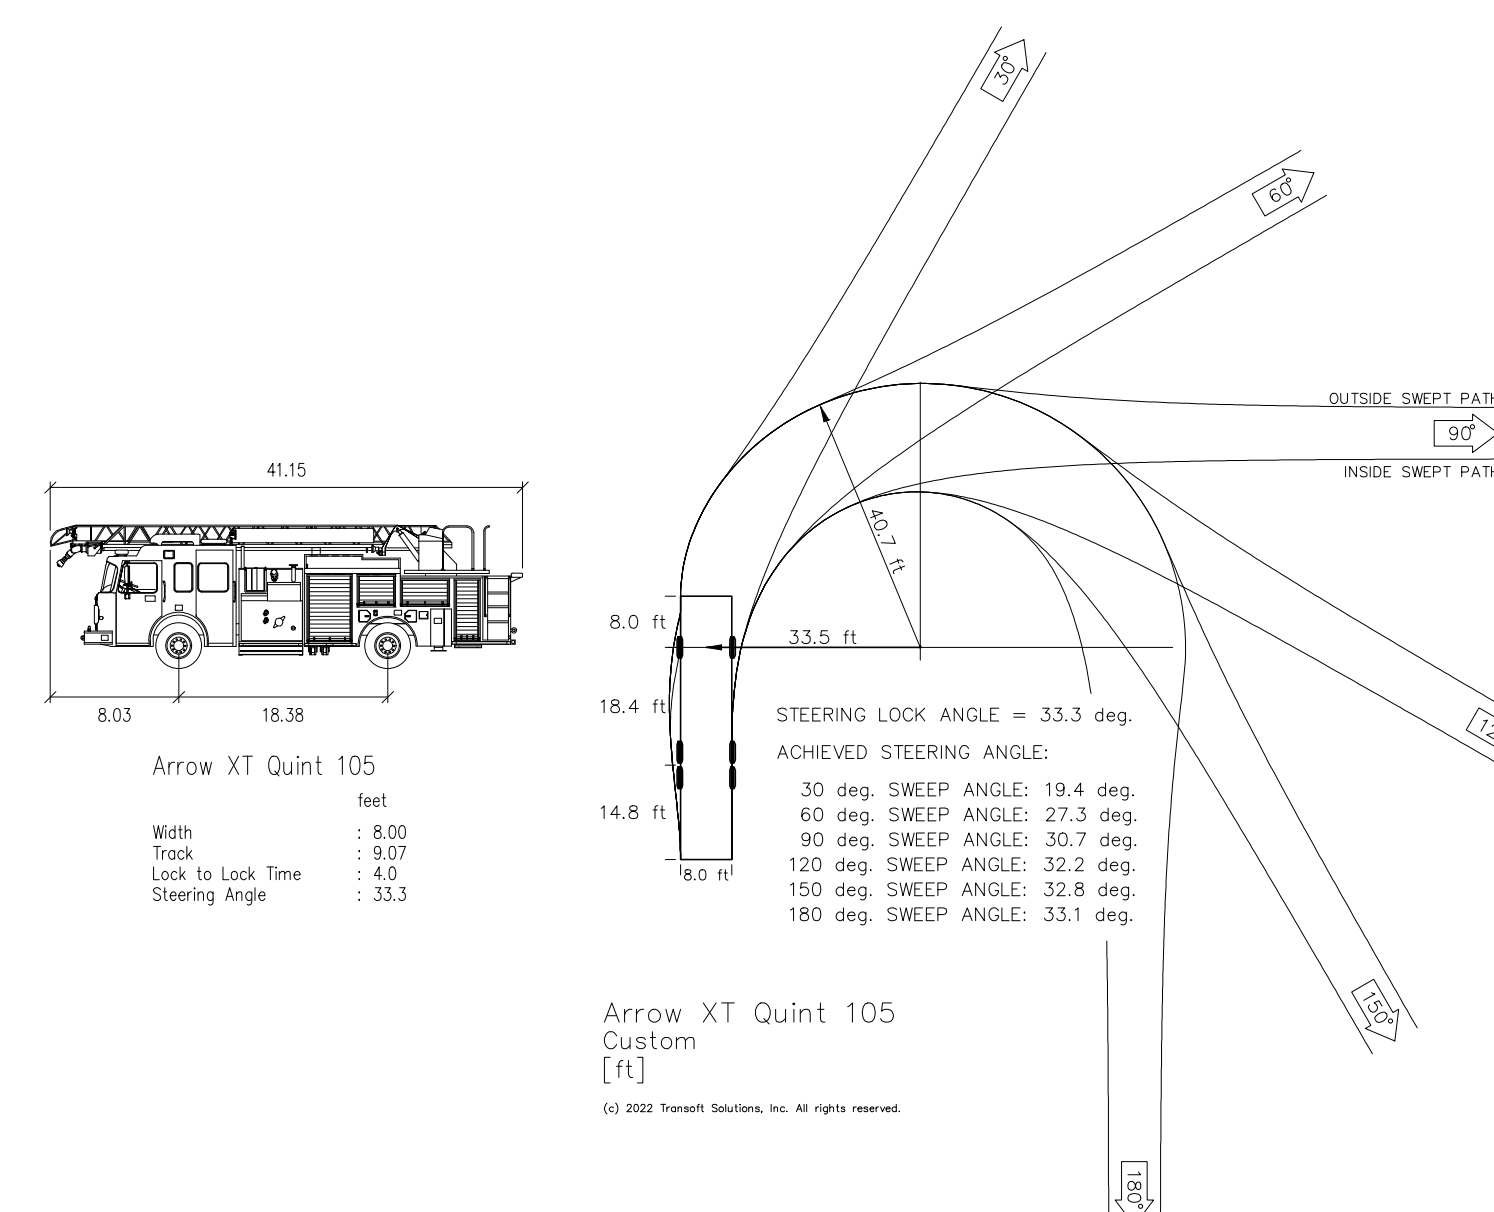

SU-30 TRUCK TURNING

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ISSUES AND REVISIONS
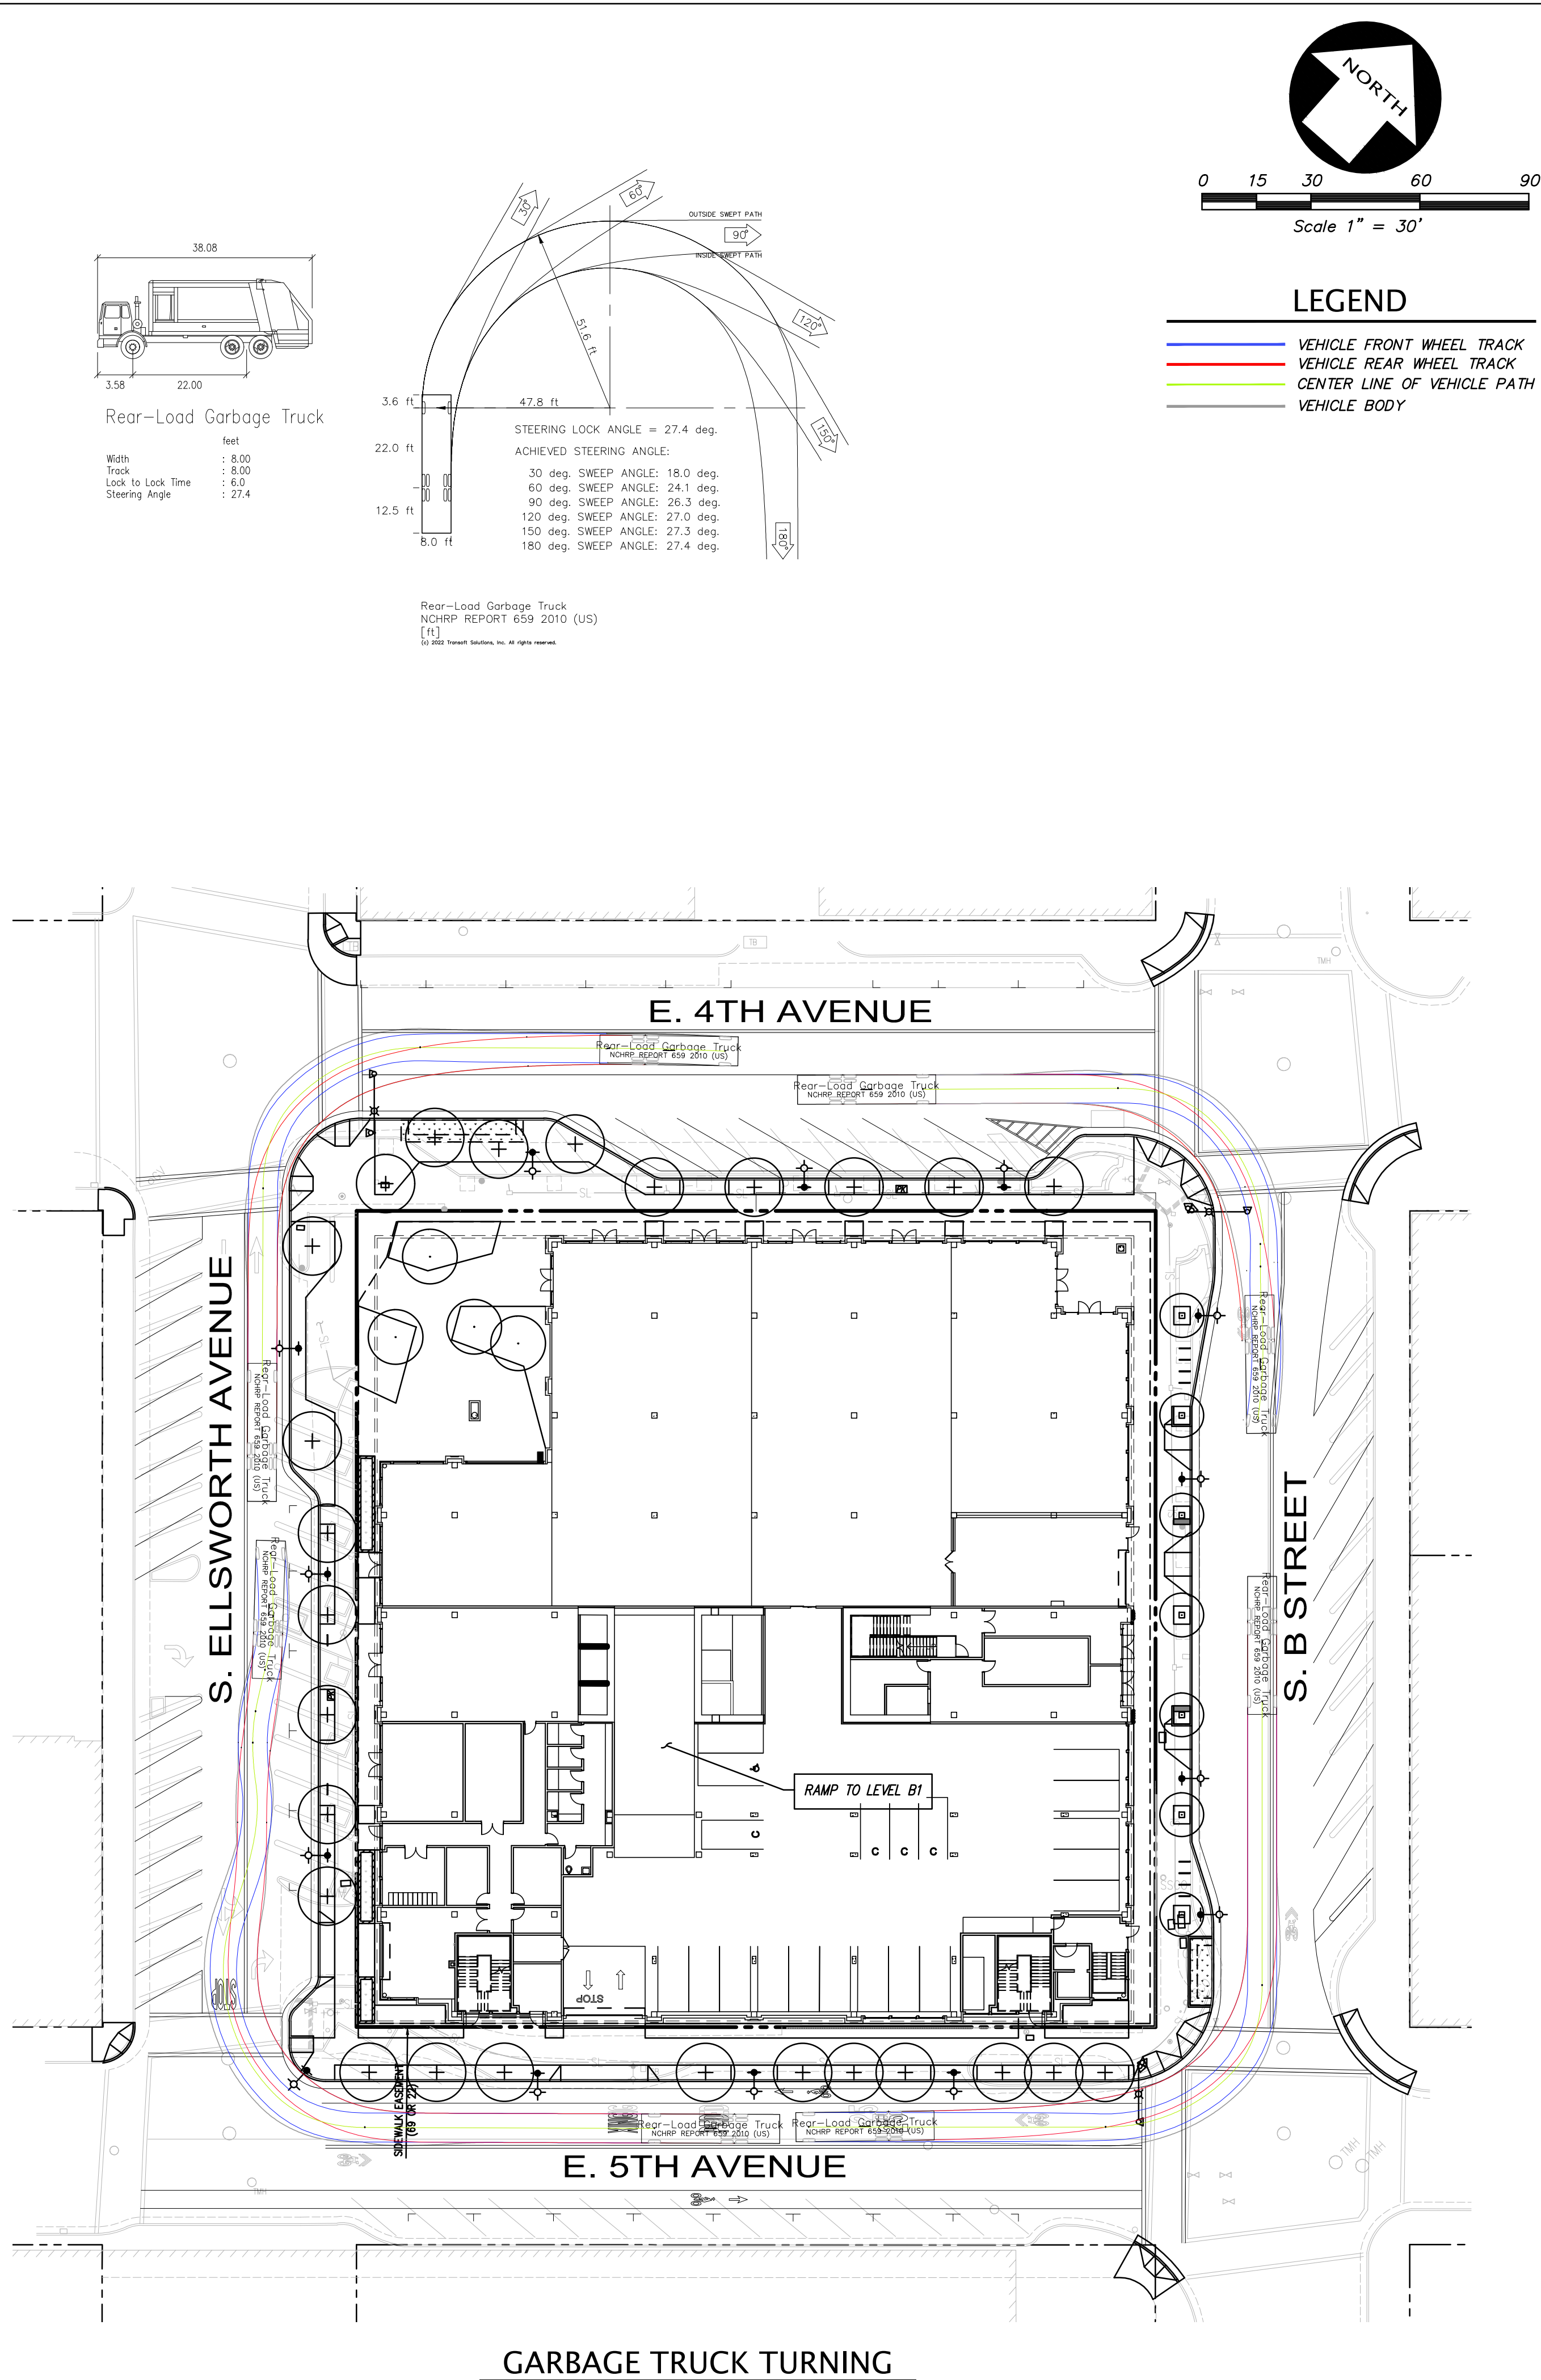
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PROJECT NUMBER
A19538-1





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VEHICLE
TURNING
ANALYSIS

SCALE
AS SHOWN

SHEET NUMBER

C6.01

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ISSUES AND REVISIONS
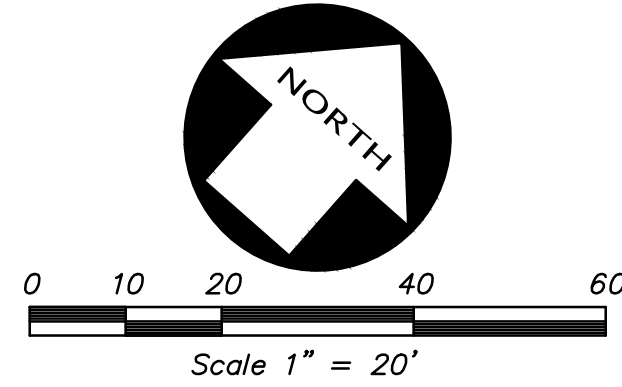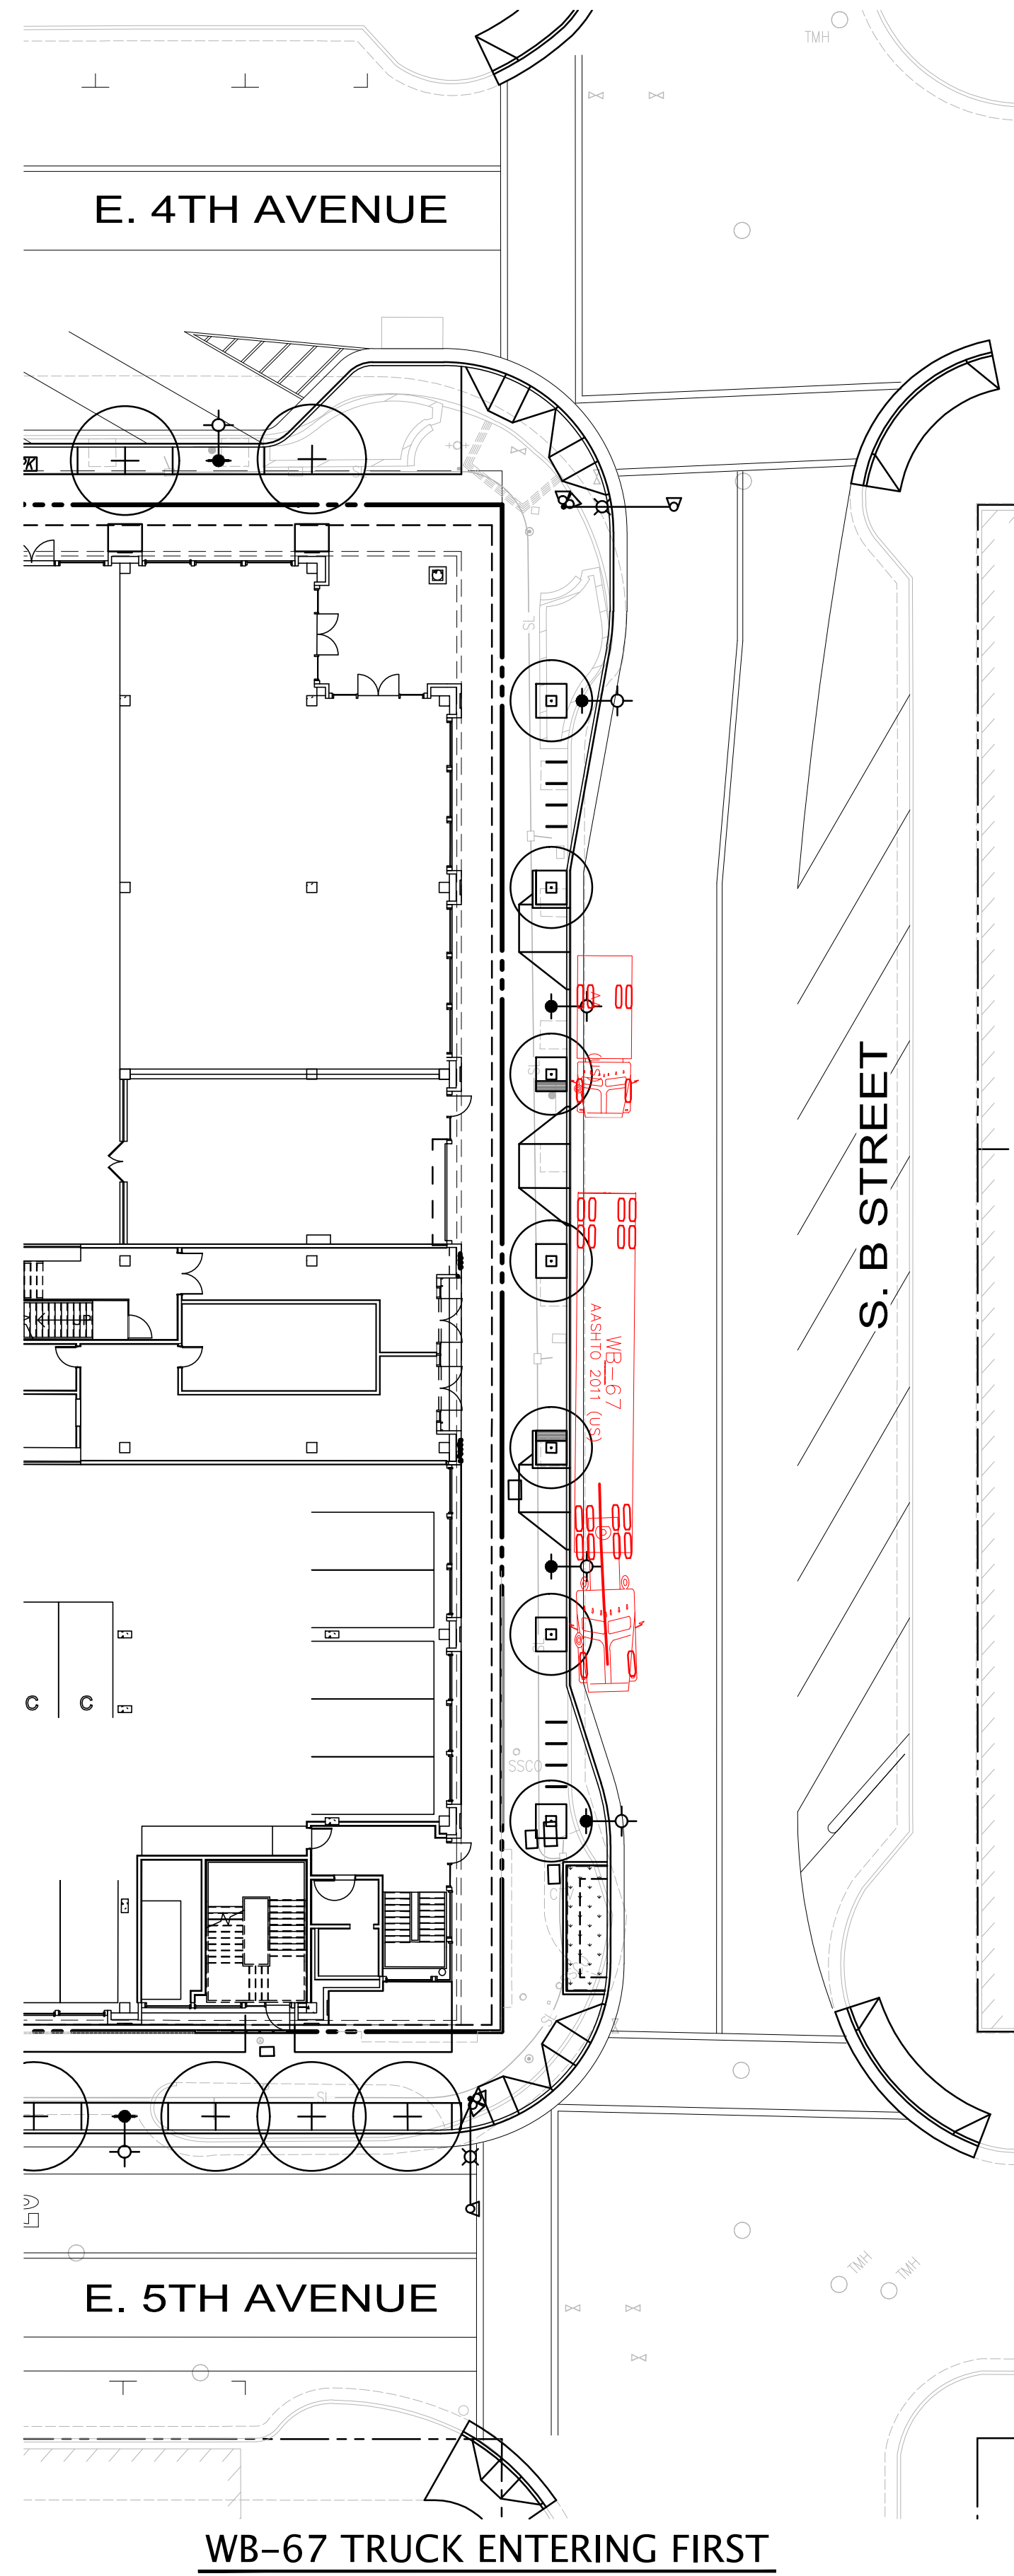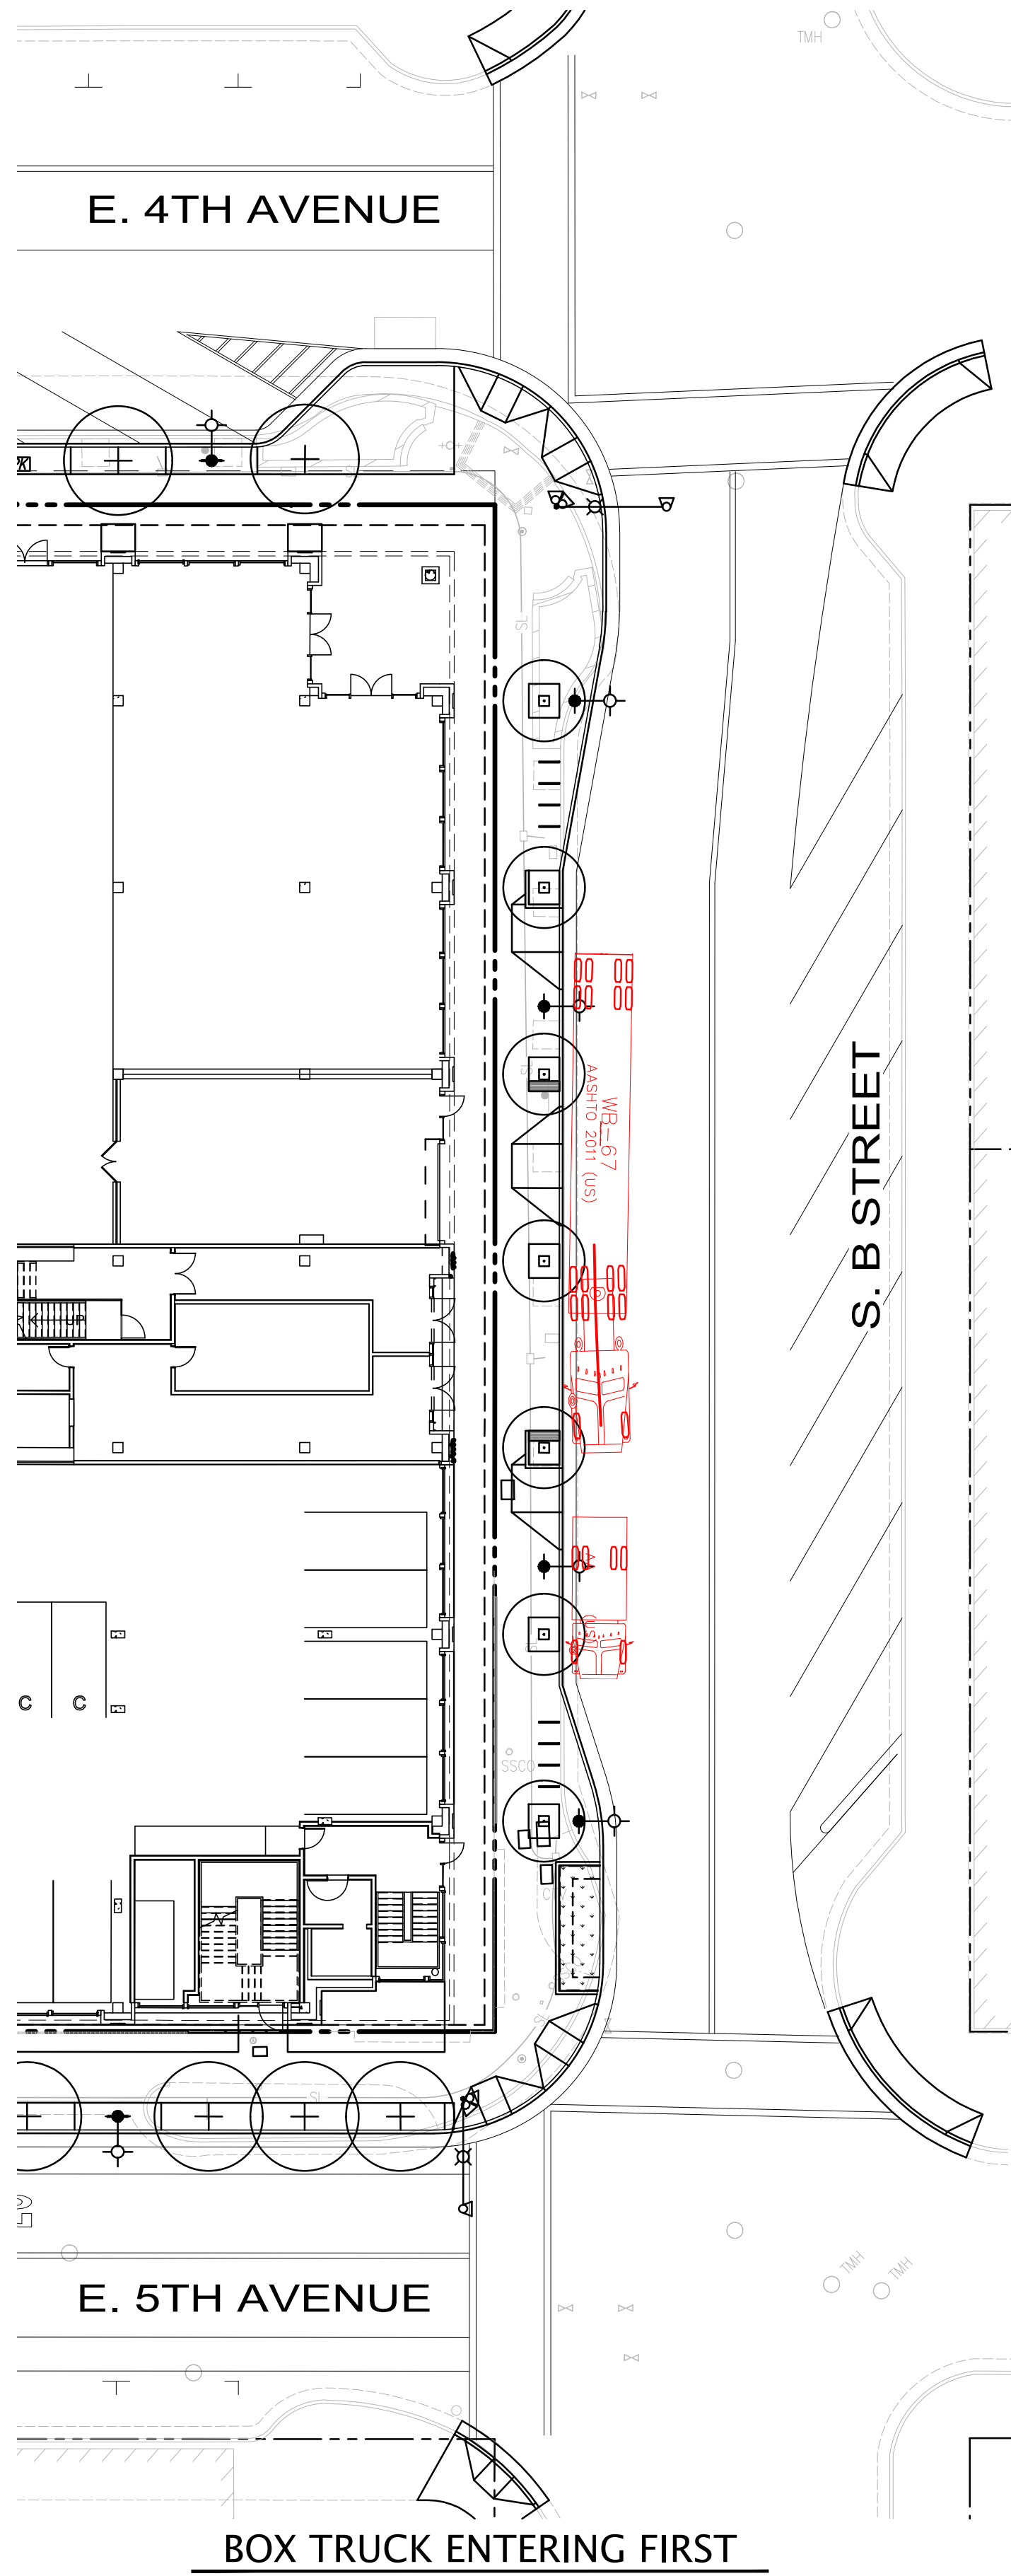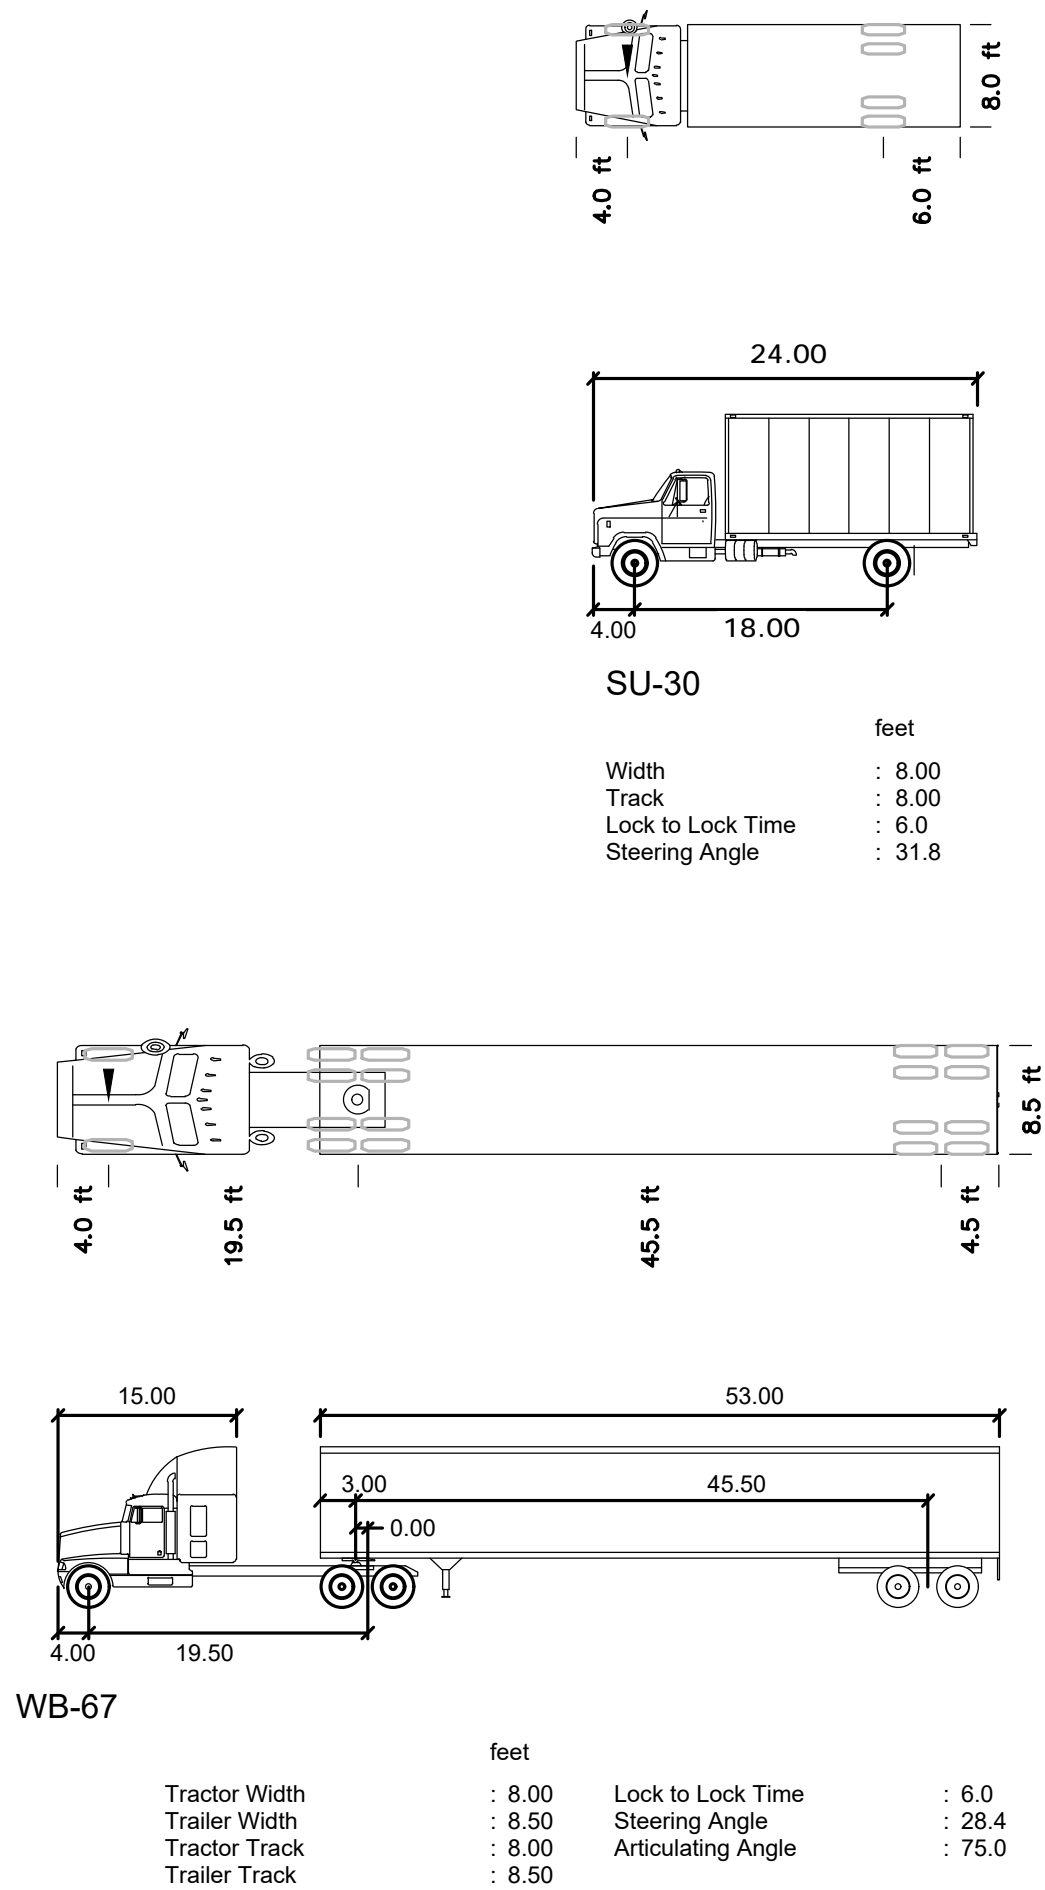
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F	04/22/2022	Pre-App Resubmittal
G	06/15/2022	Pre-App Resubmittal

PROJECT NUMBER
A19538-1

SHEET TITLE
**DELIVERY
TRUCK
ARRIVAL
ANALYSIS**
SCALE
AS SHOWN

SHEET NUMBER



ARCHITECTS
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AC
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No.	Date	Description
A	05/05/20	Pre-Application Set
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D	10/15/21	Pre-Application Resubmittal
E	02/04/22	Pre-Application Resubmittal
F	04/22/22	Pre-Application Resubmittal
G	06/15/22	Pre-Application Resubmittal

PROJECT NUMBER
16010.00

SHEET TITLE
TREE PROTECTION PLAN


SCALE
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SHEET NUMBER

L-002

LEGEND OF SYMBOLS

- EXISTING TREE TO BE PROTECTED
- EXISTING TREE TO BE RELOCATED
- EXISTING TREE TO BE REMOVED

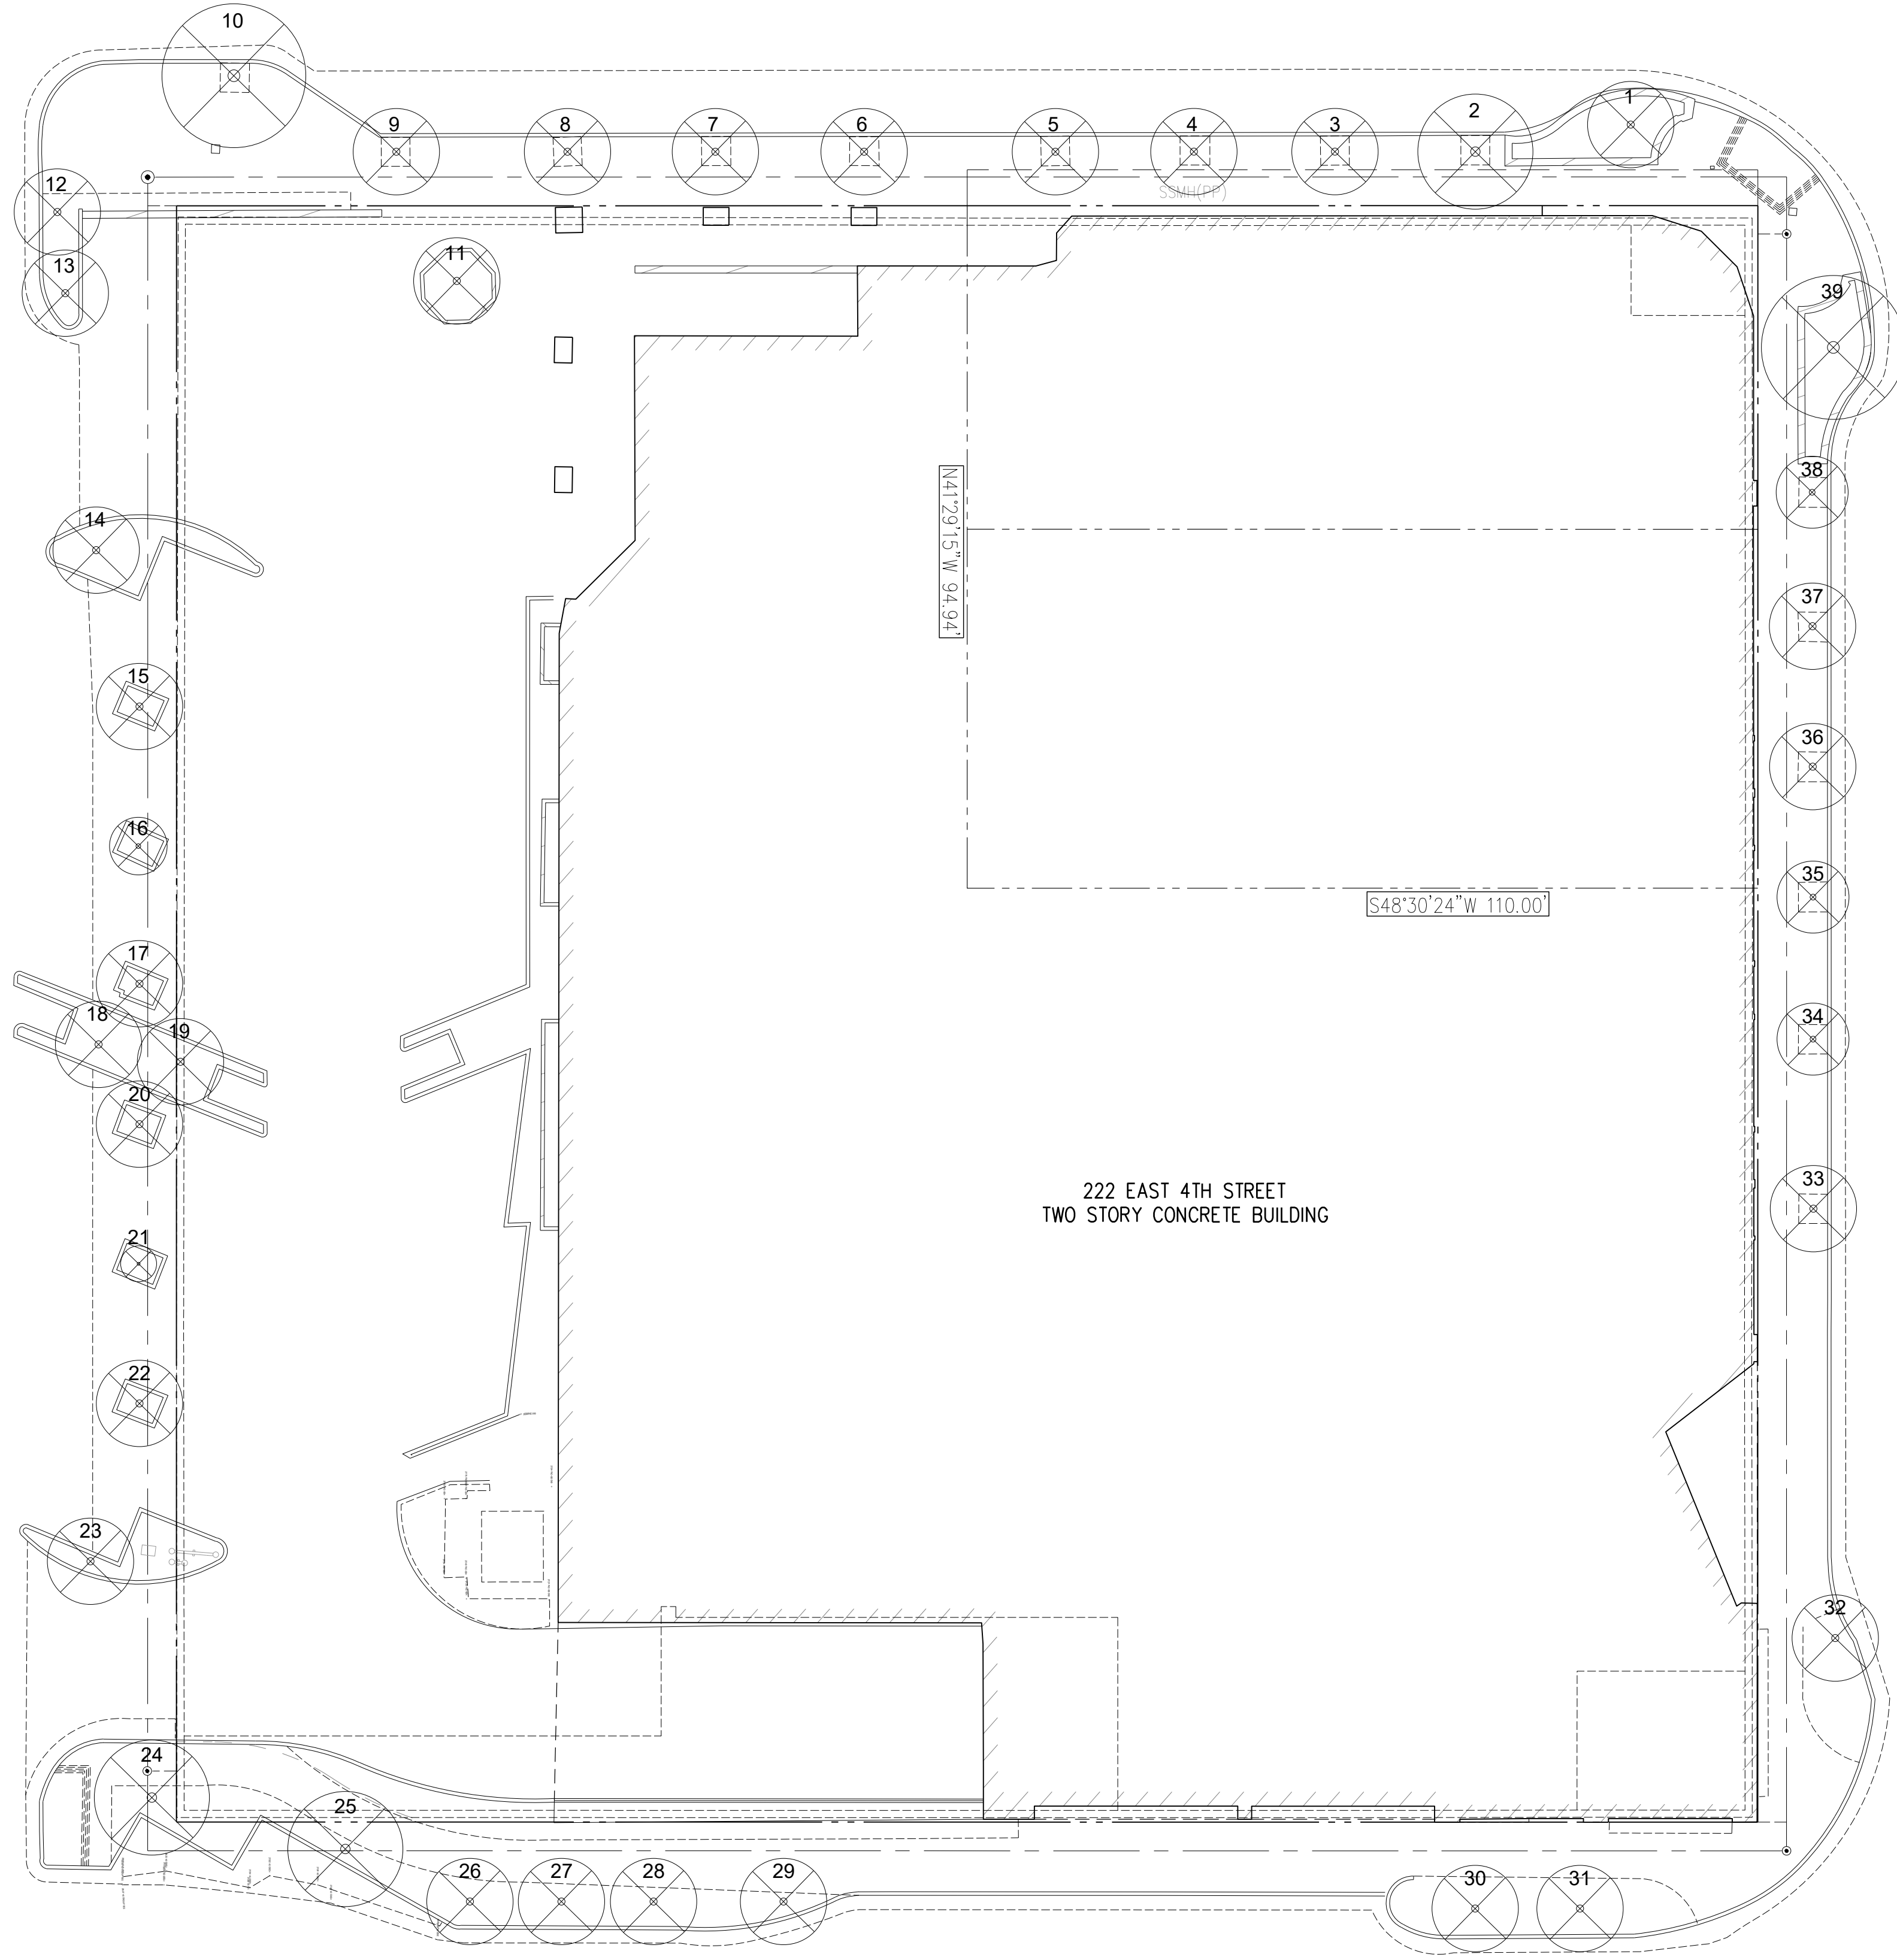

Tree Inventory, Assessment
and
Protection Report

222 E. 4th Street
San Mateo, CA

July 17, 2020
Revised October 20, 2021

Prepared for:

Lane Partners, LLC

Prepared By:

Richard Gessner
ASCA - Registered Consulting Arborist ® #496
ISA - Board Certified Master Arborist® WE-4341B



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222 E. 4th Street
San Mateo

Tree Inventory, Assessment, and Protection
Report

July 17, 2020
Revised October 20, 2021

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222 E. 4th Street
San Mateo

Tree Inventory, Assessment, and Protection
Report

July 17, 2020
Revised October 20, 2021

Summary

There are no “Heritage Trees” as defined by the ordinance and all the trees are “Street Trees” except one (#11). The inventory contains thirty-nine (39) trees comprised of four different species. There are five tulip poplar (*Liriodendron tulipifera*), eleven olives (*Olea eurpaea*), seventeen hackberry (*Celtis occidentalis*), and six Brisbane box (*Lophostemon confertus*). Most of the tree are in fair condition with thirteen good, one poor, two very poor, and the remaining twenty-three in fair shape and most have fair suitability for preservation except for the tulip poplars. All the trees will be highly impacted and are proposed to be removed. No tree protection is warranted. The average L/U Value was calculated to be 4.079.

Introduction

Background

Lane Partners, LLC asked me to assess the site, trees, and proposed footprint plan, and to provide a report with my findings and recommendations to help satisfy planning requirements.

Assignment

- Provide an arborist’s report that includes an assessment of the trees within the project area and on the adjacent sites. The assessment is to include the species, size (trunk diameter), condition (health, structure, and form), and suitability for preservation ratings.
- Provide tree protection specifications, guidelines, and expected impact ratings for trees that may be affected by the project.
- Provide LU values according to the City of San Mateo ordinance 27.71.150.



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222 E. 4th Street
San Mateo

Tree Inventory, Assessment, and Protection
Report

July 17, 2020
Revised October 20, 2021

Limits of the assignment

- The information in this report is limited to the condition of the trees and site during my inspection on July 15, 2020. No tree risk assessments were performed.
- Only the landscape plans were provided for this assignment.

Table 1: Plans Reviewed Checklist

Plan	Date	Sheet	Reviewed	Source	Notes
Existing Site Topographic Map or A.L.T.A with tree locations	June 2019		1 Yes	Kier + Wright	
Proposed Sit Plan			No		
Demolition Plan			No		
Construction Staging			No		
Grading and Drainage			No		
Utility Plan and Hook-up locations			No		
Exterior Elevations			No		
Landscape Plan	March 19, 2021	L-100, L-101, L-102	Yes	Andrea Cochrane Landscape Architect	
Irrigation Plan			No		
T-1 Tree Protection Plan			No		

Purpose and use of the report

The report is intended to identify all the trees within the plan area that could be affected by a project. The report is to be used by the property owners, owner’s agents, and the City of San Mateo as a reference for existing tree and site conditions to help satisfy planning requirements.



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222 E. 4th Street
San Mateo

Tree Inventory, Assessment, and Protection
Report

July 17, 2020
Revised October 20, 2021

Observations

Tree Inventory

The inventory contains all the trees six inches in diameter and greater measured at forty-eight inches above grade. The City of San Mateo ordinance 13.52.020 defines “Heritage Trees” as the following:

13.52.020 Definition

- A. Heritage tree is any of the following:
1. Any bay (*Umbellularia californica*), buckeye (*Aesculus spp.*), oak (*Quercus spp.*), cedar (*Cedrus spp.*) or redwood (*Sequoia sp.*) tree that has a diameter of ten (10) inches or more measured at forty-eight (48) inches above natural grade.
 2. Any tree or stand of trees designated by resolution of the City Council to be of special historical value or of significant community benefit.
 3. A stand of trees, the nature of which makes each dependent on the others for survival.
 4. Any other tree with a trunk diameter of sixteen (16) inches or more, measured at forty-eight (48) inches above natural grade.

There are no “Heritage Trees” as defined by the ordinance and all the trees are “Street Trees” except one in a container (#11). The trees are all located around the perimeter of the property on 4th, 5th, N. Ellsworth, and B streets.

The inventory contains thirty-nine (39) trees comprised of four different species. There are five tulip poplar (*Liriodendron tulipifera*), eleven olives (*Olea eurpaea*), seventeen hackberry (*Celtis occidentalis*), and six Brisbane box (*Lophostemon confertus*) (Appendix B).

The trees are arbitrarily numbered (no affixed number tags were used for this assignment) around the site counter clockwise starting at the corner of E. 4th Street and B Street (Appendix A).



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222 E. 4th Street
San Mateo

Tree Inventory, Assessment, and Protection
Report

July 17, 2020
Revised October 20, 2021

Analysis

27.71.150 PRESERVATION OF EXISTING TREES.

Landscape Unit Value (LU)

1. The tree species, condition, and location values of the trees shall be based on an evaluation by an experienced landscape appraiser recognized by the American Society of Consulting Arborists utilizing the most recent Guide for Plant Appraisal, published by the Council of Tree and Landscape Appraisers; and approved by the Zoning Administrator.
2. Trees not within the allowable building area shall receive a location factor of 1.0 (100%). Trees located within the allowable building area shall receive a location factor of .70 (70%).
3. Trees designated as heritage trees shall receive a bonus percentage value of 1.25 (125%). Trees located within the allowable building area shall receive a location factor of .70 (70%).
4. Trees designated as heritage trees shall receive a bonus percentage value of 1.25 (125%).

All existing trees to be removed shall be given a LU value based upon the following calculation:

(species value% X condition value% X location value%) /.35 X (caliper inches x bldg./ setback% x heritage tree%) = LU

Tree condition ratings and percentages are defined in the “Condition Rating” section of this report. The location rating were established at 63 percent (the average of site (90%), placement (50%), and contribution (50%%).

The average L/U Value is 4.079 (Appendix B).



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ISSUES AND REVISIONS

No.	Date	Description
A	05/05/20	Pre-Application Set
B	10/21/20	Pre-Application Resubmittal
C	03/19/21	Pre-Application Resubmittal
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E	02/04/22	Pre-Application Resubmittal
F	04/22/22	Pre-Application Resubmittal
G	06/15/22	Pre-Application Resubmittal

PROJECT NUMBER
16010.00

SHEET TITLE
TREE INVENTORY

SCALE
NA

SHEET NUMBER

L-003


Discussion

Condition Rating

A tree's condition is a determination of its overall health, structure, and form (ISA 2018). The assessment considered all three characteristics for a combined condition rating.

- 100% - Exceptional = Good health and structure with significant size, location or quality.
- 61-80% - Good = Normal vigor, well-developed structure, function and aesthetics not compromised with good longevity for the site.
- 41-60% - Fair = Reduced vigor, damage, dieback, or pest problems, at least one significant structural problem or multiple moderate defects requiring treatment. Major asymmetry or deviation from the species normal habit, function and aesthetics compromised.
- 21-40% - Poor = Unhealthy and declining appearance with poor vigor, abnormal foliar color, size or density with potential irreversible decline. One serious structural defect or multiple significant defects that cannot be corrected and failure may occur at any time. Significant asymmetry and compromised aesthetics and intended use.
- 6-20% - Very Poor = Poor vigor and dying with little foliage in irreversible decline. Severe defects with the likelihood of failure being probable or imminent. Aesthetically poor with little or no function in the landscape.
- 0-5% - Dead/Unstable = Dead or imminently ready to fail.

Most of the tree are in fair condition with thirteen good, one poor, two very poor, and the remaining twenty-three in fair shape.

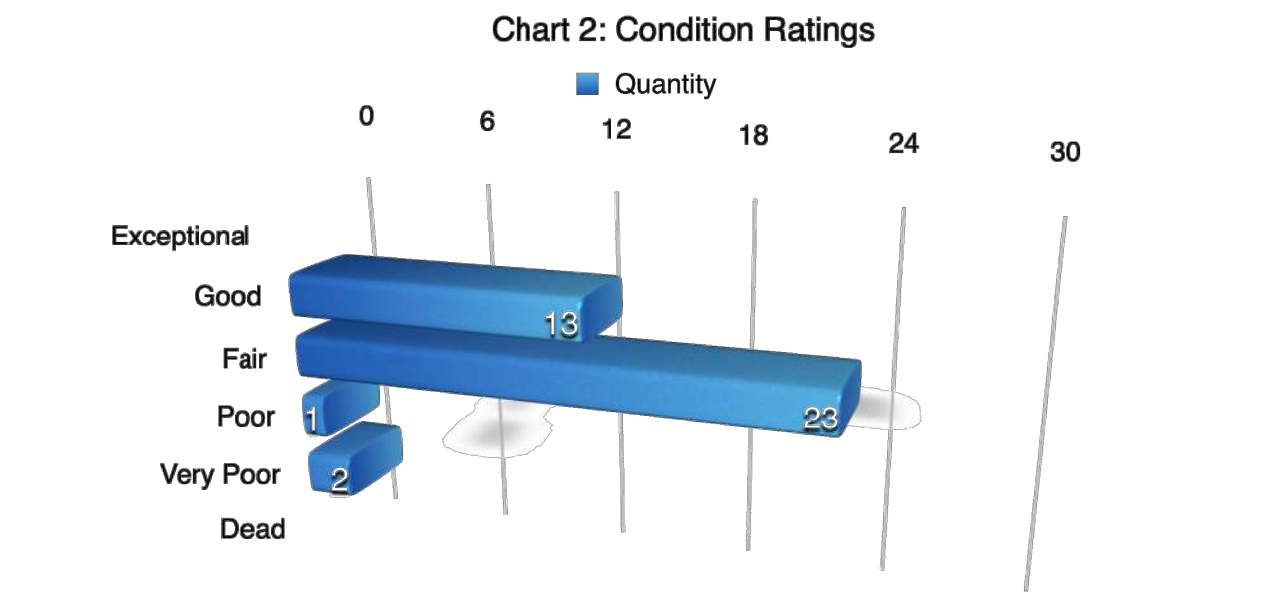

Glossary of Terms

Defect: An imperfection, weakness, or lack of something necessary. In trees defects are injuries, growth patterns, decay, or other conditions that reduce the tree's structural strength.

Diameter at breast height (DBH): Measures at 1.4 meters (4.5 feet) above ground in the United States, Australia (arboriculture), New Zealand, and when using the Guide for Plant Appraisal, 9th edition; at 1.3 meters (4.3 feet) above ground in Australia (forestry), Canada, the European Union, and in UK forestry; and at 1.5 meters (5 feet) above ground in UK arboriculture.

Drip Line: Imaginary line defined by the branch spread or a single plant or group of plants. The outer extent of the tree crown.

Mechanical damage: Physical damage caused by outside forces such as cutting, chopping or any mechanized device that may strike the tree trunk, roots or branches.

Scaffold branches: Permanent or structural branches that for the scaffold architecture or structure of a tree.

Straw wattle: also known as straw worms, bio-logs, straw noodles, or straw tubes are man made cylinders of compressed, weed free straw (wheat or rice), 8 to 12 inches in diameter and 20 to 25 feet long. They are encased in jute, nylon, or other photo degradable materials, and have an average weight of 35 pounds.

Tree Protection Zone (TPZ): Defined area within which certain activities are prohibited or restricted to prevent or minimize potential injury to designated trees, especially during construction or development.

Tree Risk Assessment: Process of evaluating what unexpected things could happen, how likely it is, and what the likely outcomes are. In tree management, the systematic process to determine the level of risk posed by a tree, tree part, or group of trees.

Trunk: Stem of a tree.

Volunteer: A tree, not planted by human hands, that begins to grow on residential or commercial property. Unlike trees that are brought in and installed on property, volunteer trees usually spring up on their own from seeds placed onto the ground by natural causes or accidental transport by people. Normally, volunteer trees are considered weeds and removed, but many desirable and attractive specimens have gone on to become permanent residents on many public and private grounds.

Suitability for Preservation

A tree's suitability for preservation is determined based on its condition (health, structure, form), age, species, tolerance to disturbance, external and functional limitations, and potential longevity for the site using a scale of good, fair, or poor. The following list defines the rating scale (Fite, K, and Smiley, E. T., 2016):

- Good = Trees with good health, structural stability and longevity after construction.
- Fair = Trees with fair health and/or structural defects that may be mitigated through treatment. These trees require more intense management and monitoring, before, during, and after construction, and may have shorter life expectancy after development.
- Poor = Trees are expected to decline during or after construction regardless of management. The species or individual may possess characteristics that are incompatible or undesirable in landscape settings or unsuited for the intended use of the site.

Most of the trees have fair suitability for preservation except for the tulip poplars. All the tulip poplars are poorly suited for retention due to pest problems and their condition. At least three olives are in raided planters with two at the corner of 4th and B and one just inside the property near the corner of 4th and N. Ellsworth. These trees have good suitability for retention or could successfully be relocated.


Expected Impact Level

Impact level defines how a tree may be affected by construction activity and proximity to the tree, and is described as low, moderate, or high. The following scale defines the impact rating:

- Low = The construction activity will have little influence on the tree.
- Moderate = The construction may cause future health or structural problems, and steps must be taken to protect the tree to reduce future problems.
- High = Tree structure and health will be compromised and removal is recommended, or other actions must be taken for the tree to remain. The tree is located in the building envelope.

All the trees will be highly impacted and are proposed for removal.

Appendix A: Tree Inventory Locations

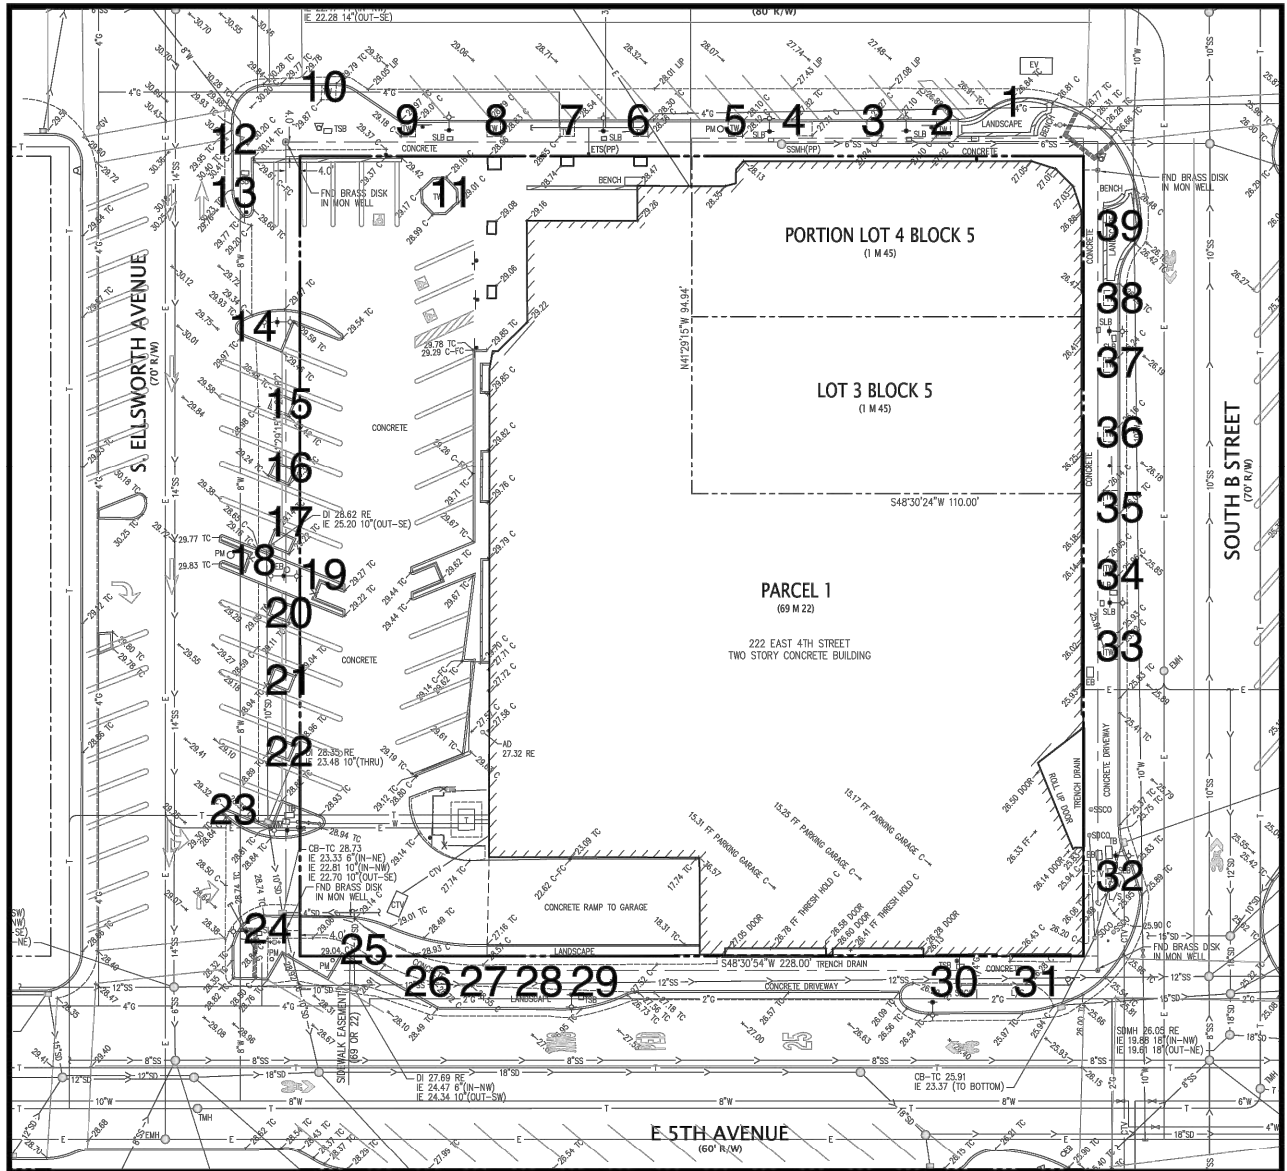

Conclusion

There are no "Heritage Trees" as defined by the ordinance and all the trees are "Street Trees" except one olive. The trees are all located around the perimeter of the property on 4th, 5th, N. Ellsworth, and B streets. The inventory contains thirty-nine (39) trees comprised of four different species. There are five tulip poplar (*Liriodendron tulipifera*), eleven olives (*Olea eurpaea*), seventeen hackberry (*Celtis occidentalis*), and six Brisbane box (*Lophostemon confertus*). Most of the tree are in fair condition with thirteen good, one poor, two very poor, and the remaining twenty-three in fair shape and most have fair suitability for preservation except for the tulip poplars. All the trees are expected to be highly impacted and removed. The average L/U Value was calculated to be 4.079.

Recommendations

- Obtain all necessary permits prior to removing or significantly altering any trees on the property
- All tree maintenance, care, and removals shall be performed by a qualified arborist with a C-61/D-49 California Contractors License. Tree maintenance and care shall be specified in writing according to American National Standard for Tree Care Operations: *Tree, Shrub and Other Woody Plant Management: Standard Practices* parts 1 through 10 and adhere to ANSI Z133.1 safety standards and local regulations. All maintenance is to be performed according to ISA Best Management Practices.

Bibliography

American National Standard for Tree Care Operations: Tree, Shrub and Other Woody Plant Management : Standard Practices (Management of Trees and Shrubs During Site Planning, Site Development, and Construction)(Part 5). Londonderry, NH: Secretariat, Tree Care Industry Association, 2019. Print.

Fite, Kelby, and Edgar Thomas. Smiley. *Managing trees during construction*, second edition. Champaign, IL: International Society of Arboriculture, 2016.

ISA. *Guide For Plant Appraisal*. Savoy, IL: International Society Of Arboriculture, 2000. Print.

ISA. Species Classification and Group Assignment, 2004 Western Chapter Regional Supplement. Western Chapter ISA

Appendix B: Tree Inventory Table

Table 2: Inventory Summary						
Tree Species	#	Trunk Diameter (in.)	Condition	Expected Impact	Disposition	L/U Value
olive (<i>Olea eurpaea</i>)	1	4, 2, 2	Good	High	Container	2.4696
hackberry (<i>Celtis occidentalis</i>)	2	7	Fair	High	Street Tree	4.3218
hackberry (<i>Celtis occidentalis</i>)	3	9	Fair	High	Street Tree	5.5566
hackberry (<i>Celtis occidentalis</i>)	4	7	Fair	High	Street Tree	4.3218
hackberry (<i>Celtis occidentalis</i>)	5	6	Fair	High	Street Tree	3.7044
hackberry (<i>Celtis occidentalis</i>)	6	7	Fair	High	Street Tree	4.3218
hackberry (<i>Celtis occidentalis</i>)	7	5	Fair	High	Street Tree	3.087
hackberry (<i>Celtis occidentalis</i>)	8	8	Fair	High	Street Tree	4.9392
hackberry (<i>Celtis occidentalis</i>)	9	9	Fair	High	Street Tree	5.5566
hackberry (<i>Celtis occidentalis</i>)	10	11	Good	High	Street Tree	6.7914
olive (<i>Olea eurpaea</i>)	11	5, 4, 2, 2, 2, 2	Good	High	Container	3.087
olive (<i>Olea eurpaea</i>)	12	8, 7, 5, 4	Good	High	Street Tree	4.9392
olive (<i>Olea eurpaea</i>)	13	5, 5, 4, 4	Good	High	Street Tree	3.087
olive (<i>Olea eurpaea</i>)	14	5, 4, 3	Fair	High	Street Tree	3.087
tulip poplar (<i>Liriodendron tulipifera</i>)	15	7	Good	High	Street Tree	1.8522
hackberry (<i>Celtis occidentalis</i>)	16	1	Very Poor	High	Street Tree	0.6174



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4 H I R D 3 T R E E T U
3 A N & R A N C I S C O # 1 !

ISSUES AND REVISIONS

No.	Date	Description
A	05/05/20	Pre-Application Set
B	10/21/20	Pre-Application Resubmittal
C	03/19/21	Pre-Application Resubmittal
D	10/15/21	Pre-Application Resubmittal
E	02/04/22	Pre-Application Resubmittal
F	04/22/22	Pre-Application Resubmittal
G	06/15/22	Pre-Application Resubmittal

PROJECT NUMBER
16010.00

SHEET TITLE
TREE INVENTORY

SCALE
NA

SHEET NUMBER

L-004

222 E. 4th Street San Mateo		Tree Inventory, Assessment, and Protection Report			July 17, 2020 Revised October 20, 2021	
Tree Species	#	Trunk Diameter (in.)	Condition	Expected Impact	Disposition	L/U Value
tulip poplar (<i>Liriodendron tulipifera</i>)	17	7	Very Poor	High	Street Tree	1.8522
olive (<i>Olea eurpaea</i>)	18	3, 2, 2, 2, 2, 2	Fair	High	Street Tree	1.8522
olive (<i>Olea eurpaea</i>)	19	5, 2, 2, 2, 1	Fair	High	Street Tree	3.087
tulip poplar (<i>Liriodendron tulipifera</i>)	20	5, 4	Fair	High	Street Tree	1.323
tulip poplar (<i>Liriodendron tulipifera</i>)	21	1	Poor	High	Street Tree	0.1134
tulip poplar (<i>Liriodendron tulipifera</i>)	22	7	Good	High	Street Tree	1.8522
olive (<i>Olea eurpaea</i>)	23	7, 6, 5, 4	Good	High	Street Tree	4.3218
olive (<i>Olea eurpaea</i>)	24	8, 7, 5, 3, 3	Good	High	Street Tree	4.9392
Brisbane box (<i>Lophostemon confertus</i>)	25	12	Fair	High	Street Tree	6.804
Brisbane box (<i>Lophostemon confertus</i>)	26	12	Good	High	Street Tree	9.5256
olive (<i>Olea eurpaea</i>)	27	5, 3, 3, 3, 3, 3	Good	High	Street Tree	3.087
Brisbane box (<i>Lophostemon confertus</i>)	28	13	Good	High	Street Tree	10.3194
Brisbane box (<i>Lophostemon confertus</i>)	29	14	Fair	High	Street Tree	7.938
Brisbane box (<i>Lophostemon confertus</i>)	30	14	Fair	High	Street Tree	7.938

C2: N. Ellsworth Olives and Tulip Trees



222 E. 4th Street San Mateo		Tree Inventory, Assessment, and Protection Report			July 17, 2020 Revised October 20, 2021	
Tree Species	#	Trunk Diameter (in.)	Condition	Expected Impact	Disposition	L/U Value
Brisbane box (<i>Lophostemon confertus</i>)	31	13	Fair	High	Street Tree	7.371
hackberry (<i>Celtis occidentalis</i>)	32	8	Fair	High	Street Tree	3.528
hackberry (<i>Celtis occidentalis</i>)	33	7	Fair	High	Street Tree	3.087
hackberry (<i>Celtis occidentalis</i>)	34	6	Fair	High	Street Tree	2.646
hackberry (<i>Celtis occidentalis</i>)	35	6	Fair	High	Street Tree	2.646
hackberry (<i>Celtis occidentalis</i>)	36	6	Fair	High	Street Tree	2.646
hackberry (<i>Celtis occidentalis</i>)	37	8	Fair	High	Street Tree	3.528
hackberry (<i>Celtis occidentalis</i>)	38	6	Fair	High	Street Tree	2.646
olive (<i>Olea eurpaea</i>)	39	7, 7, 6, 4, 2, 2	Good	High	Container	4.3218

C3: 5th Street Brisbane Box



Appendix C: Photographs
C1: 4th Street Hackberries



C4: B Street Hackberries



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PROJECT NUMBER
16010.00

SHEET TITLE
TREE INVENTORY

SCALE
NA

SHEET NUMBER

L-005

Qualifications, Assumptions, and Limiting Conditions

Any legal description provided to the consultant is assumed to be correct. Any titles or ownership of properties are assumed to be good and marketable. All property is appraised or evaluated as though free and clear, under responsible ownership and competent management.

All property is presumed to be in conformance with applicable codes, ordinances, statutes, or other regulations.

Care has been taken to obtain information from reliable sources. However, the consultant cannot be responsible for the accuracy of information provided by others.

The consultant shall not be required to give testimony or attend meetings, hearings, conferences, mediations, arbitration, or trials by reason of this report unless subsequent contractual arrangements are made, including payment of an additional fee for such services.

This report and any appraisal value expressed herein represent the opinion of the consultant, and the consultant's fee is not contingent upon the reporting of a specified appraisal value, a stipulated result, or the occurrence of a subsequent event.

Sketches, drawings, and photographs in this report are intended for use as visual aids, are not necessarily to scale, and should not be construed as engineering or architectural reports or surveys. The reproduction of information generated by architects, engineers, or other consultants on any sketches, drawings, or photographs is only for coordination and ease of reference. Inclusion of said information with any drawings or other documents does not constitute a representation as to the sufficiency or accuracy of said information.

Unless otherwise expressed: a) this report covers only examined items and their condition at the time of inspection; and b) the inspection is limited to visual examination of accessible items without dissection, excavation, probing, or coring. There is no warranty or guarantee, expressed or implied, that structural problems or deficiencies of plants or property may not arise in the future.

Required Tree Planting

Zoning Code, Section 27.71 – Landscape, requires all projects to have a minimum ratio of **1 tree per 400 square feet** of landscaped area. Existing trees that are a minimum of 6 inch diameter may count toward this total.

Landscape Area: **6706.56** sq. ft. ÷ 400 = **16.77** (a)

Number of existing trees from Tree Evaluation Schedule with a 6 inch or greater diameter **to be preserved:** **0** (b)

Landscape Unit (LU) value of trees **to be removed** from the Tree Evaluation Schedule: **3.087** (c)

Minimum LU value to be replaced and/or met through payment of in-lieu fees: **[a – b + c = d]** **19.8957** (d)

New Trees:

A “landscape unit” (LU) value equivalent to (d) above, must either be planted on site, or an “in-lieu” fee paid to the city’s street tree planting fund. If the LU value shown at (e) is not equal or greater than (d), then an in-lieu fee must be paid to the City’s street tree planting fund at the rate defined annually in the City’s Comprehensive Fee Schedule for each deficient LU.

New Trees Being Planted*			
Quantity	Size	LU Value	Total LU Value
	15 gallon	1	
	24 inch box	2	
	36 inch box	3	
4	48 inch box	4	16
Total LU Value of new trees being proposed:			16 (e)

*New replacement trees shall be in addition to and not substitute requirements for new street trees, parking lot trees or other required trees.

Fees Owed to the City Street Tree Planting Fund:

If (d) is greater than (e), there will be an LU value deficit calculated as follows:

[d – e = **3.86** x (the annually defined \$ per LU value as per Current Comprehensive Fee Schedule) = \$ **1252.7**

Certification of Performance

I Richard Gessner, Certify:

That I have personally inspected the tree(s) and/or the property referred to in this report, and have stated my findings accurately. The extent of the evaluation and/or appraisal is stated in the attached report and Terms of Assignment;

That I have no current or prospective interest in the vegetation or the property that is the subject of this report, and I have no personal interest or bias with respect to the parties involved;

That the analysis, opinions and conclusions stated herein are my own;

That my analysis, opinions, and conclusions were developed and this report has been prepared according to commonly accepted Arboricultural practices;

That no one provided significant professional assistance to the consultant, except as indicated within the report.

That my compensation is not contingent upon the reporting of a predetermined conclusion that favors the cause of the client or any other party, nor upon the results of the assessment, the attainment of stipulated results, or the occurrence of any other subsequent events;

I further certify that I am a Registered Consulting Arborist® with the American Society of Consulting Arborists, and that I acknowledge, accept and adhere to the ASCA Standards of Professional Practice. I am an International Society of Arboriculture Board Certified Master Arborist® and Tree Risk Assessor Qualified. I have been involved with the practice of Arboriculture and the care and study of trees since 1998.

Richard J. Gessner

ASCA Registered Consulting Arborist® #496
ISA Board Certified Master Arborist® WE-4341B

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Tree Number	Species	Fate: Preserve / Remove	Species Value %	Condition Value %	Location Value %	Divided by 0.35	Caliper Size (in.)	.7 if in allowable bldg. area 1 if in setback	1.25 if Heritage Tree 1 if not	LU Value
1	olive (<i>Olea europaea</i>)	Remove	0.7	0.7	0.63	0.88	4	0.7	1	2.4696
2	hackberry (<i>Celtis occidentalis</i>)	Remove	0.7	0.7	0.63	0.88	7	0.7	1	4.3218
3	hackberry (<i>Celtis occidentalis</i>)	Remove	0.7	0.7	0.63	0.88	9	0.7	1	5.5666
4	hackberry (<i>Celtis occidentalis</i>)	Remove	0.7	0.7	0.63	0.88	7	0.7	1	4.3218
5	hackberry (<i>Celtis occidentalis</i>)	Remove	0.7	0.7	0.63	0.88	6	0.7	1	3.7044
6	hackberry (<i>Celtis occidentalis</i>)	Remove	0.7	0.7	0.63	0.88	7	0.7	1	4.3218
7	hackberry (<i>Celtis occidentalis</i>)	Remove	0.7	0.7	0.63	0.88	5	0.7	1	3.087
8	hackberry (<i>Celtis occidentalis</i>)	Remove	0.7	0.7	0.63	0.88	8	0.7	1	4.9392
9	hackberry (<i>Celtis occidentalis</i>)	Remove	0.7	0.7	0.63	0.88	9	0.7	1	5.5666
10	hackberry (<i>Celtis occidentalis</i>)	Remove	0.7	0.7	0.63	0.88	11	0.7	1	6.7914
11	olive (<i>Olea europaea</i>)	Remove	0.7	0.7	0.63	0.88	5	0.7	1	3.087
12	olive (<i>Olea europaea</i>)	Remove	0.7	0.7	0.63	0.88	8	0.7	1	4.9392
13	olive (<i>Olea europaea</i>)	Remove	0.7	0.7	0.63	0.88	5	0.7	1	3.087
14	olive (<i>Olea europaea</i>)	Remove	0.7	0.7	0.63	0.88	5	0.7	1	3.087
15	tulip poplar (<i>Liriodendron tulipifera</i>)	Remove	0.3	0.7	0.63	0.38	7	0.7	1	1.8522
16	hackberry (<i>Celtis occidentalis</i>)	Remove	0.7	0.7	0.63	0.88	1	0.7	1	0.6174
17	tulip poplar (<i>Liriodendron tulipifera</i>)	Remove	0.3	0.7	0.63	0.38	7	0.7	1	1.8522
18	olive (<i>Olea europaea</i>)	Remove	0.7	0.7	0.63	0.88	3	0.7	1	1.8522
19	olive (<i>Olea europaea</i>)	Remove	0.7	0.7	0.63	0.88	5	0.7	1	3.087
20	tulip poplar (<i>Liriodendron tulipifera</i>)	Remove	0.3	0.7	0.63	0.38	5	0.7	1	1.323
21	tulip poplar (<i>Liriodendron tulipifera</i>)	Remove	0.3	0.3	0.63	0.16	1	0.7	1	0.1134
22	tulip poplar (<i>Liriodendron tulipifera</i>)	Remove	0.3	0.7	0.63	0.38	7	0.7	1	1.8522
23	olive (<i>Olea europaea</i>)	Remove	0.7	0.7	0.63	0.88	7	0.7	1	4.3218
24	olive (<i>Olea europaea</i>)	Remove	0.7	0.7	0.63	0.88	8	0.7	1	4.9392
25	Brisbane box (<i>Lophostemon confertus</i>)	Remove	0.9	0.5	0.63	0.81	12	0.7	1	6.804
26	Brisbane box (<i>Lophostemon confertus</i>)	Remove	0.9	0.7	0.63	1.13	12	0.7	1	9.5256
27	olive (<i>Olea europaea</i>)	Remove	0.7	0.7	0.63	0.88	5	0.7	1	3.087
28	Brisbane box (<i>Lophostemon confertus</i>)	Remove	0.9	0.7	0.63	1.13	13	0.7	1	10.3194
29	Brisbane box (<i>Lophostemon confertus</i>)	Remove	0.9	0.5	0.63	0.81	14	0.7	1	7.938
30	Brisbane box (<i>Lophostemon confertus</i>)	Remove	0.9	0.5	0.63	0.81	14	0.7	1	7.938
31	Brisbane box (<i>Lophostemon confertus</i>)	Remove	0.9	0.5	0.63	0.81	13	0.7	1	7.371
32	hackberry (<i>Celtis occidentalis</i>)	Remove	0.7	0.5	0.63	0.63	8	0.7	1	3.528
33	hackberry (<i>Celtis occidentalis</i>)	Remove	0.7	0.5	0.63	0.63	7	0.7	1	3.087
34	hackberry (<i>Celtis occidentalis</i>)	Remove	0.7	0.5	0.63	0.63	6	0.7	1	2.646
35	hackberry (<i>Celtis occidentalis</i>)	Remove	0.7	0.5	0.63	0.63	6	0.7	1	2.646
36	hackberry (<i>Celtis occidentalis</i>)	Remove	0.7	0.5	0.63	0.63	6	0.7	1	2.646
37	hackberry (<i>Celtis occidentalis</i>)	Remove	0.7	0.5	0.63	0.63	8	0.7	1	3.528
38	hackberry (<i>Celtis occidentalis</i>)	Remove	0.7	0.5	0.63	0.63	6	0.7	1	2.646
39	olive (<i>Olea europaea</i>)	Remove	0.7	0.7	0.63	0.88	7	0.7	1	4.3218
TOTAL										159.1128

222 EAST 4TH

LANE PARTNERS

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ARCHITECTS
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2325 Third Street #210
San Francisco CA 94107
415.503.0060

ISSUES AND REVISIONS

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PROJECT NUMBER
16010.00

SHEET TITLE
TREE INVENTORY

SCALE
NA

SHEET NUMBER

L-006

PLANT SCHEDULE						
TREES	CODE	BOTANICAL NAME	COMMON NAME	CONT	QTY	REMARKS
	Os	OLEA EUROPAEA 'SWAN HILL' TM	SWAN HILL OLIVE	---	4	
	Qh	QUERCUS HYPOLEUCOIDES	SILVERLEAF OAK	---	10	
	Qs	QUERCUS VIRGINIANA 'SKY CLIMBER'	SKY CLIMBER SOUTHERN LIVE OAK	---	23	

REFERENCE NOTES SCHEDULE		
0 GENERAL		
SYMBOL	DESCRIPTION	
[0-01]	CURB CUT, S.C.D.	
2 PAVING + EDGES		
SYMBOL	DESCRIPTION	NOTES
[2-01]	CONC. PAVING	C.I.P. INTEGRAL COLOR CONC. PAVING
[2-02]	CONC. UNIT PAVING TYPE I	3"X12" PRECAST CONC. PAVERS - COLOR: PORCELAIN
[2-03]	CONC. UNIT PAVING TYPE II	3"X12" PRECAST CONC. PAVERS - COLOR: FRENCH GREY
3 SITE WALLS AND STAIRS		
SYMBOL	DESCRIPTION	NOTES
[3-01]	RAISED METAL PLANTER	CUSTOM POWDERCOATED PLANTERS - COLOR: CHARCOAL
5 SITE FURNISHINGS		
SYMBOL	DESCRIPTION	NOTES
[5-01]	WOOD BENCH TYPE I	7'-8" WOOD BENCH WITH ARMREST, GALV. BASES
[5-02]	WOOD BENCH TYPE II	9'-10" WOOD BENCH WITH ARMRESTS, GALV. STEEL BASES
[5-03]	WOOD BENCH TYPE III	23"X23" WOOD CUBE BENCH, GALV. STEEL BASE
[5-04]	WOOD BENCH TYPE IV	CUSTOM WOOD BENCH WITH ARMRESTS AT RAISED METAL PLANTERS
[5-05]	WOOD BENCH TYPE V	WOOD BENCH AT TREE GRATE, STEEL BASES TO MATCH GRATES
[5-06]	WOOD DINING TABLE	WOOD TABLE AND BECH WITH ARMREST, GALV. STEEL BASES
[5-07]	BIKE RACK	WELLE CIRCULAR RACK - STAINLESS FINISH
[5-08]	TREE GRATE	POWDERCOATED STEEL TREE GRATE
[5-11]	MOVABLE SITE FURNISHING	TBD FF&E BY OTHERS, SHOWN FOR REFERENCE
7 PLANTING		
SYMBOL	DESCRIPTION	
[7-01]	NATIVE OR ADAPTED PLANTING	
[7-02]	BIOTREATMENT PLANTING	
8 SITE LIGHTING		
SYMBOL	DESCRIPTION	DESCRIPTION
[8-01]	SITE LIGHTING	SEE LIGHTING DRAWINGS

NOTES:
1. SEE L-205 FOR MATERIALS AND FURNISHINGS IMAGES
2. SEE L-300 FOR FURNISHING DETAILS



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PROJECT NUMBER
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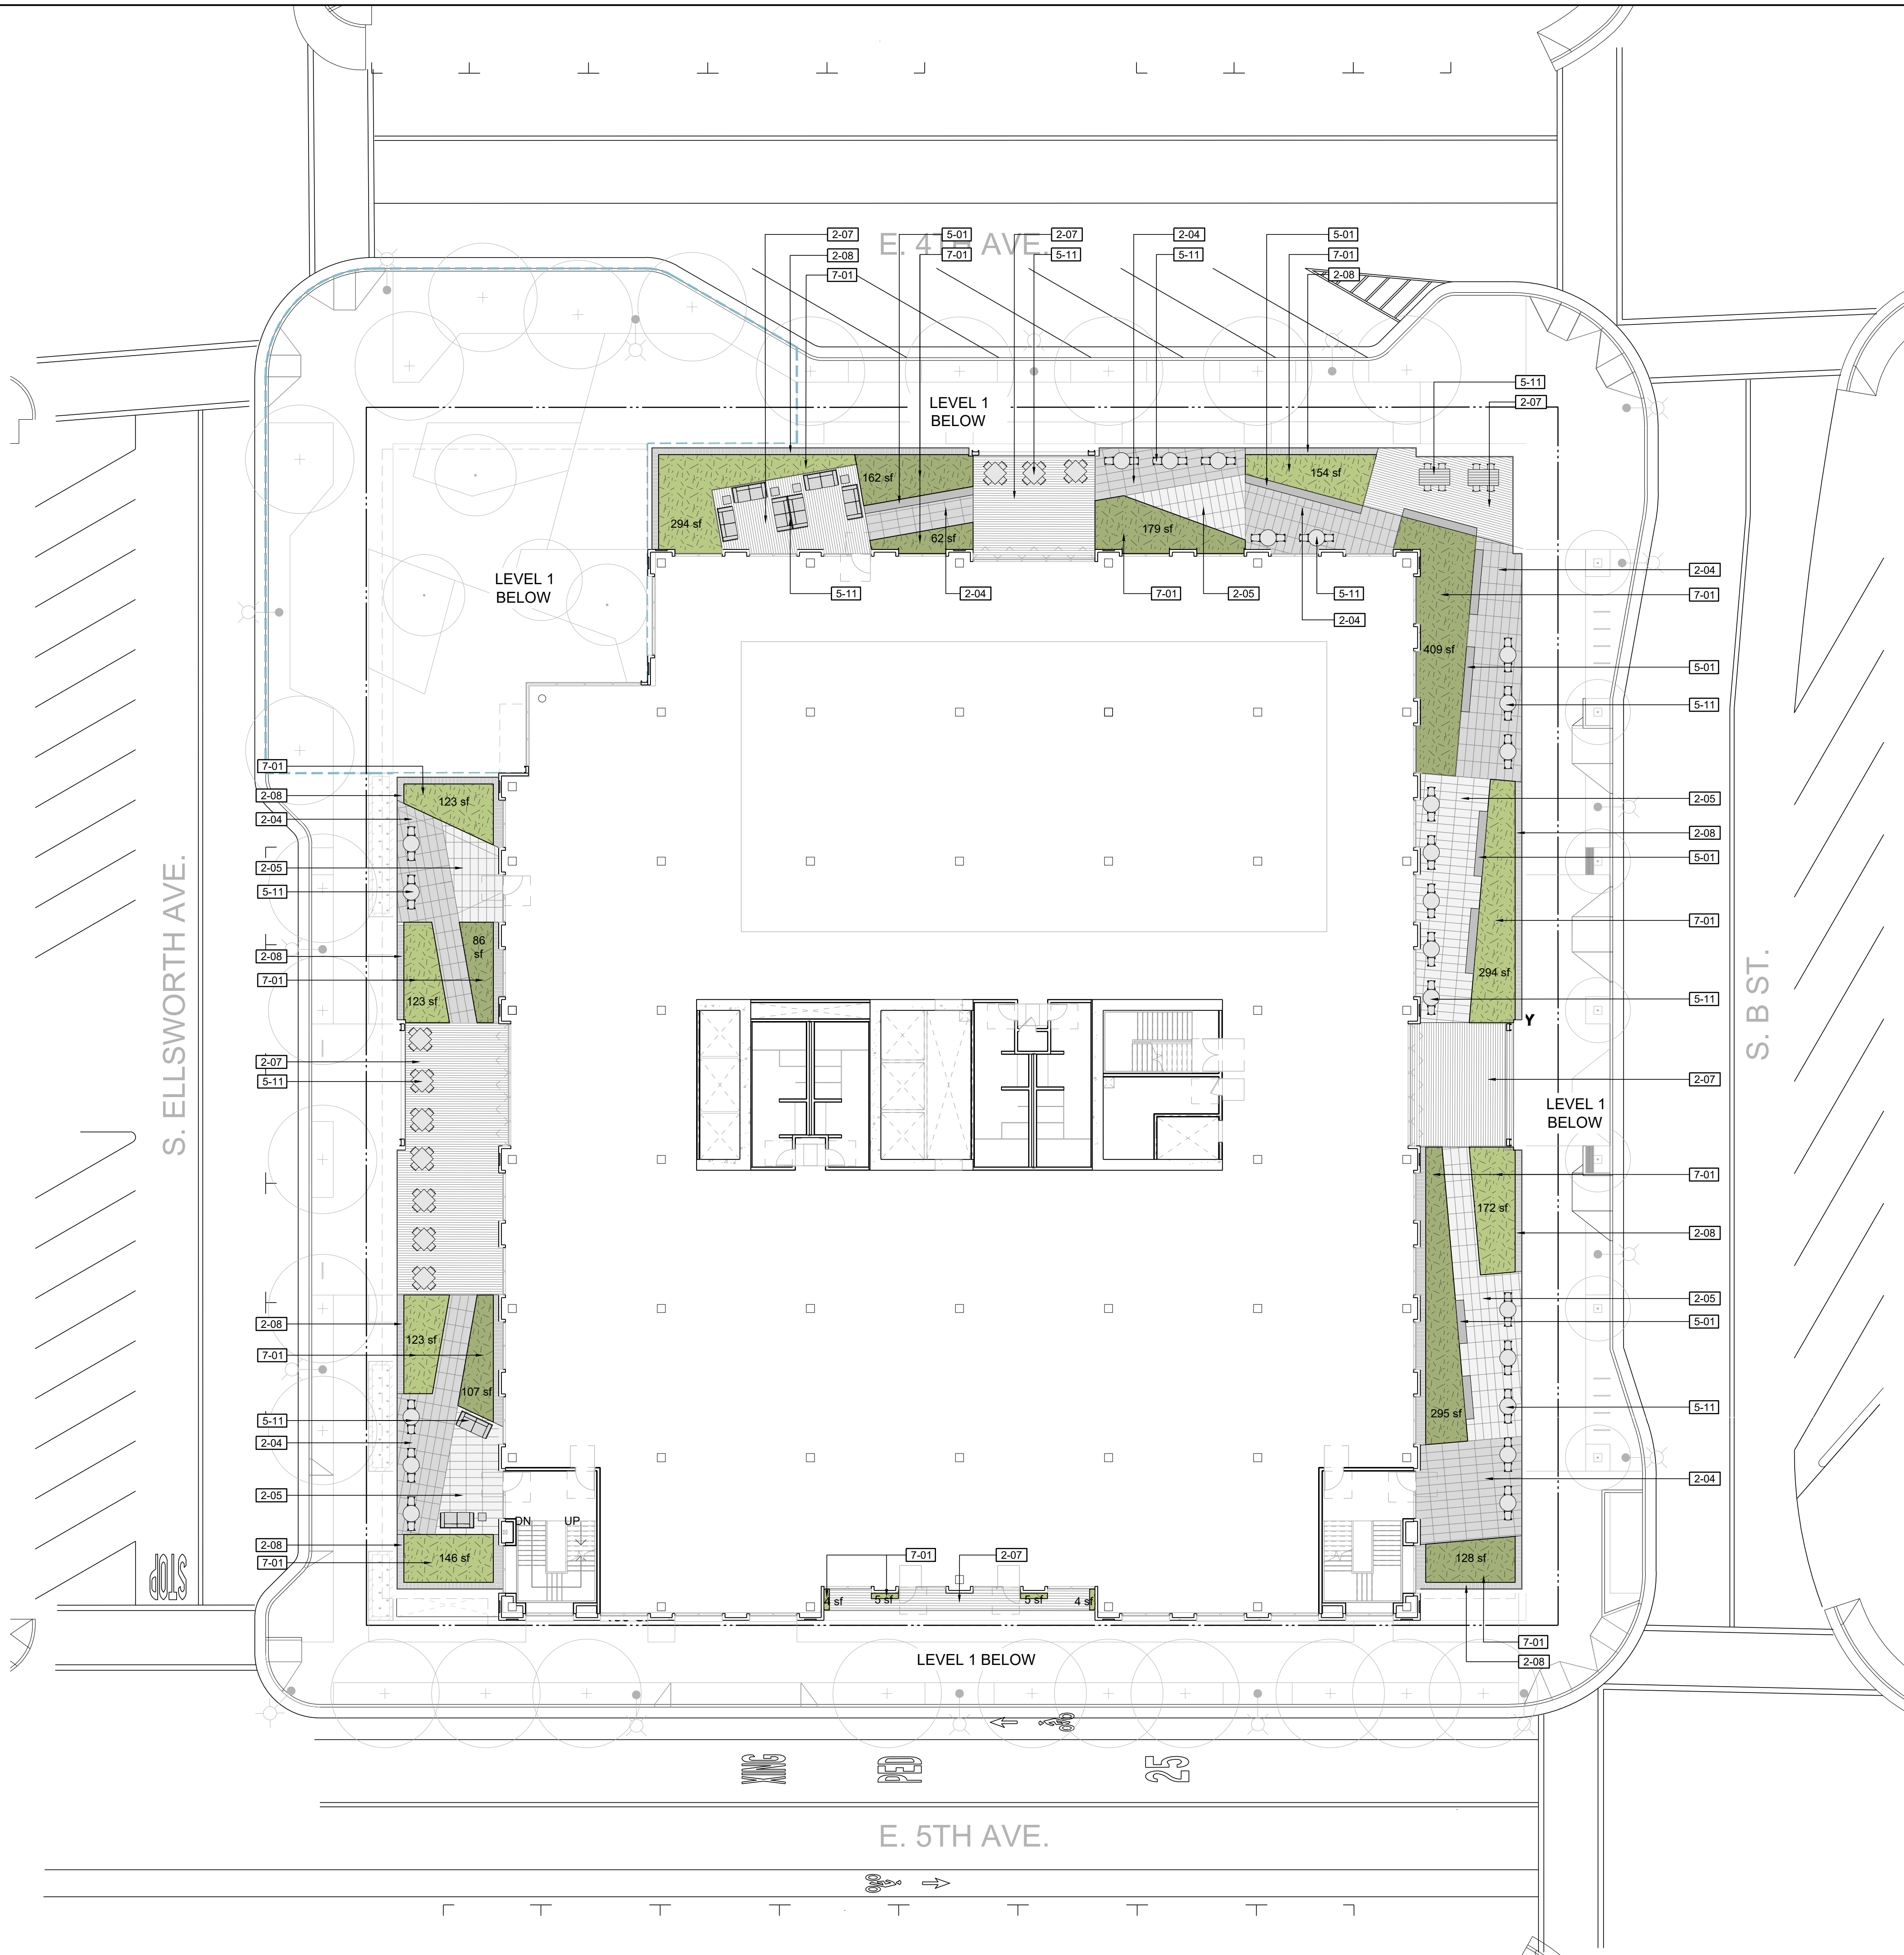
SHEET TITLE
LEVEL 1 LANDSCAPE PLAN

SCALE
1/16"=1'-0"

SHEET NUMBER

L-100

REFERENCE NOTES SCHEDULE			
2 PAVING + EDGES			
SYMBOL	DESCRIPTION	NOTES	SOURCE
2-04	PEDESTAL PAVING TYPE I	18"x36" PRECAST CONC. PAVERS - COLOR: FRENCH GREY	STEPSTONE, INC.
2-05	PEDESTAL PAVING TYPE II	18"x36" PRECAST CONC. PAVERS - COLOR: PORCELAIN	STEPSTONE, INC.
2-07	PEDESTAL PAVING TYPE IV	24"x48" THERMALLY MODIFIED ASH DECKING TILES	THERMORY
2-08	ACCESS GRATING	STAINLESS STEEL PRESSED GRATING	
5 SITE FURNISHINGS			
SYMBOL	DESCRIPTION	NOTES	SOURCE
5-01	WOOD BENCH TYPE I	7'-8" WOOD BENCH WITH ARMREST, GALV. BASES	STREETLIFE, LLC
5-11	MOVABLE SITE FURNISHING	TBD FF&E BY OTHERS, SHOWN FOR REFERENCE	
7 PLANTING			
SYMBOL	DESCRIPTION		
7-01	NATIVE OR ADAPTED PLANTING		



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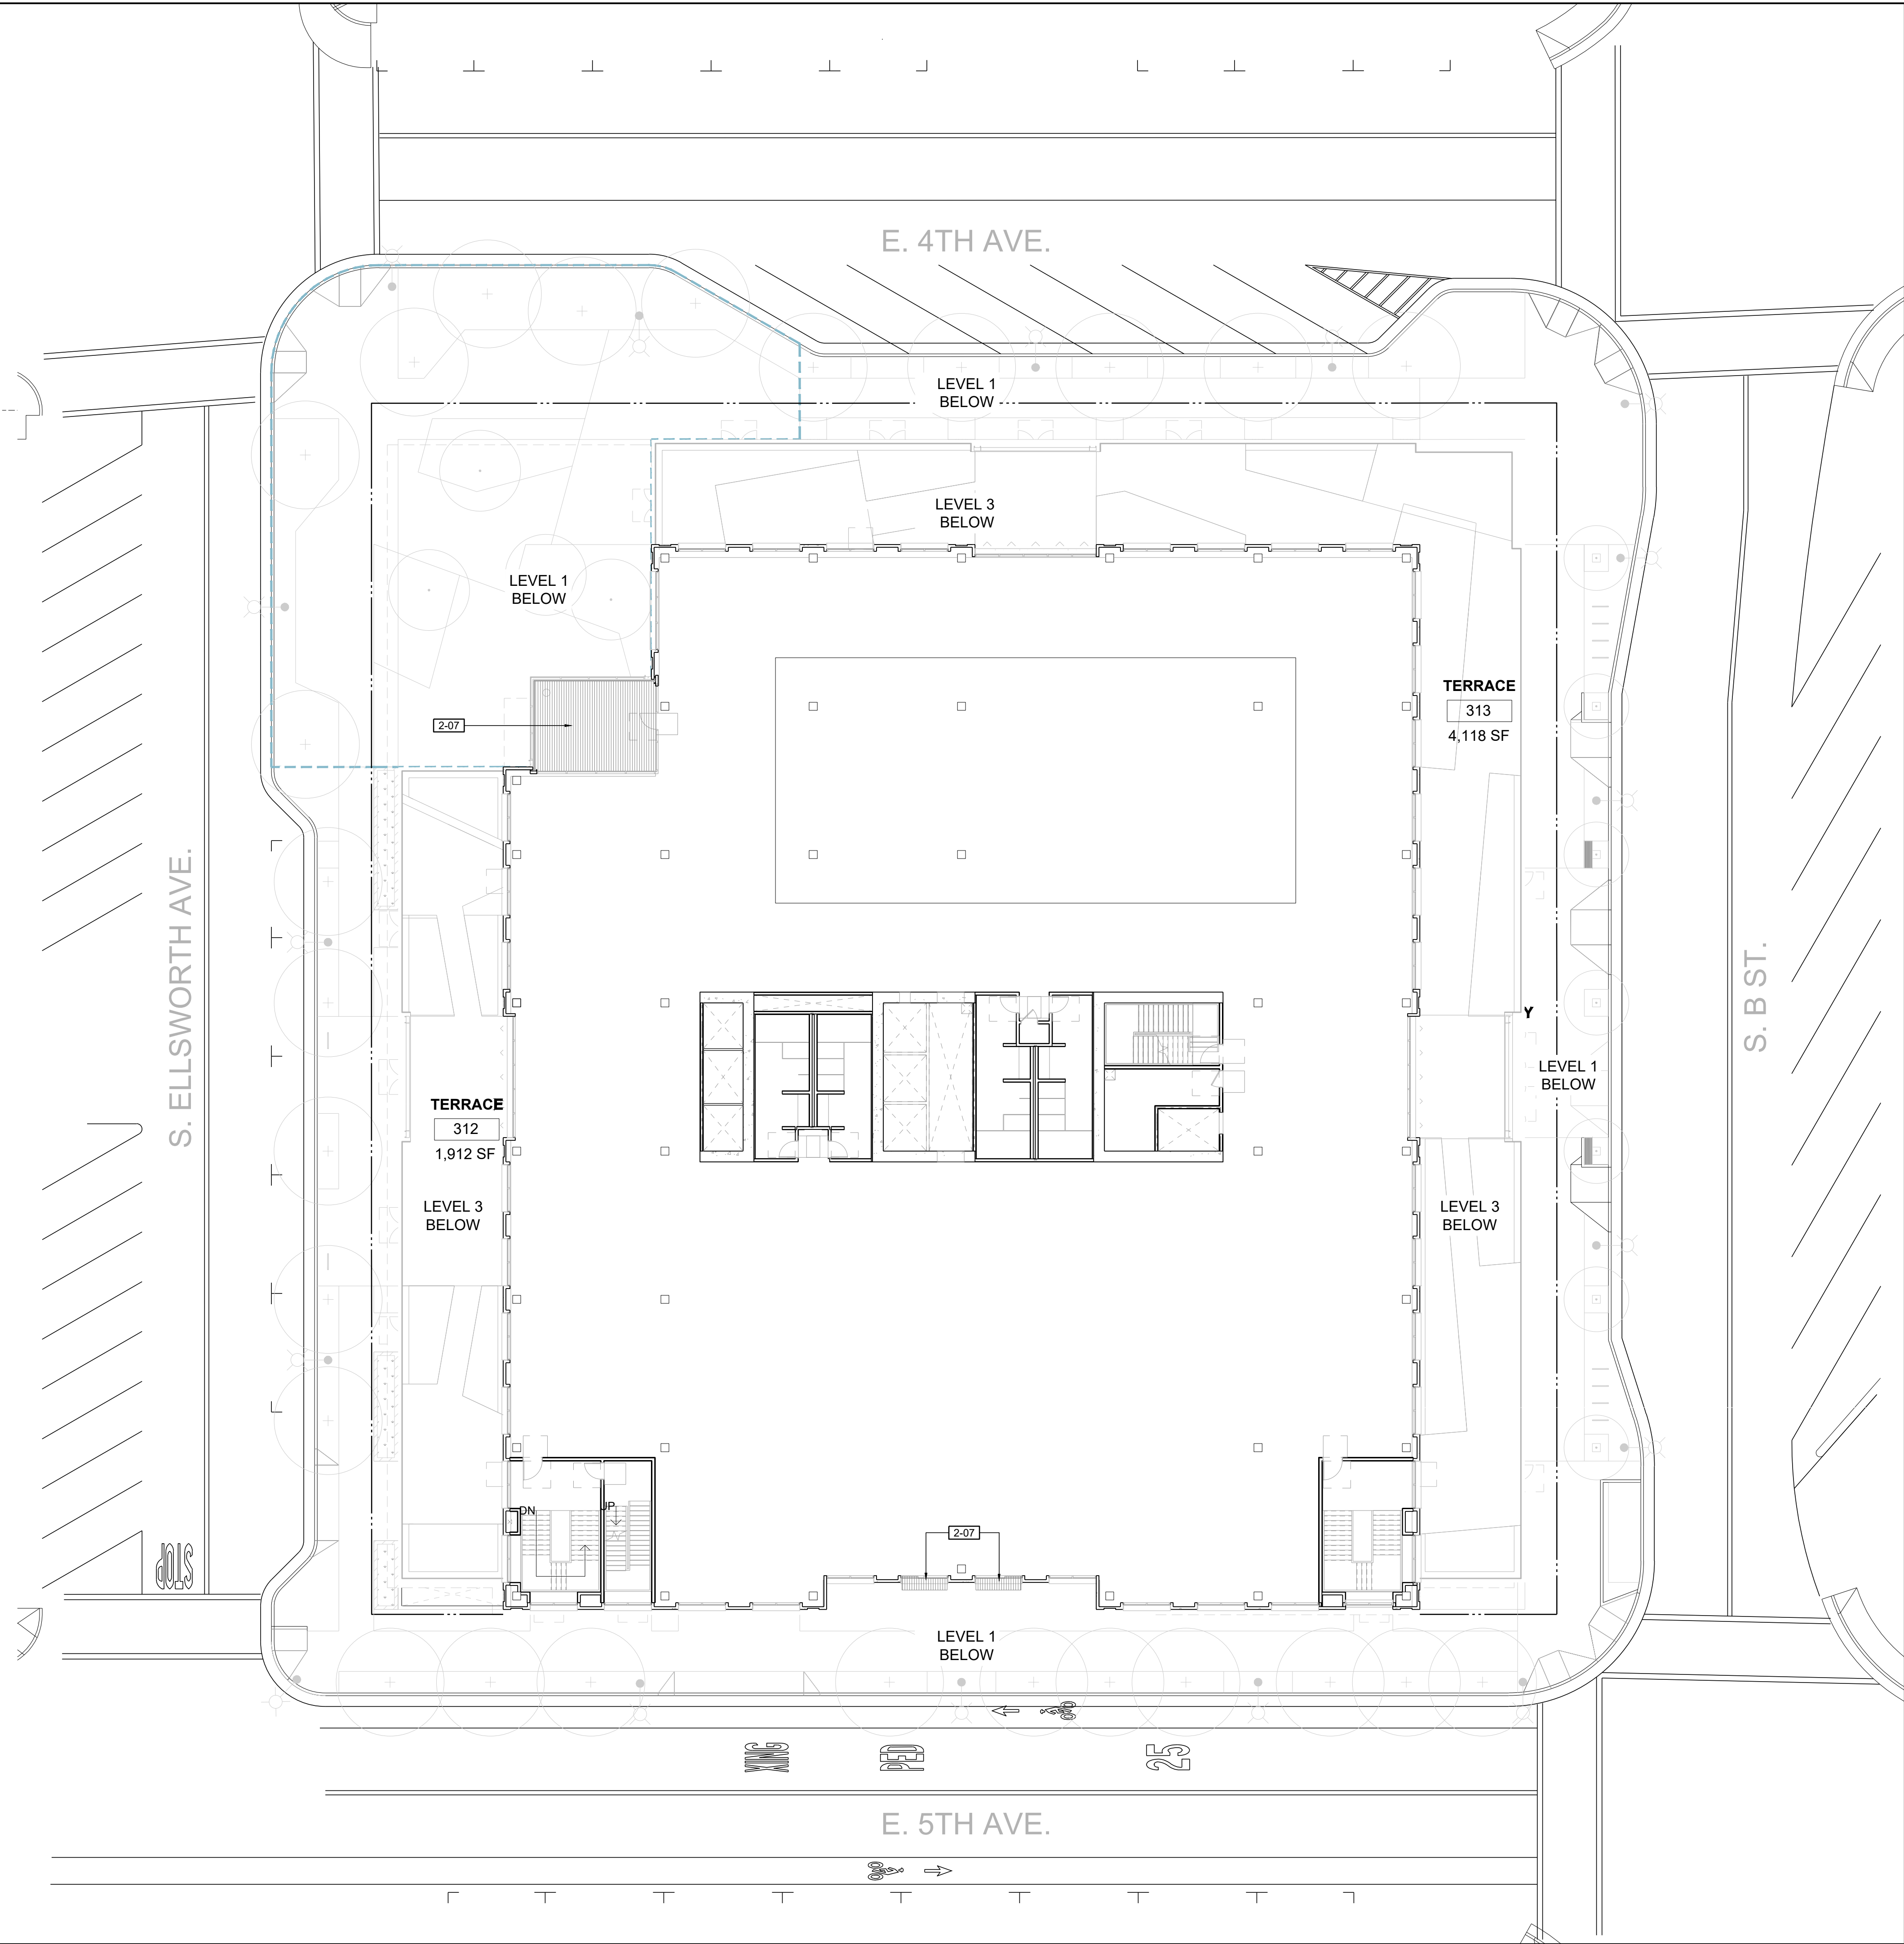
SHEET TITLE
LEVEL 3 LANDSCAPE PLAN

SCALE
1/16"=1'-0"

SHEET NUMBER

L-101

REFERENCE NOTES SCHEDULE			
SYMBOL	DESCRIPTION	NOTES	SOURCE
2-07	PEDESTAL PAVING TYPE IV	24"x48" THERMALLY MODIFIED ASH DECKING TILES	THERMORY



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PROJECT NUMBER
16010.00

SHEET TITLE
LEVEL 4 LANDSCAPE PLAN

SCALE
1/16"=1'-0"

SHEET NUMBER

L-102

REFERENCE NOTES SCHEDULE			
2 PAVING + EDGES			
SYMB OL	DESCRIPTION	NOTES	SOURCE
[2-04]	PEDESTAL PAVING TYPE I	18"x36" PRECAST CONC. PAVERS - COLOR: FRENCH GREY	STEPSTONE, INC.
[2-05]	PEDESTAL PAVING TYPE II	18"x36" PRECAST CONC. PAVERS - COLOR: PORCELAIN	STEPSTONE, INC.
[2-06]	PEDESTAL PAVING TYPE III	30"x30" PRECAST CONC. PAVERS - COLOR: PORCELAIN	STEPSTONE, INC.
[2-07]	PEDESTAL PAVING TYPE IV	24"x48" THERMALLY MODIFIED ASH DECKING TILES	THERMORY
[2-08]	ACCESS GRATING	STAINLESS STEEL PRESSED GRATING	
3 SITE WALLS AND STAIRS			
SYMB OL	DESCRIPTION	NOTES	SOURCE
[3-01]	RAISED METAL PLANTER	CUSTOM POWDERCOATED PLANTERS - COLOR: CHARCOAL	STREETLIFE, LLC
5 SITE FURNISHINGS			
SYMB OL	DESCRIPTION	NOTES	SOURCE
[5-01]	WOOD BENCH TYPE I	7'-8" WOOD BENCH WITH ARMREST, GALV. BASES	STREETLIFE, LLC
[5-09]	BBQ	CUSTOM BBQ AREA	
[5-10]	SCREEN	SEE ARCH DRAWINGS	
[5-11]	MOVABLE SITE FURNISHING	TBD FF&E BY OTHERS, SHOWN FOR REFERENCE	



222 EAST 4TH
LANE PARTNERS

LANE PARTNERS



ARCHITECTS
KORTH SUNSERI HAGEY



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LANDSCAPE ARCHITECTURE
2325 Third Street #210
San Francisco CA 94107
415.503.0060

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F	04/22/22	Pre-Application Resubmittal
G	06/15/22	Pre-Application Resubmittal

PROJECT NUMBER
16010.00

SHEET TITLE
ROOF LANDSCAPE PLAN

SCALE
1/16"=1'-0"

SHEET NUMBER

L-103



ARCHITECTS
KORTH SUNSERI HAGEY

AC
LA
ANDREA COCHRAN
LANDSCAPE ARCHITECTURE
2325 Third Street #210
San Francisco CA 94107
415.503.0060

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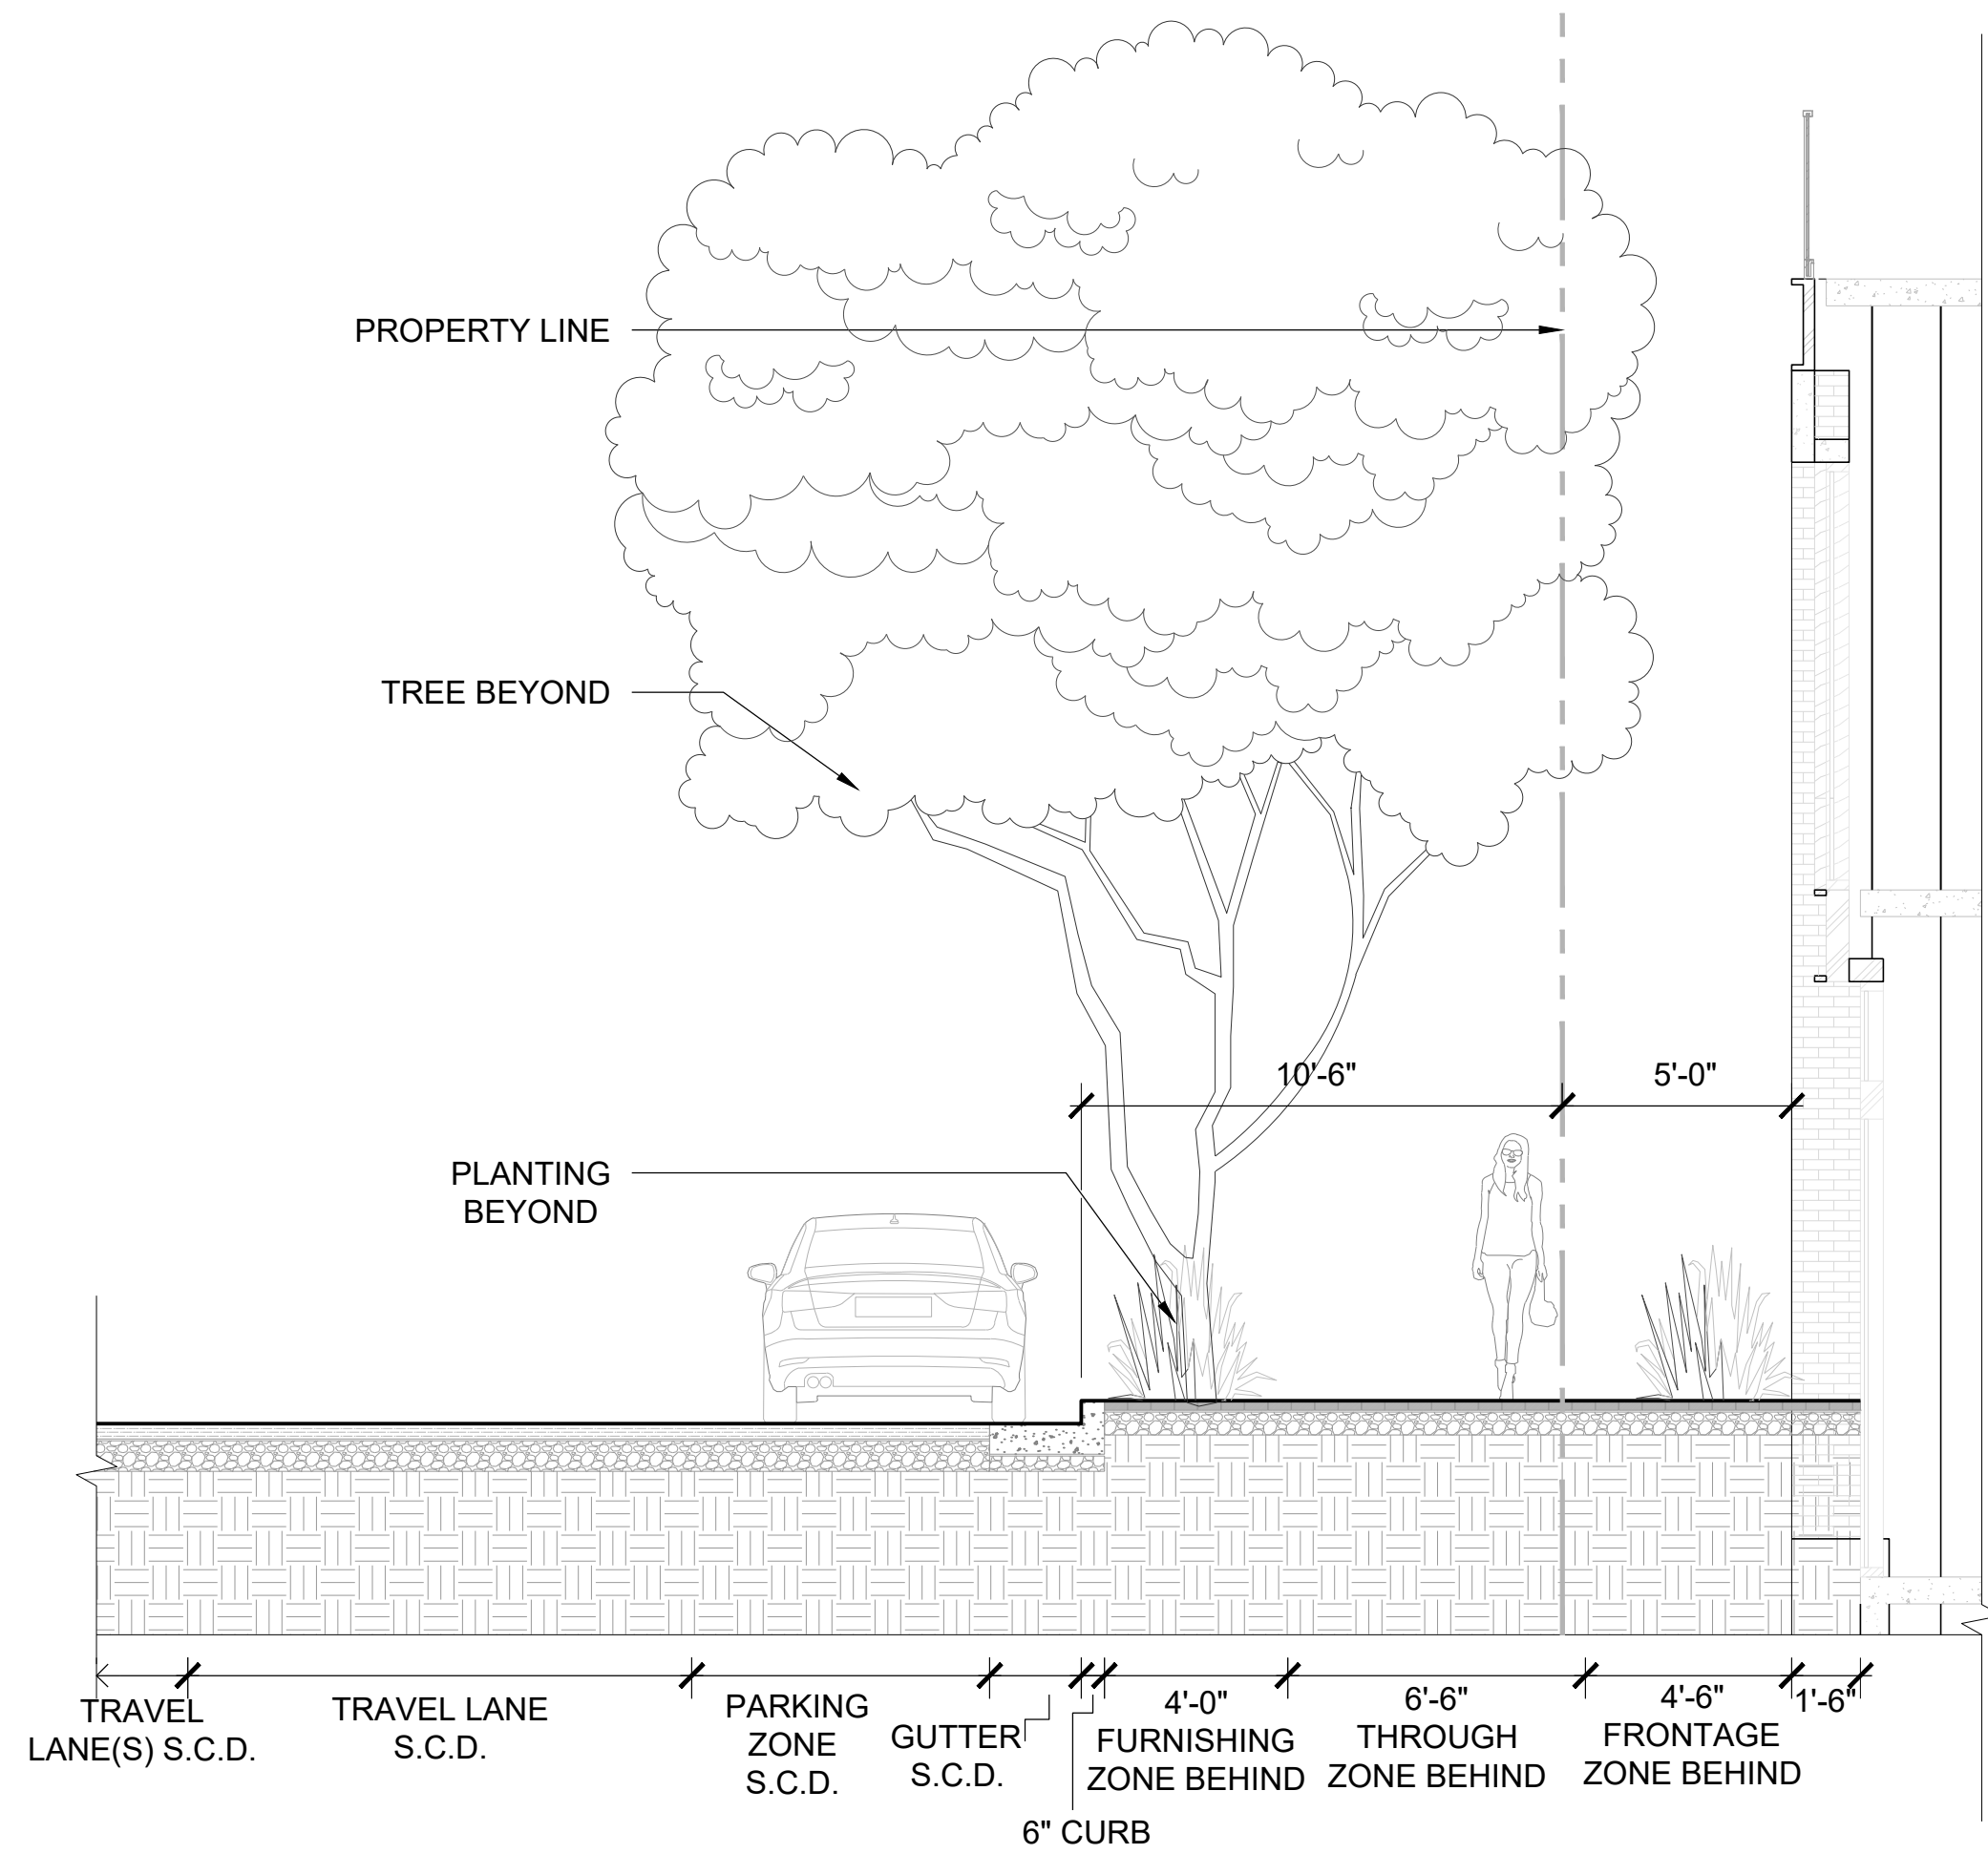
PROJECT NUMBER
16010.00

SHEET TITLE
STREETSCAPE SECTIONS


SCALE
AS NOTED

SHEET NUMBER


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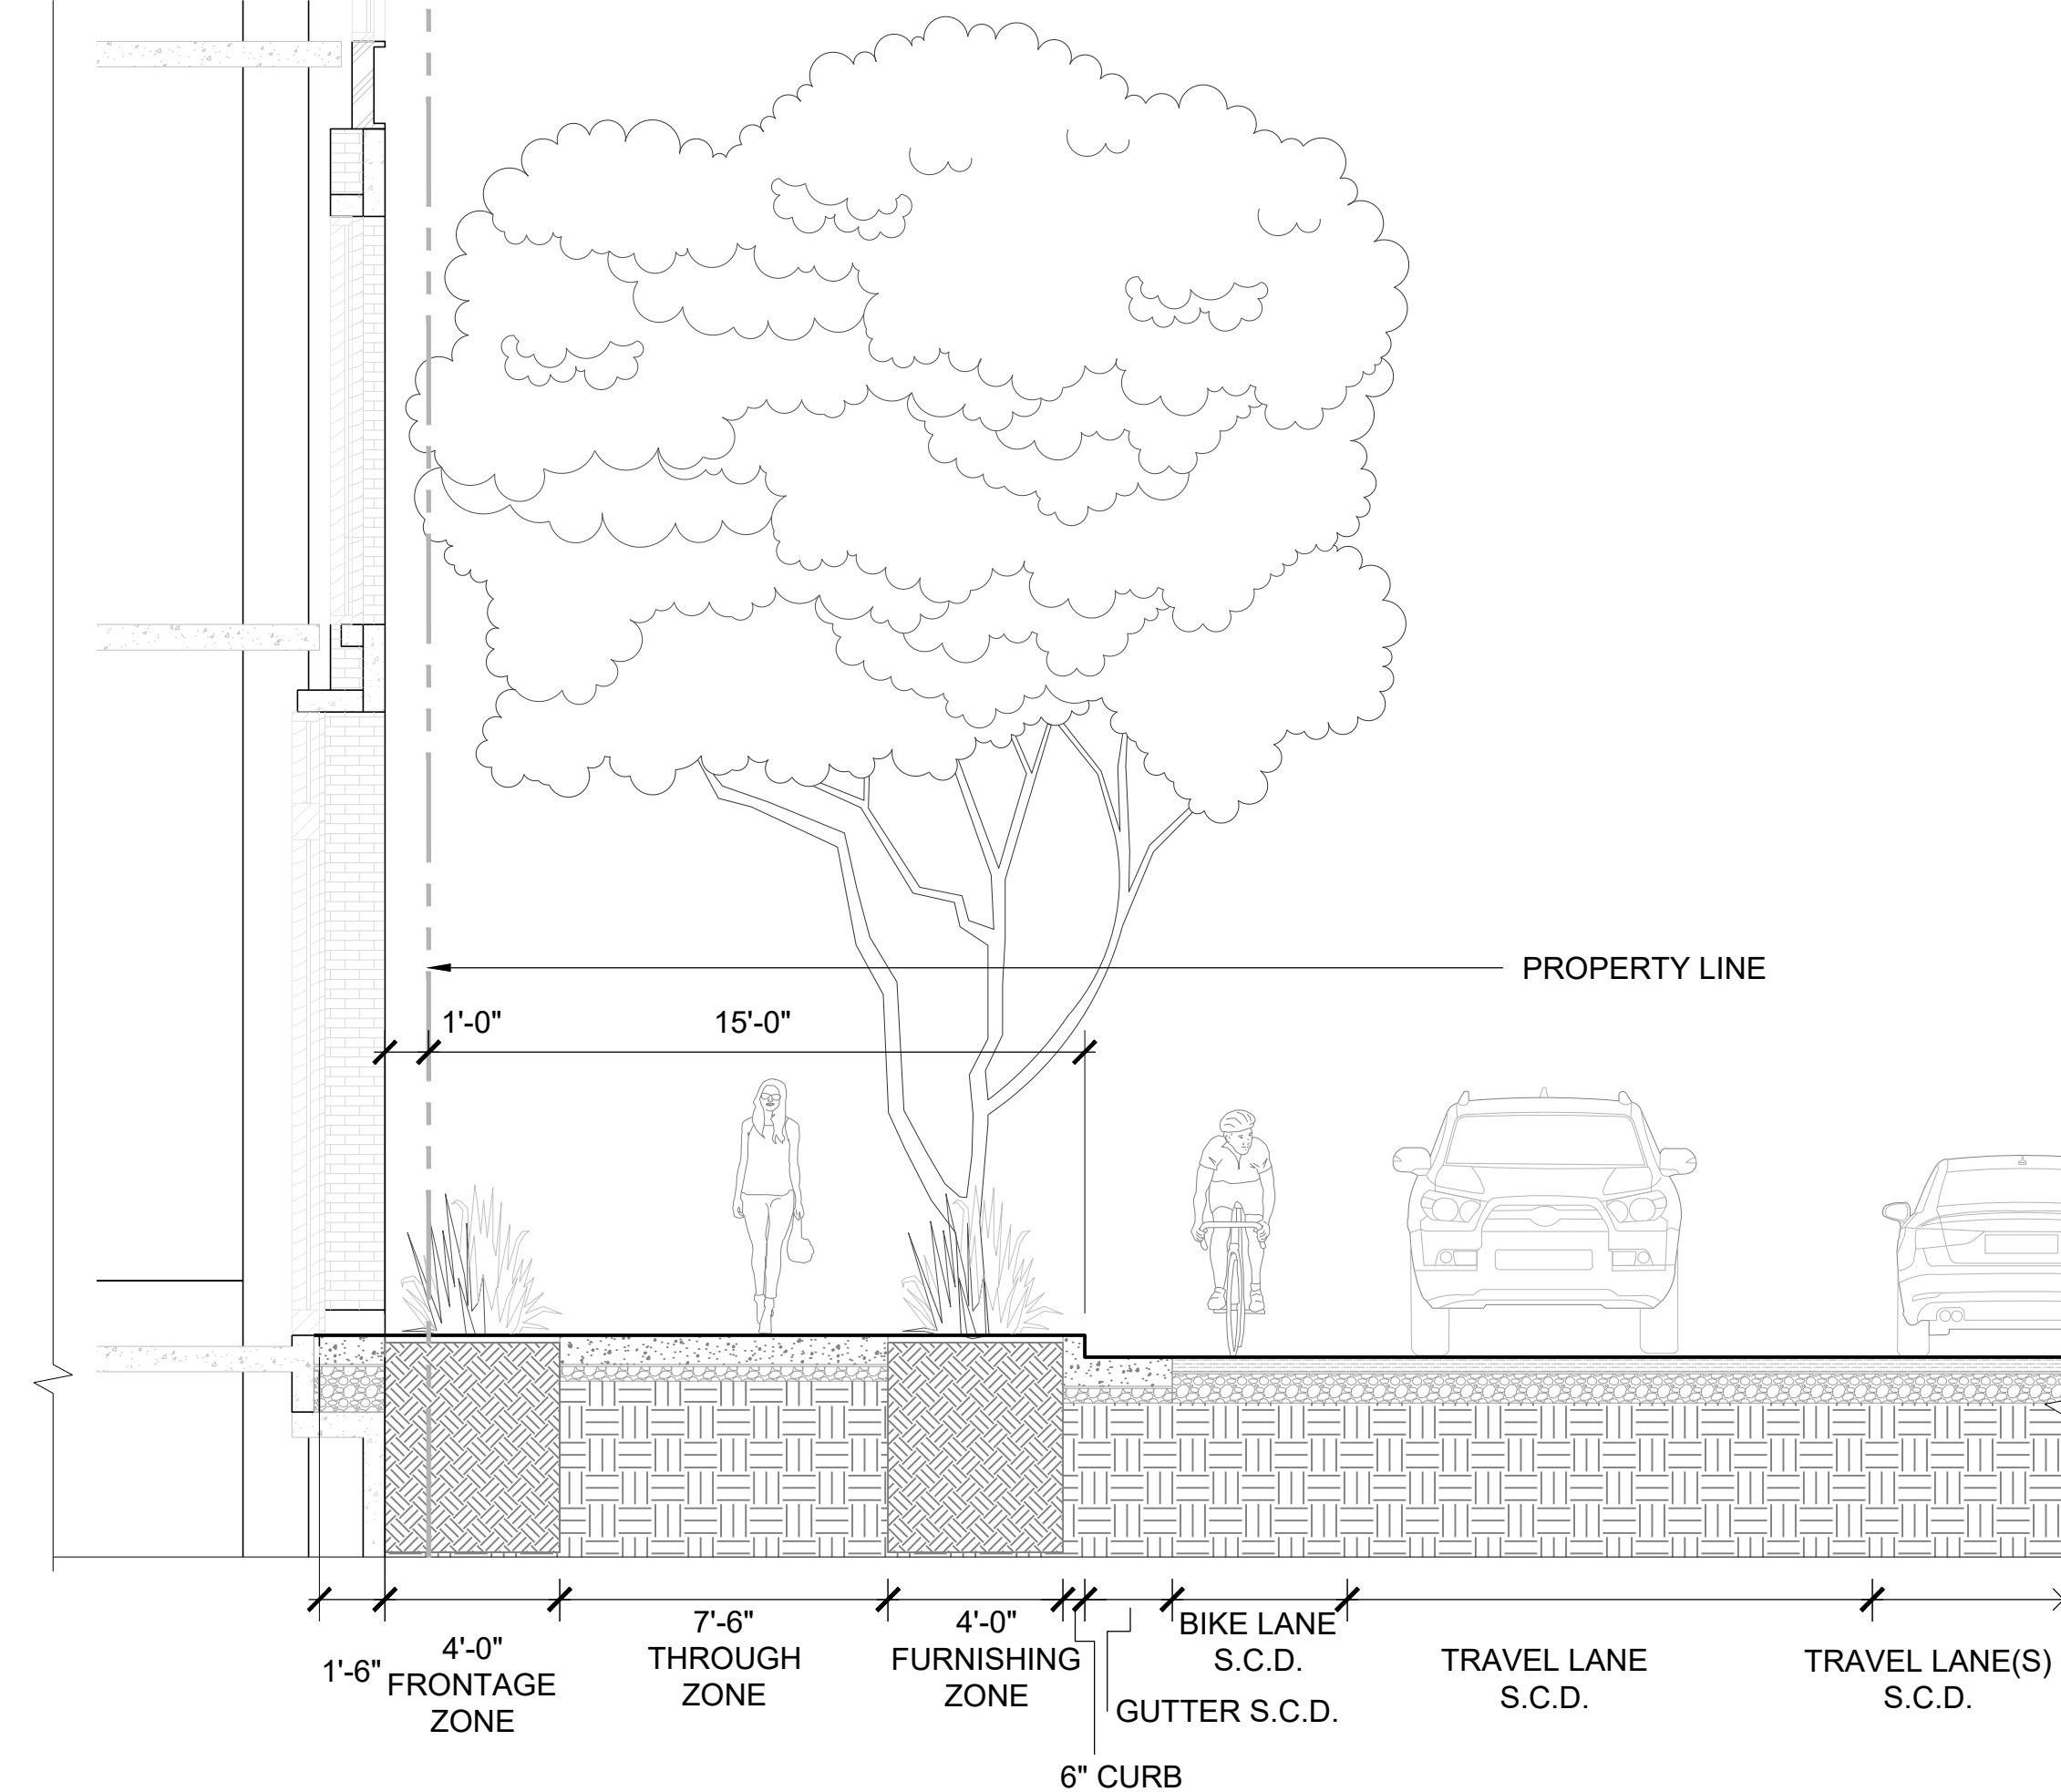
1 ELLSWORTH AVENUE
SCALE: 1/4" = 1'-0"
TYPICAL SECTION



2 B-STREET
SCALE: 1/4" = 1'-0"
TYPICAL SECTION

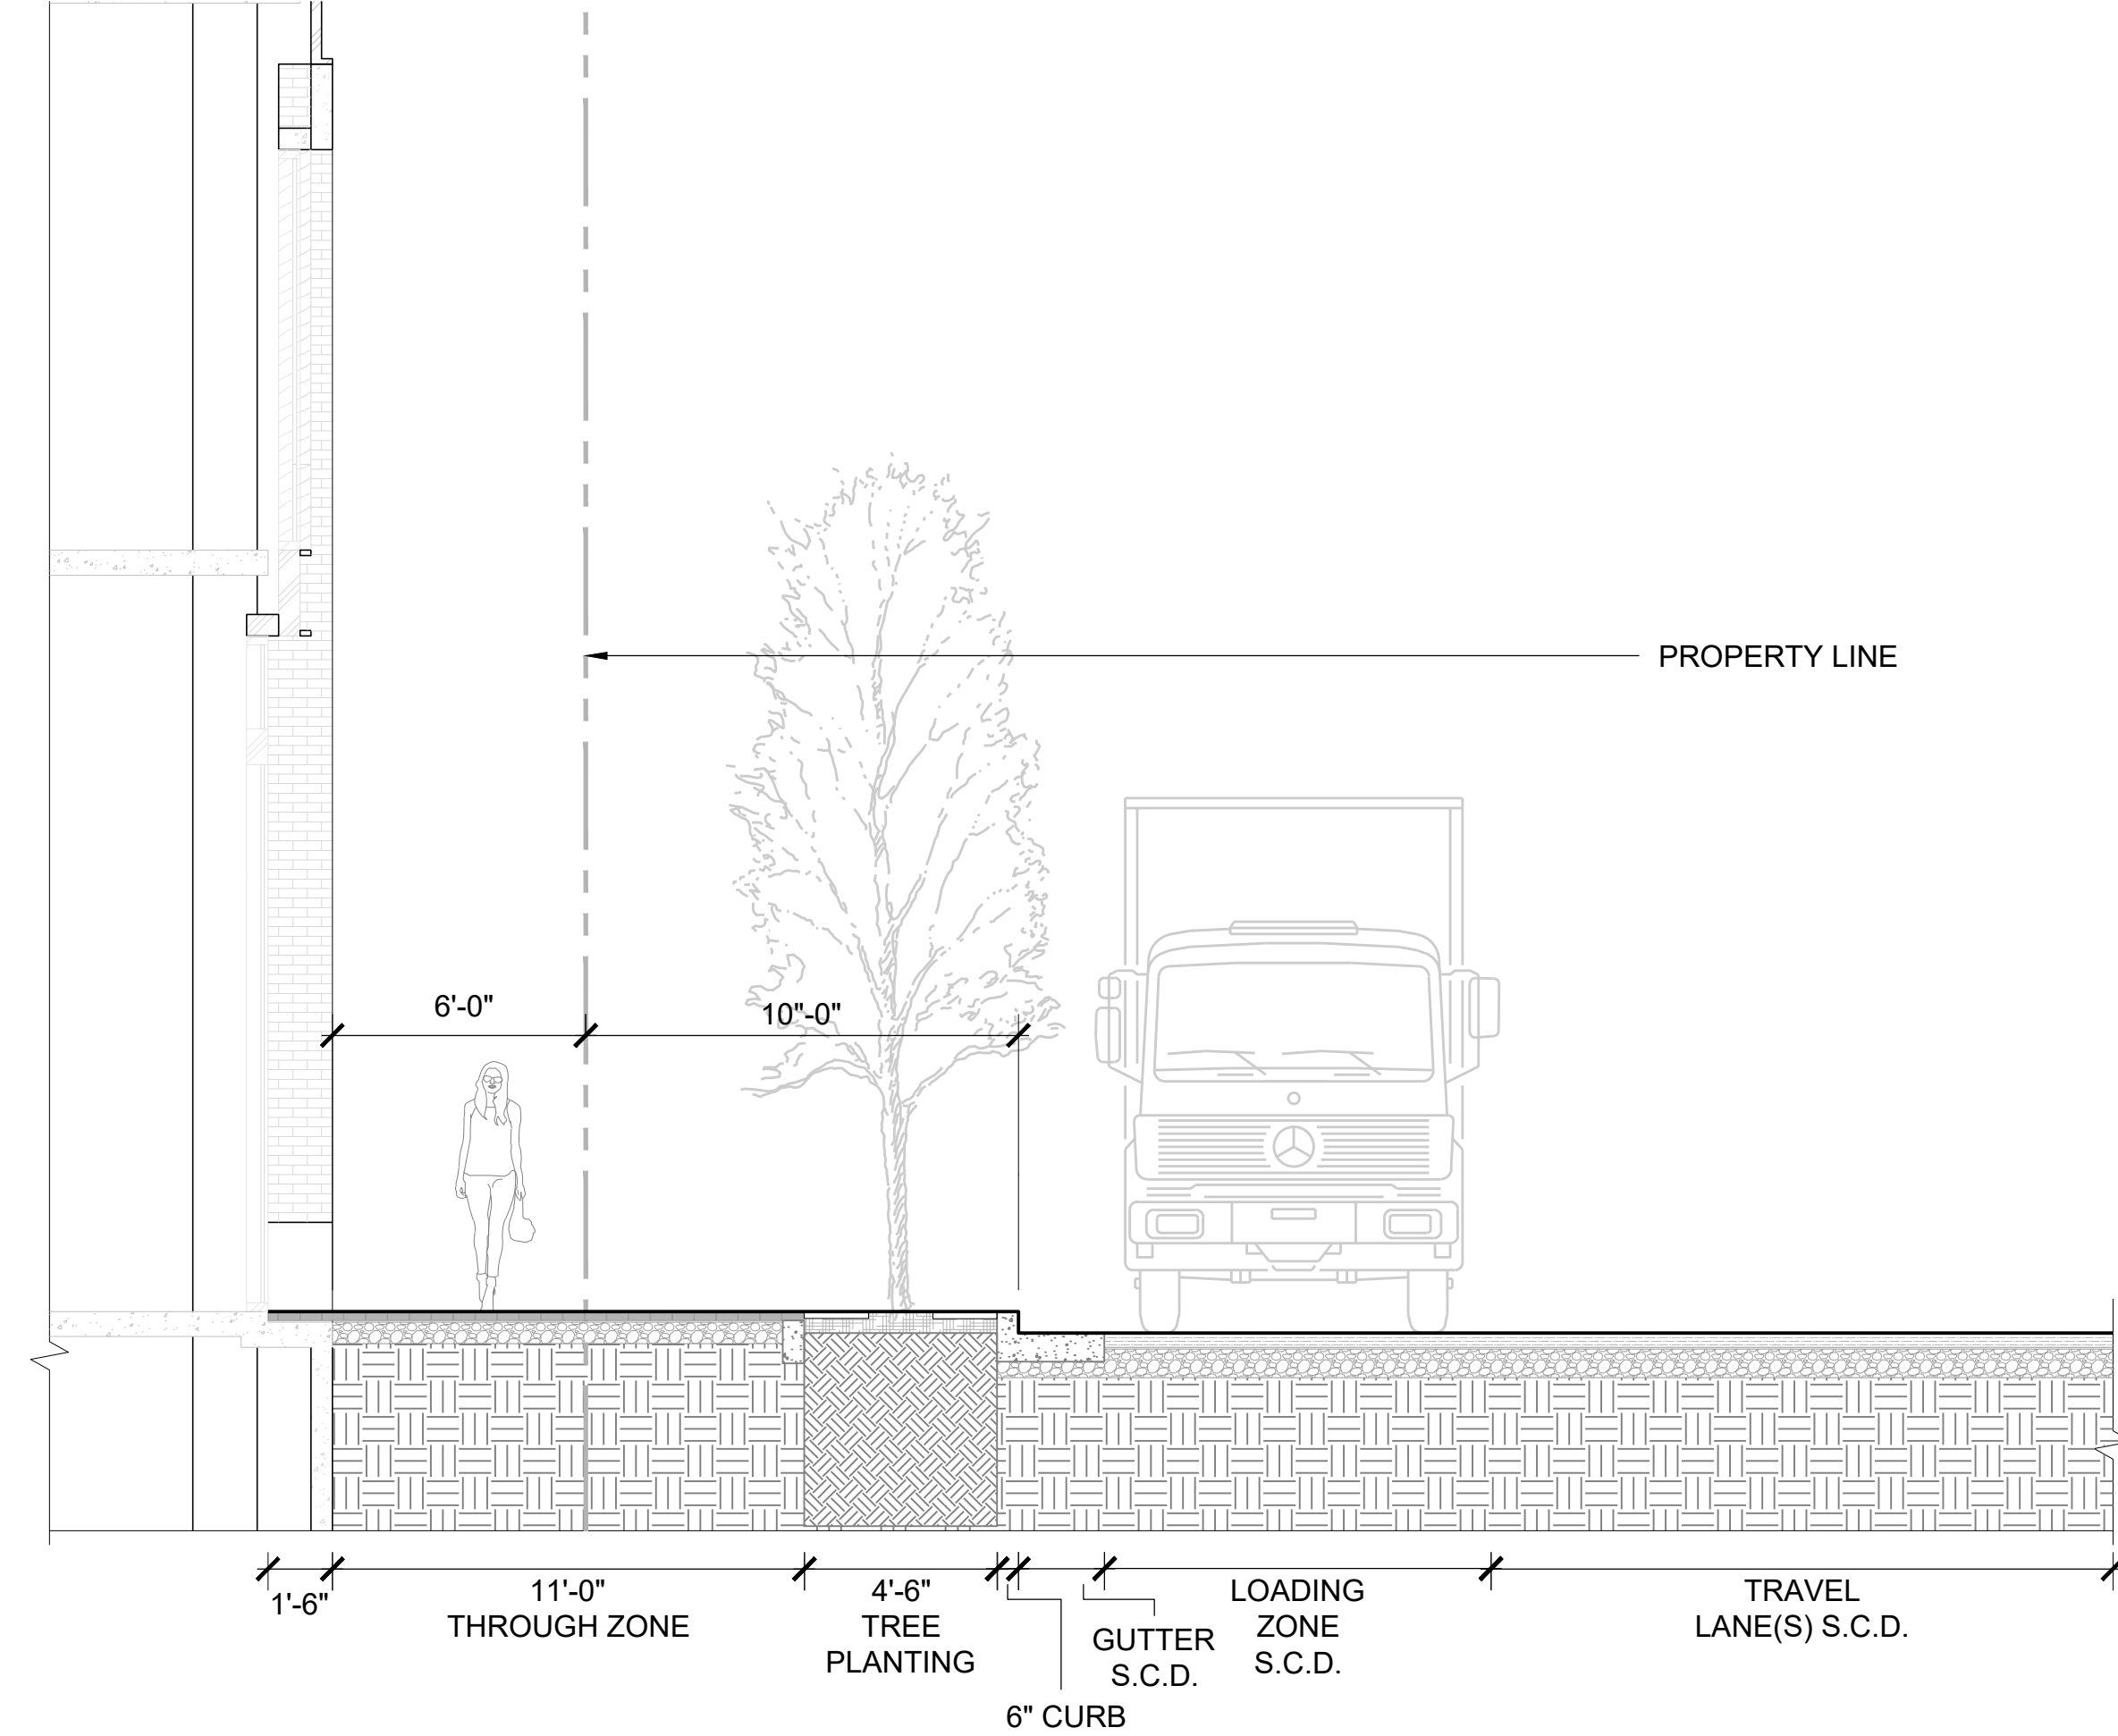

3 E 4TH AVENUE
SCALE: 1/4" = 1'-0"
TYPICAL SECTION

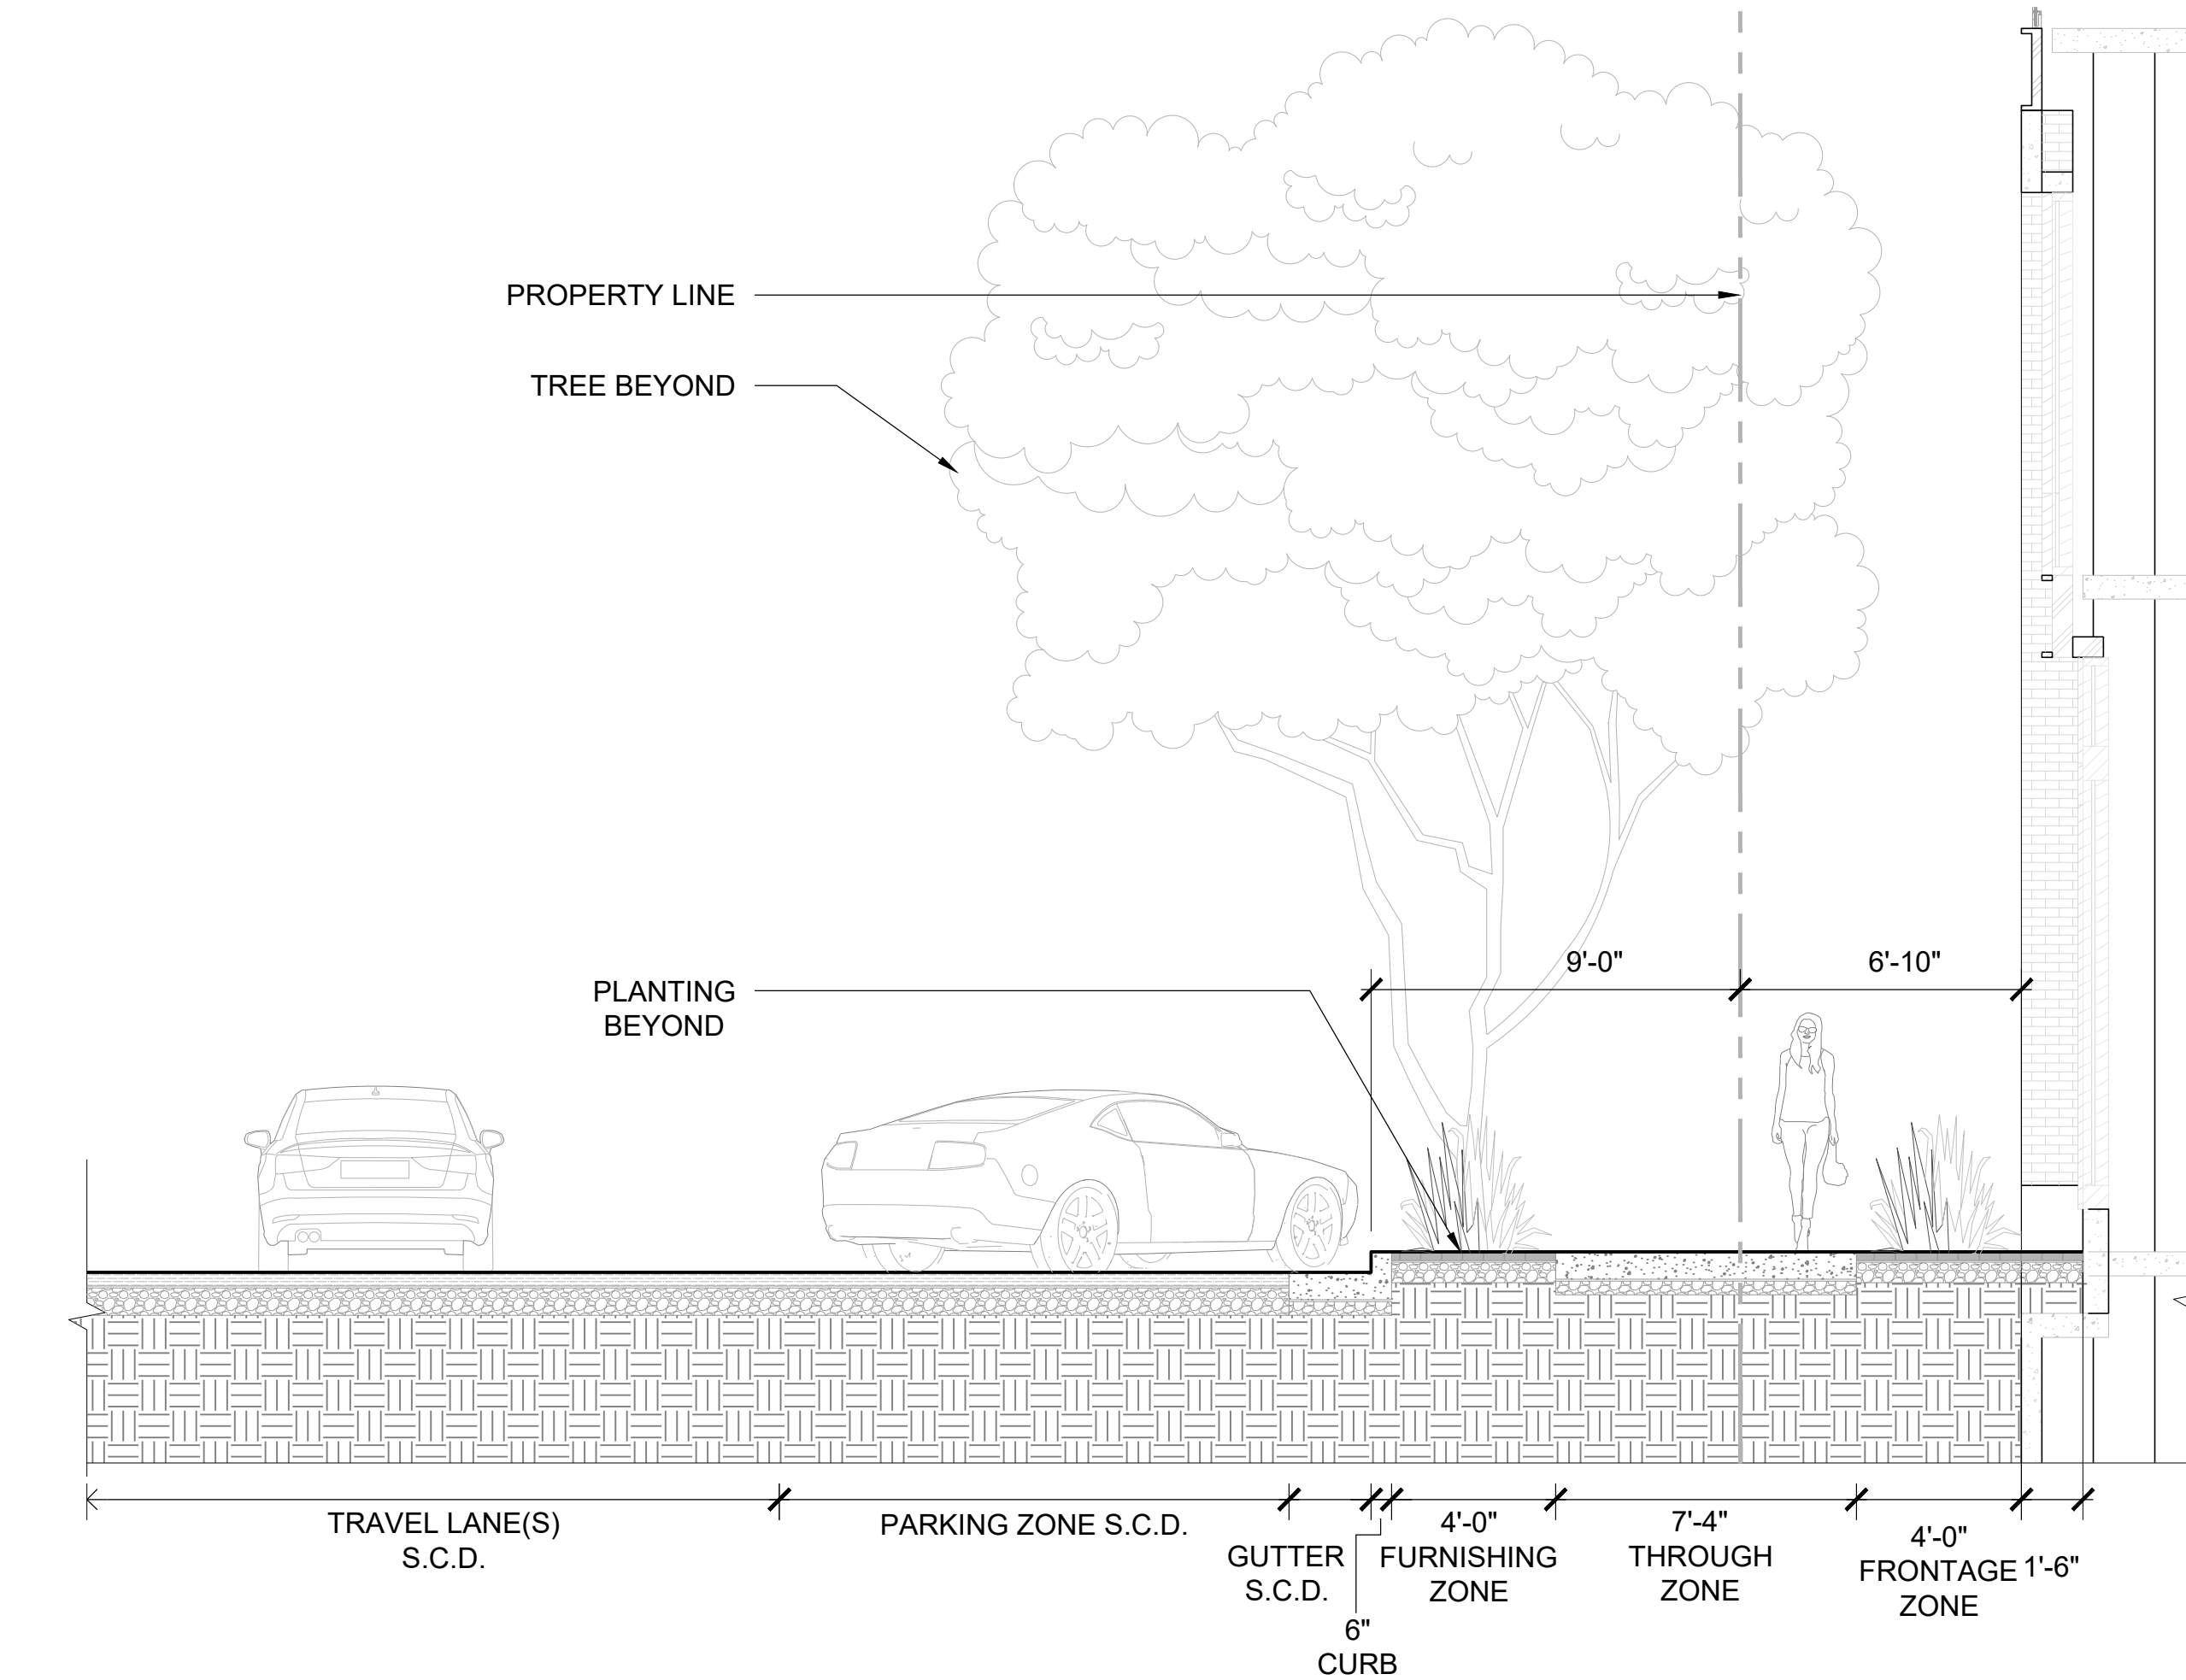

4 E 5TH AVENUE
SCALE: 1/4" = 1'-0"
TYPICAL SECTION



4TH & ELLSWORTH AERIAL

CONCEPTUAL LANDSCAPE SHOWN AT ROOFTOP TERRACES



PARKLET FROM 4TH & ELLSWORTH



ARCHITECTS
KORTH SUNSERI HAGEY



ANDREA COCHRAN
LANDSCAPE ARCHITECTURE
2325 Third Street #210
San Francisco CA 94107
415.503.0060

ISSUES AND REVISIONS

No.	Date	Description
A	05/05/20	Pre-Application Set
B	10/21/20	Pre-Application Resubmittal
C	03/19/21	Pre-Application Resubmittal
D	10/15/21	Pre-Application Resubmittal
E	02/04/22	Pre-Application Resubmittal
F	04/22/22	Pre-Application Resubmittal

PROJECT NUMBER
16010.00

SHEET TITLE
LANDSCAPE RENDERINGS

SCALE
N.A.

SHEET NUMBER



AERIAL OF PARKLET AT 4TH & ELLSWORTH

CONCEPTUAL LANDSCAPE SHOWN AT ROOFTOP TERRACES



PARKLET AT 4TH AND ELLSWORTH FROM ELLSWORTH



ARCHITECTS
KORTH SUNSERI HAGEY



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San Francisco CA 94107
415.503.0060

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F	04/22/22	Pre-Application Resubmittal

PROJECT NUMBER
16010.00

SHEET TITLE
LANDSCAPE RENDERINGS

SCALE
N.A.

SHEET NUMBER



ELLSWORTH STREETScape AND BUILDING ENTRY



STREETSCAPE AND ENTRY AT 4TH & B STREET



ARCHITECTS
KORTH SUNSERI HAGEY



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LANDSCAPE ARCHITECTURE
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San Francisco CA 94107
415.503.0060

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F	04/22/22	Pre-Application Resubmittal

PROJECT NUMBER
16010.00

SHEET TITLE
LANDSCAPE RENDERINGS

SCALE
N.A.

SHEET NUMBER



4TH AVE & B STREET AERIAL



B STREET STREETSCAPE & 5TH AVE



ARCHITECTS
KORTH SUNSERI HAGEY



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415.503.0060

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PROJECT NUMBER
16010.00

SHEET TITLE
LANDSCAPE RENDERINGS

SCALE
N.A.

SHEET NUMBER



ARCHITECTS
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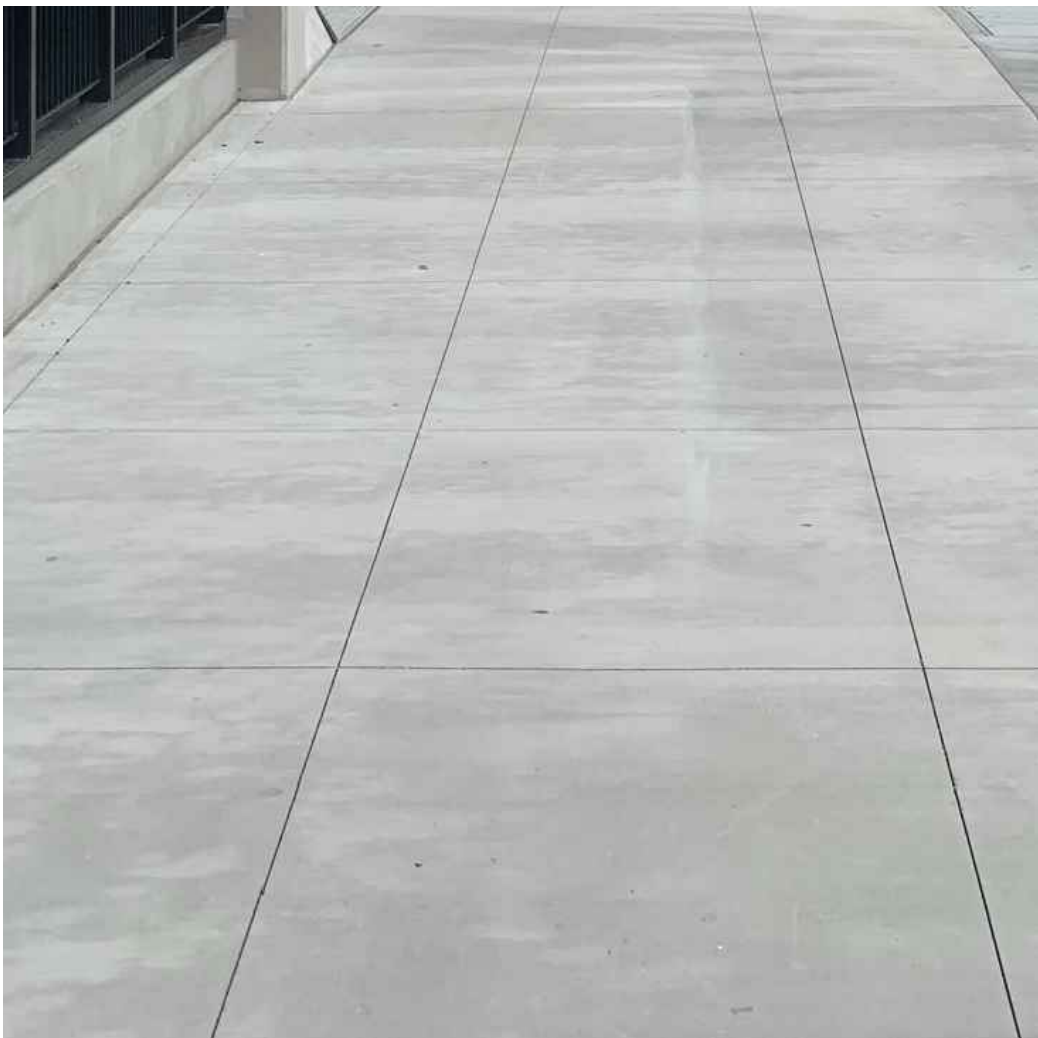
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SHEET TITLE
LANDSCAPE MATERIALS AND
FURNISHING IMAGERY

SCALE
N.A.

SHEET NUMBER


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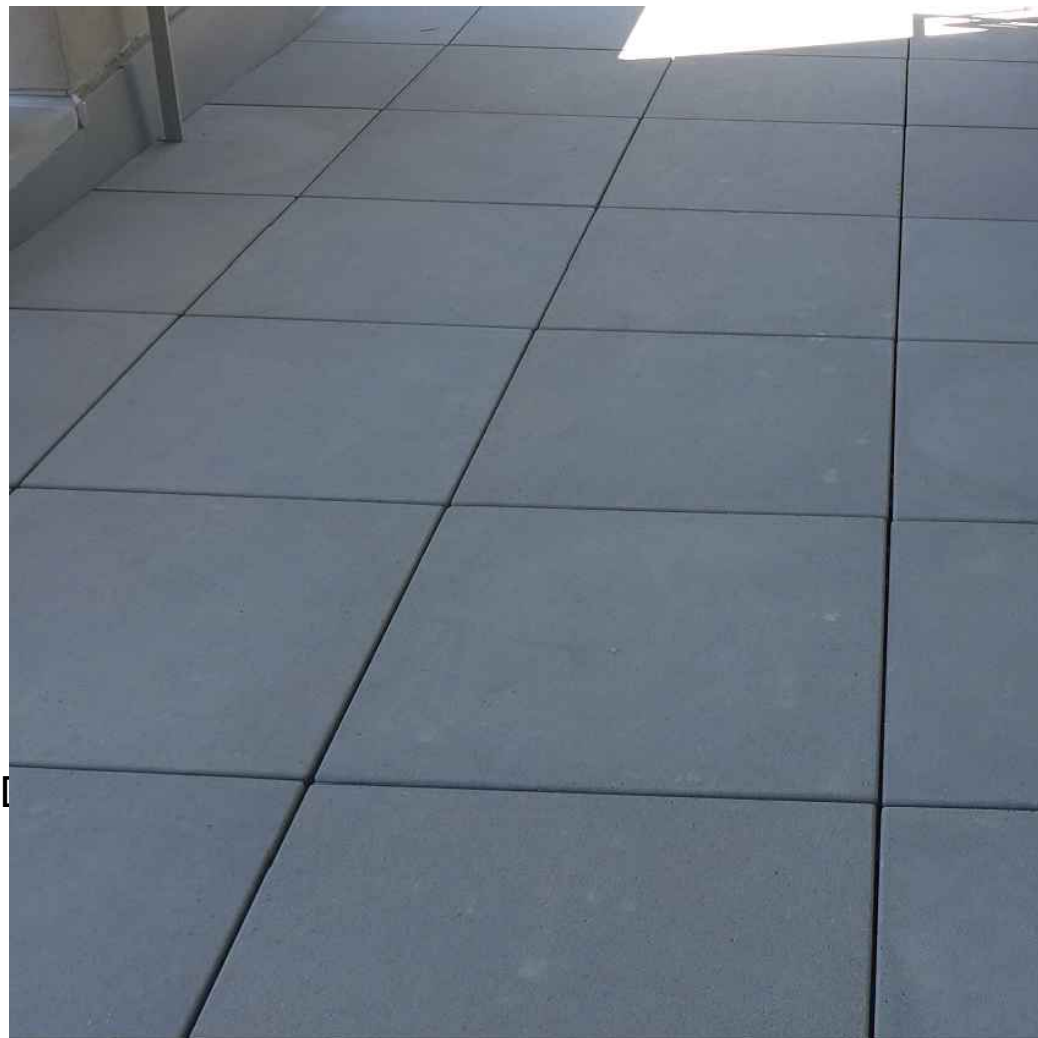
CONCRETE PAVING



UNIT PAVING TYPE I & II




PEDESTAL PAVING TYPE I & II

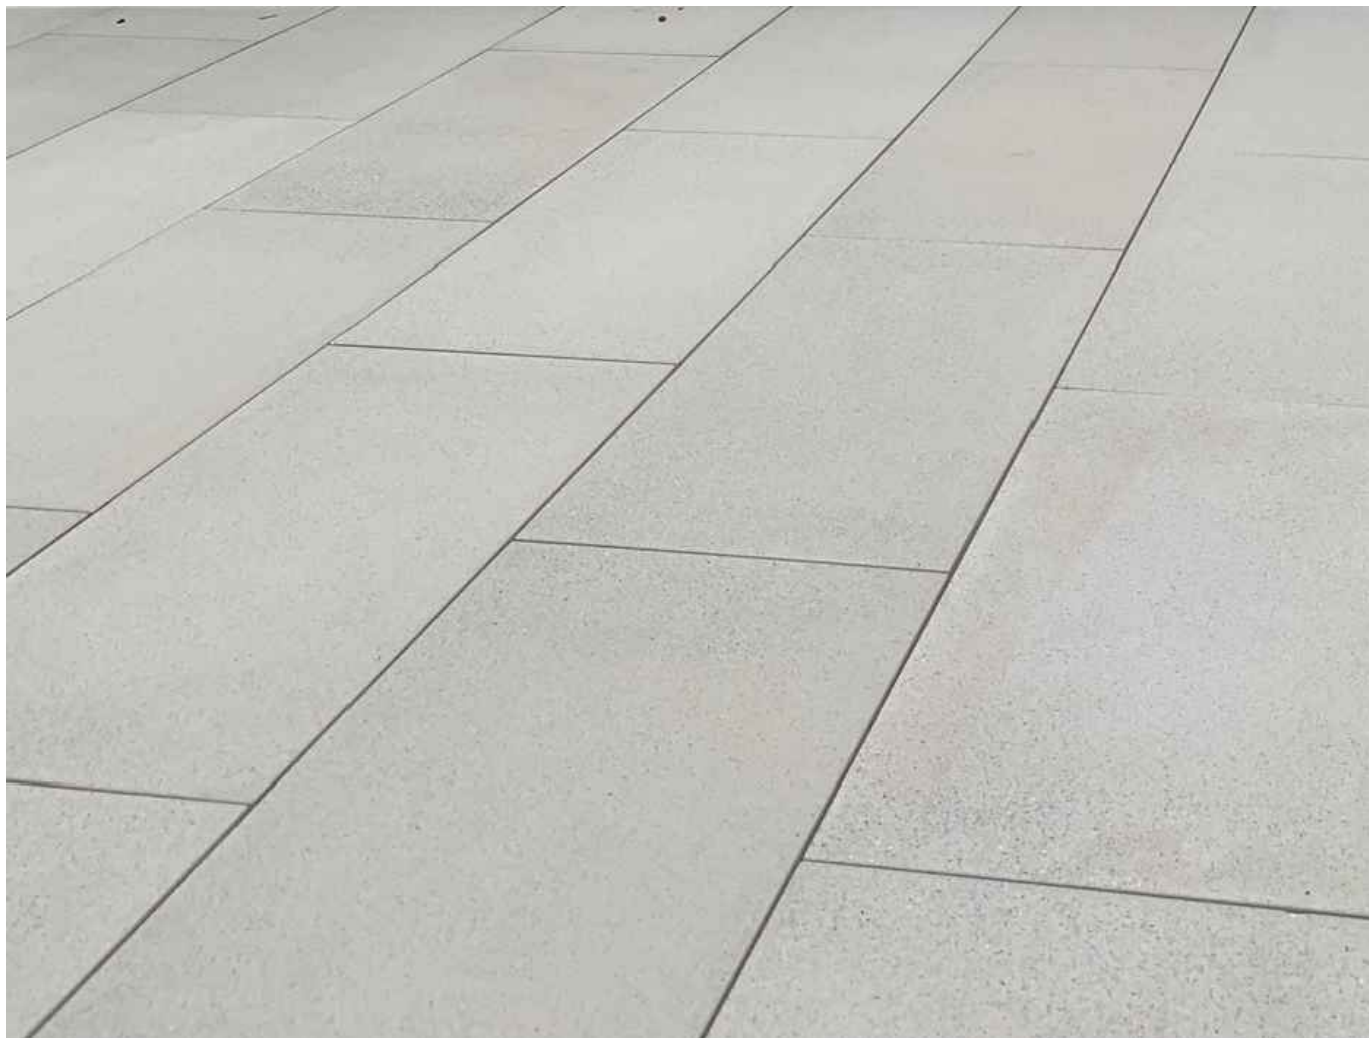

PEDESTAL PAVING TYPE III




PRECAST PAVER COLORS

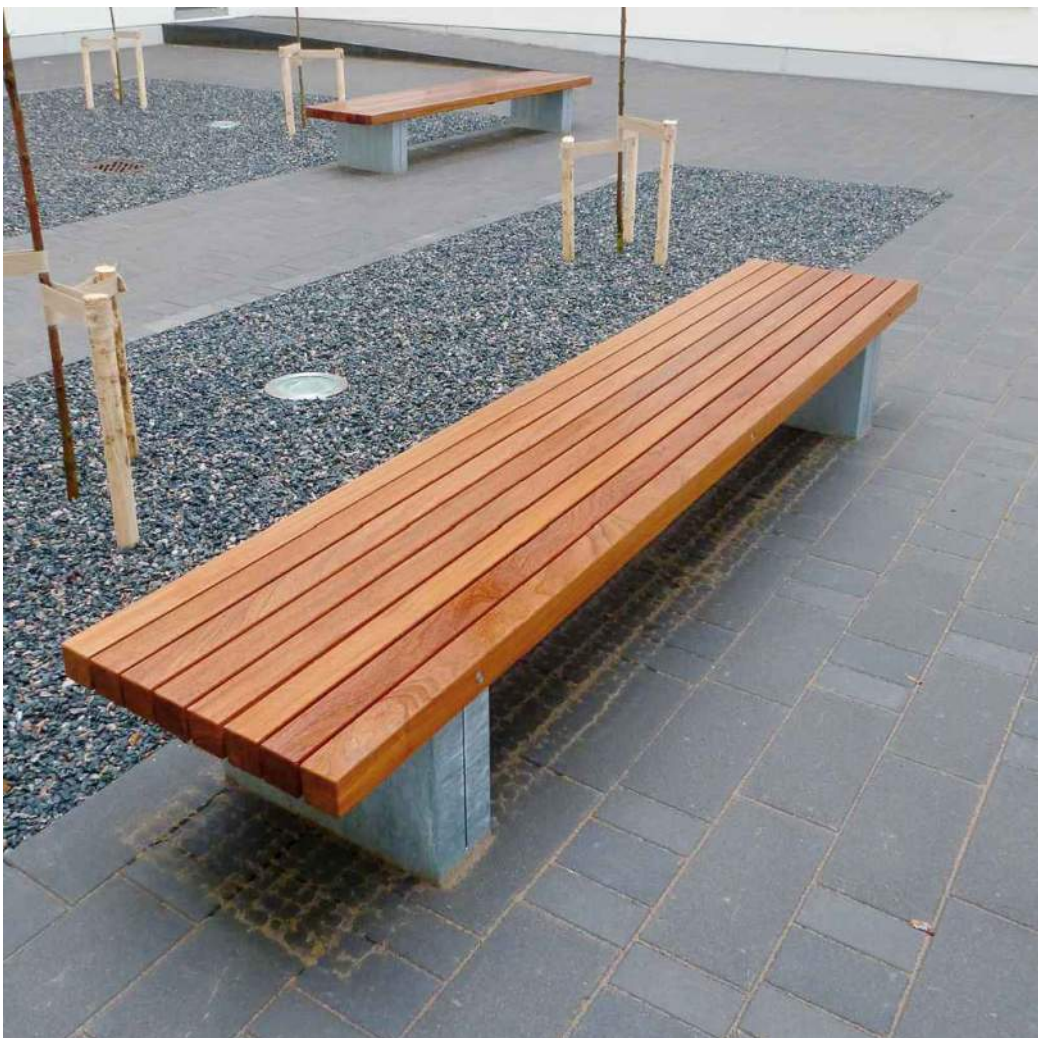

BENCH TYPE I & II



BENCH TYPE III

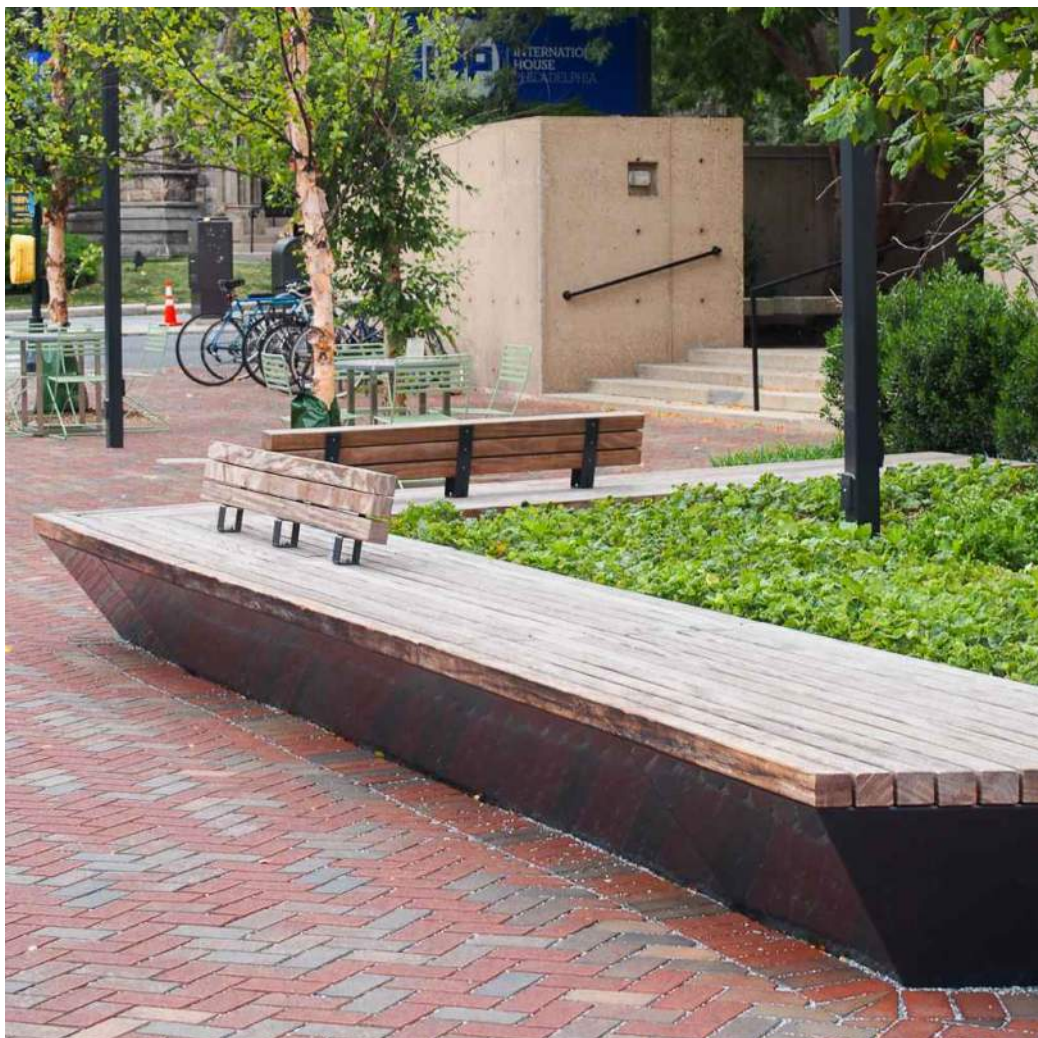

RAISED METAL PLANTER & BENCH TYPE IV



WOOD DINING TABLE



BENCH TYPE V



BIKE RACK AT UNIT PAVING



PEDESTAL PAVING TYPE IV



ARCHITECTS
KORTH SUNSERI HAGEY

AC
LA
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ISSUES AND REVISIONS

No.	Date	Description
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E	02/04/22	Pre-Application Resubmittal
F	04/22/22	Pre-Application Resubmittal
G	06/15/22	Pre-Application Resubmittal


PROJECT NUMBER
16010.00

SHEET TITLE
SITE FURNISHING DETAILS



SCALE
AS NOTED

SHEET NUMBER



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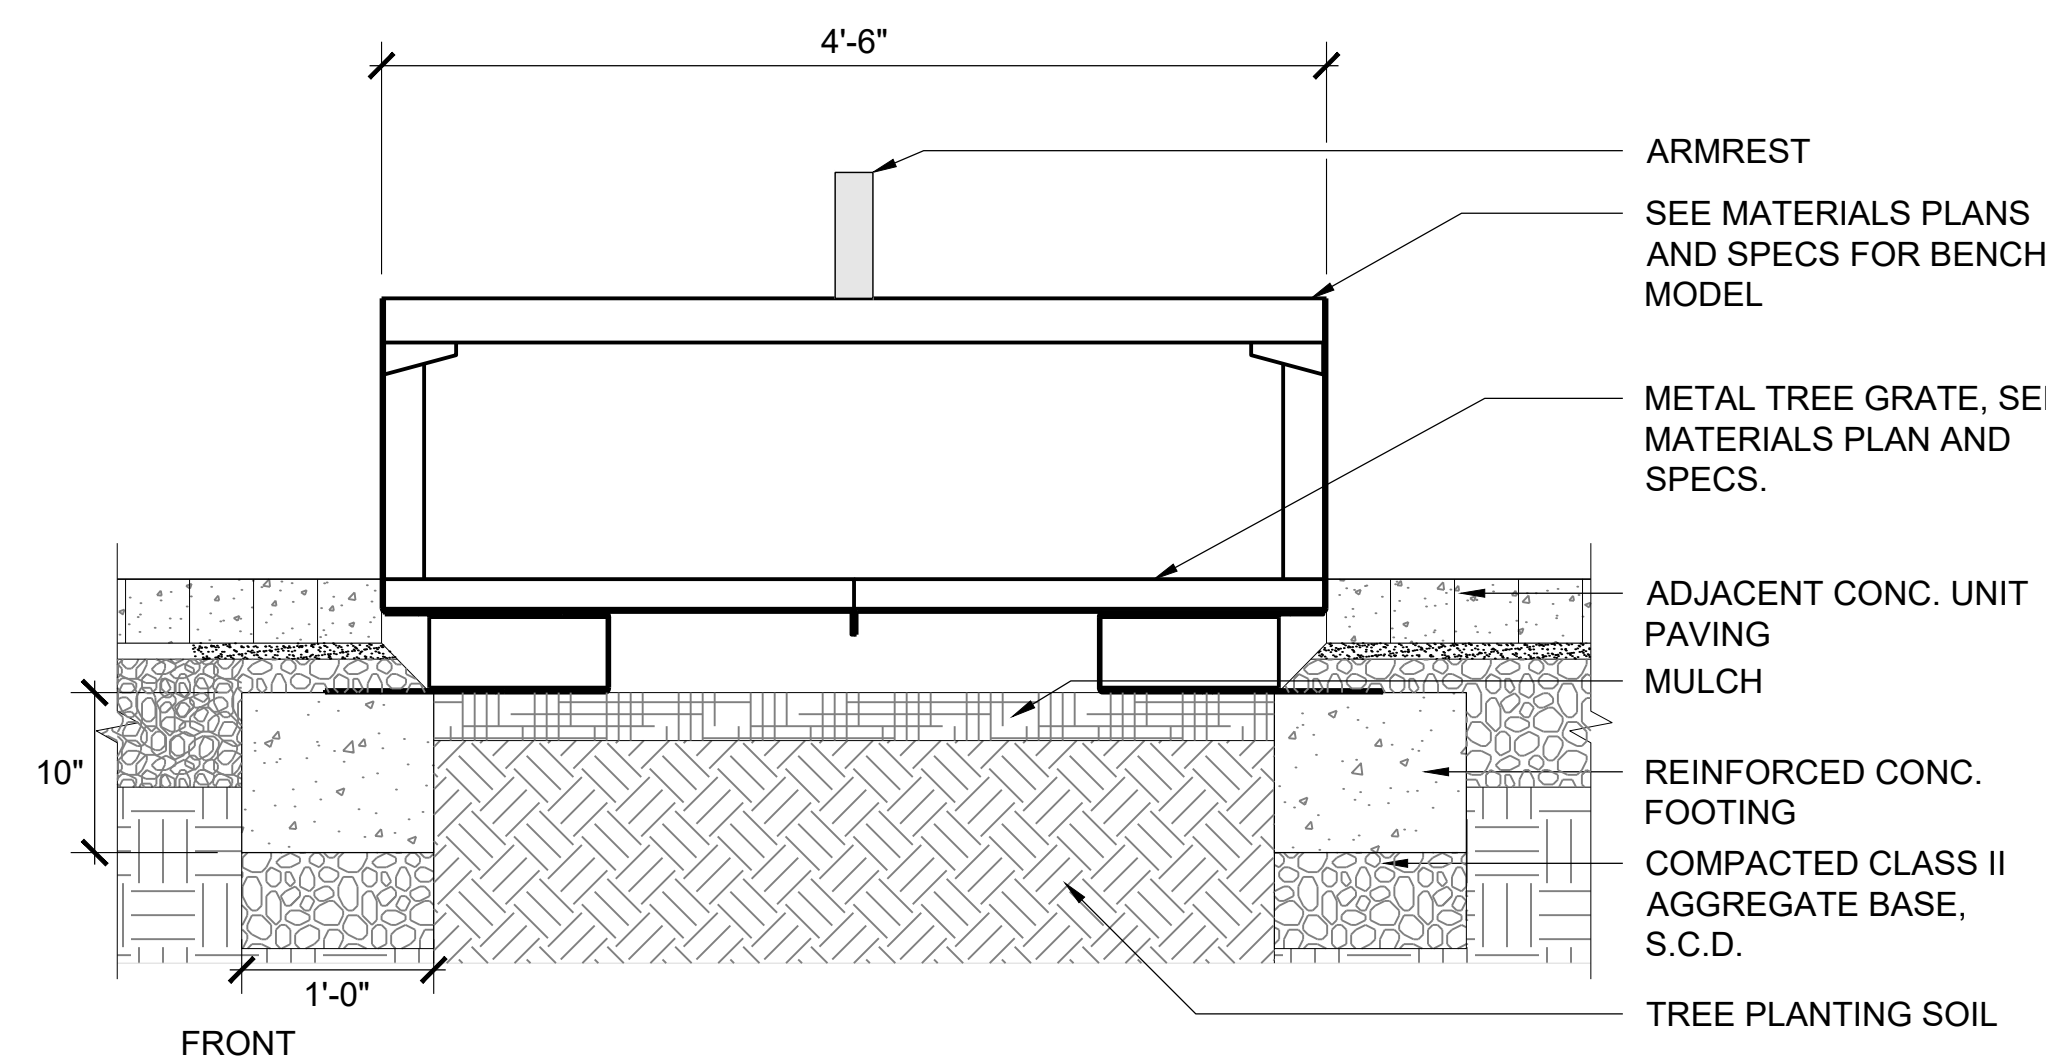
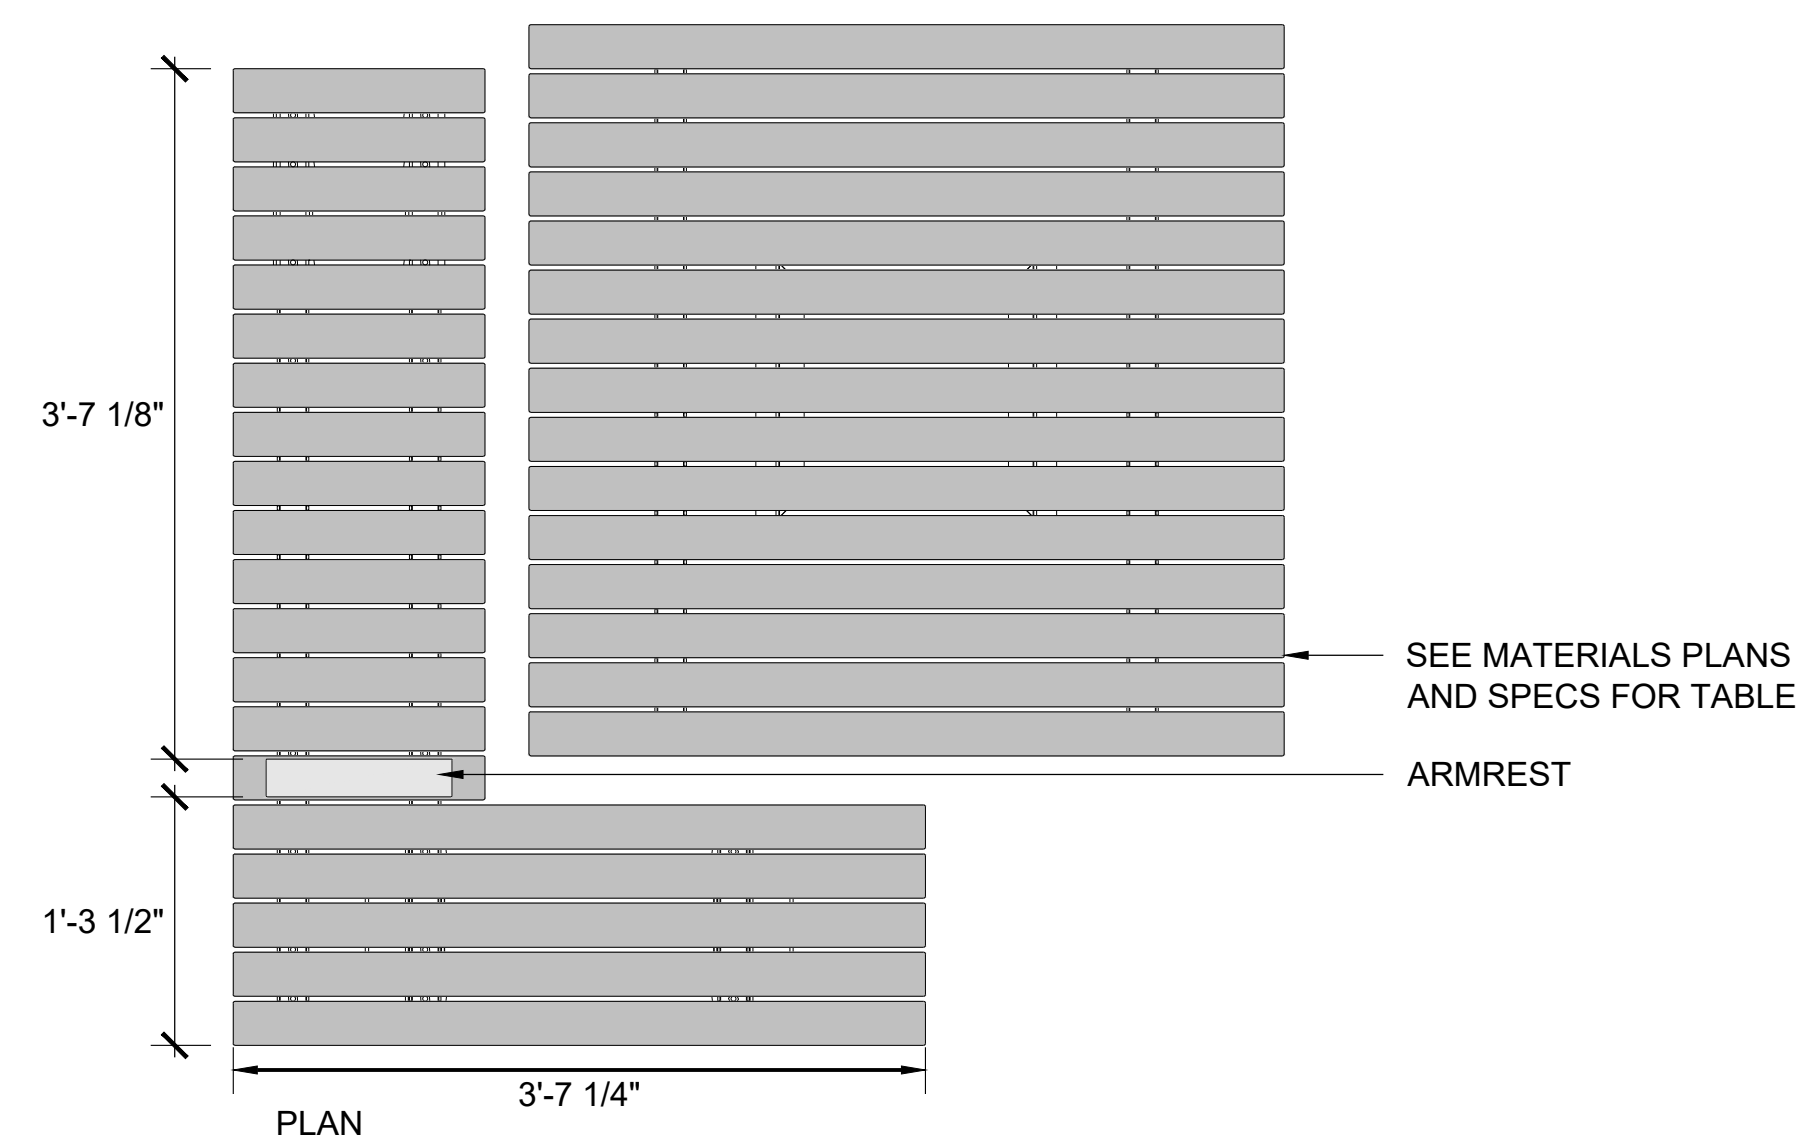
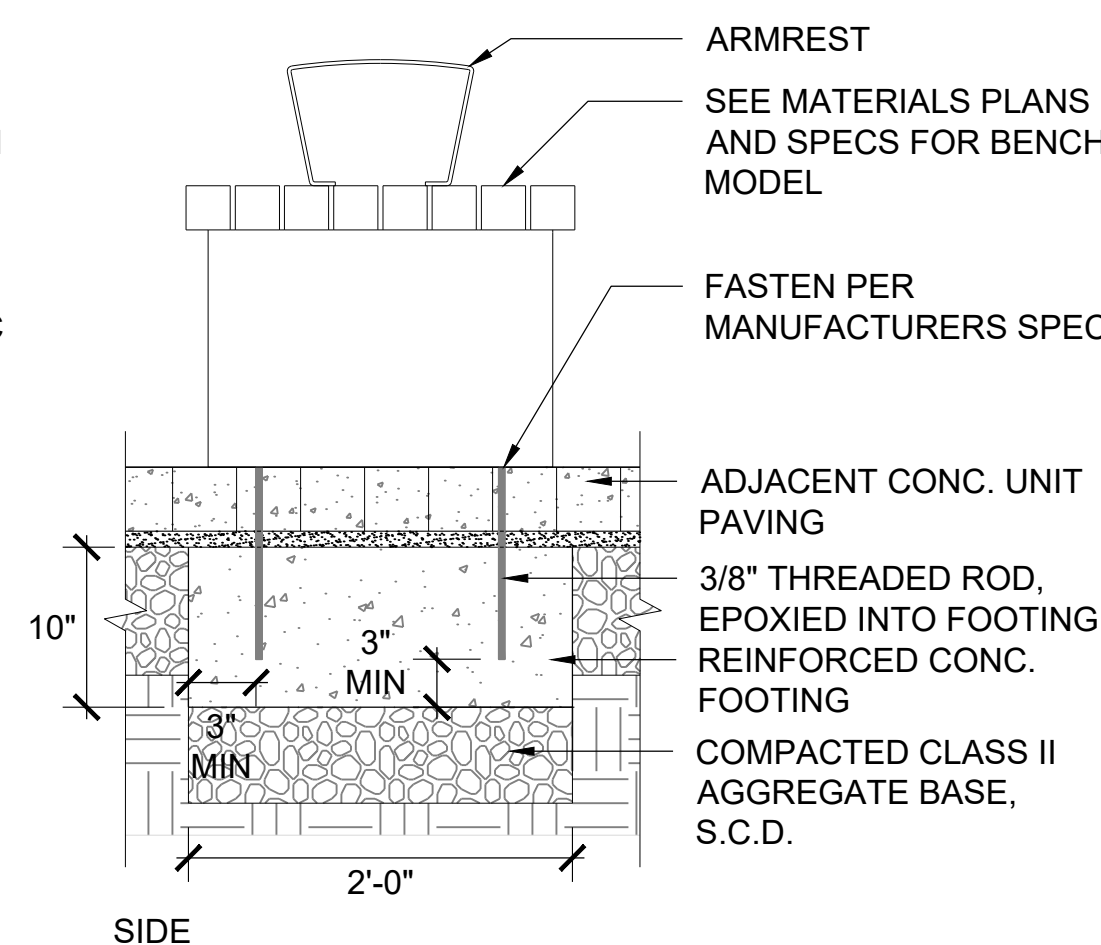
1 WOOD BENCH TYPE I
SCALE: 1"=1'-0"
TYPICAL SECTION

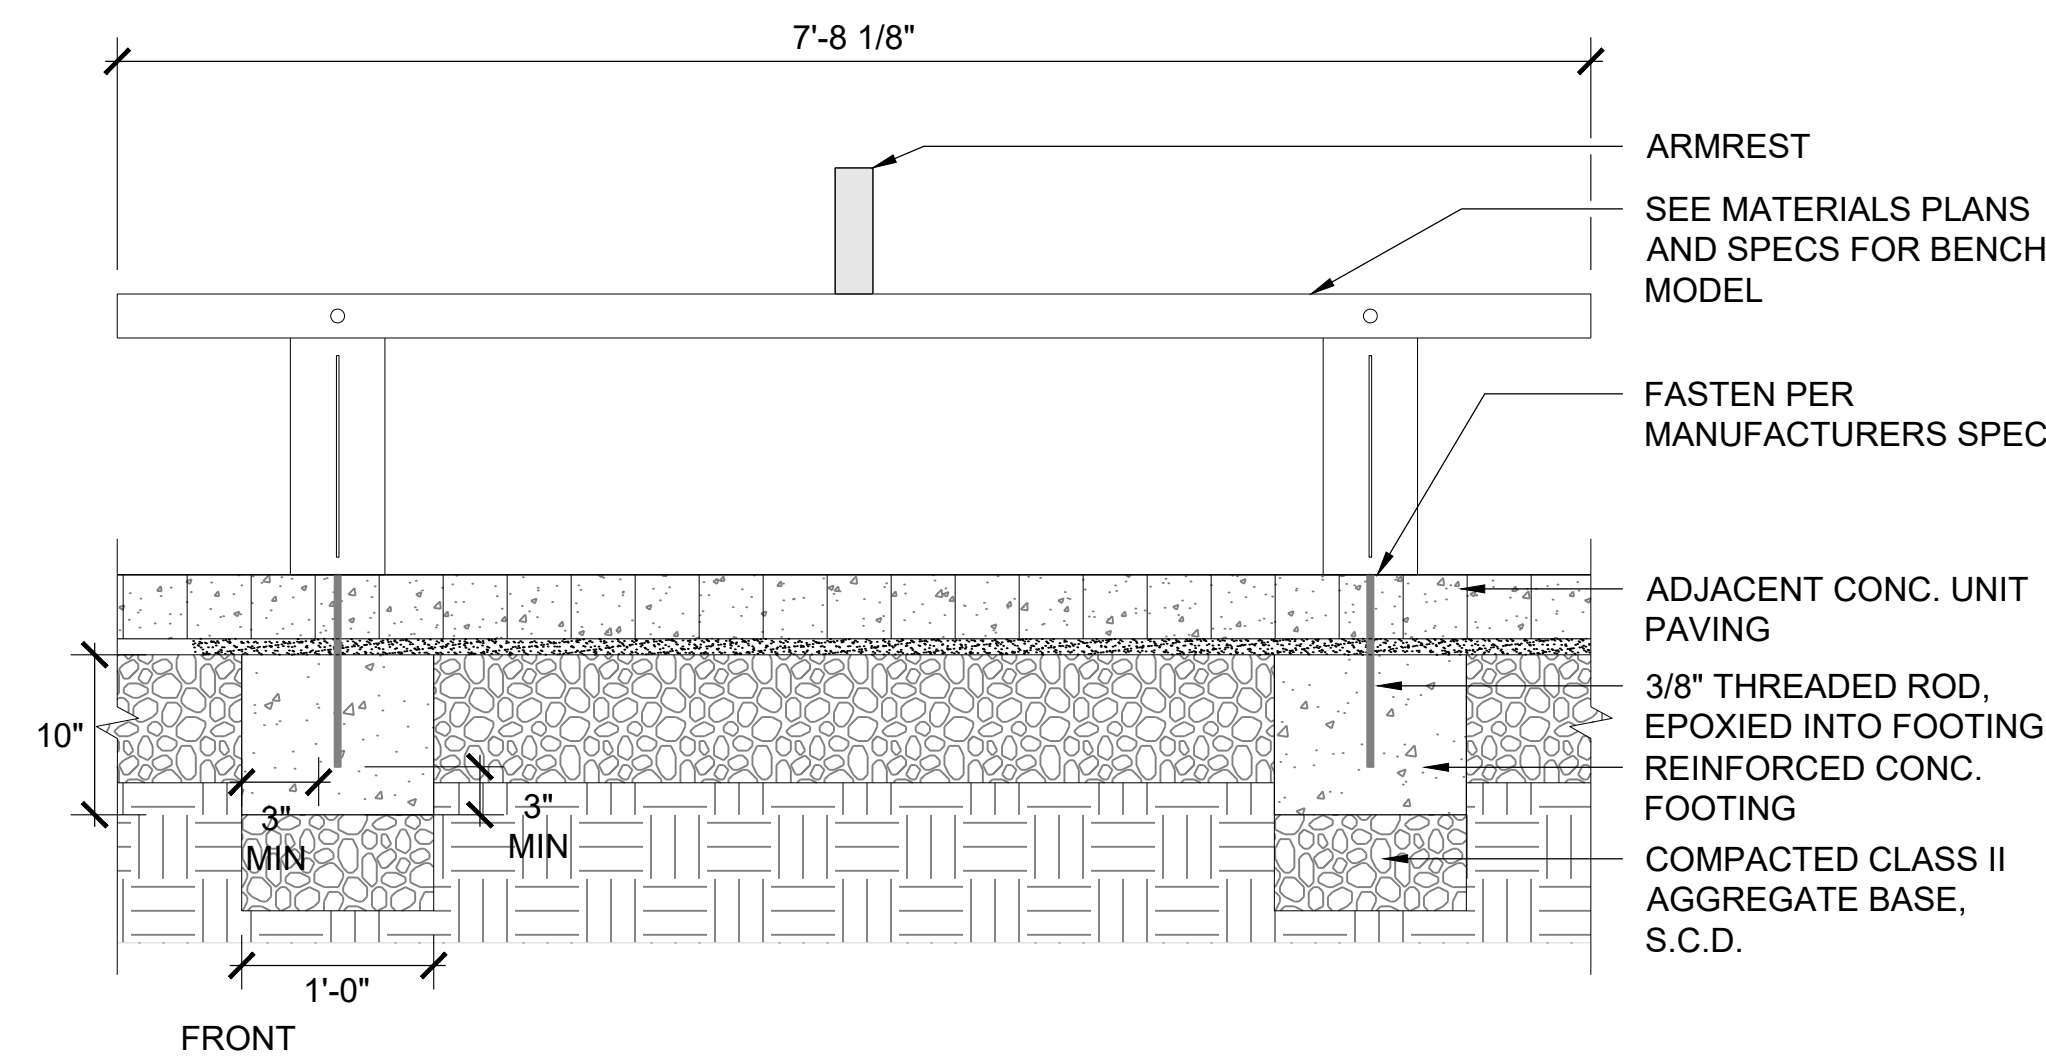


2 WOOD BENCH TYPE III
SCALE: 1"=1'-0"
TYPICAL SECTION

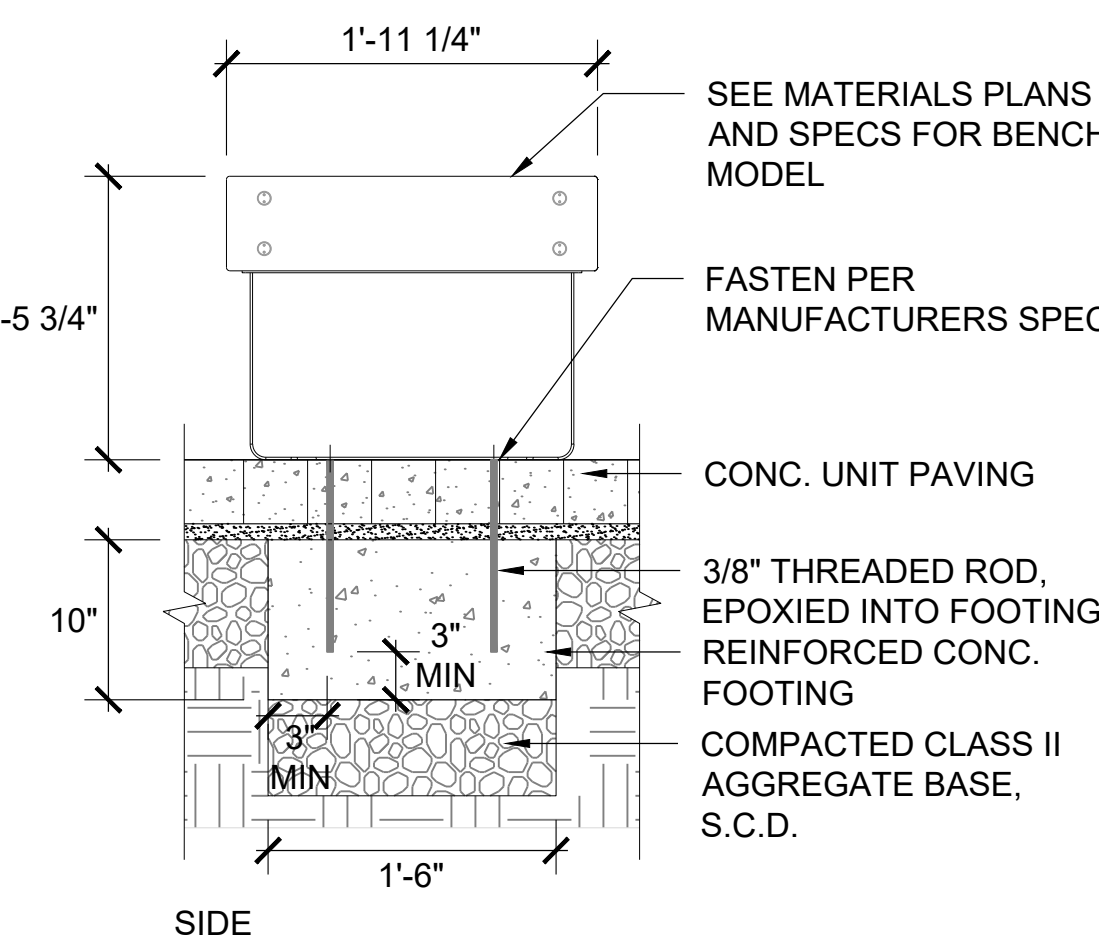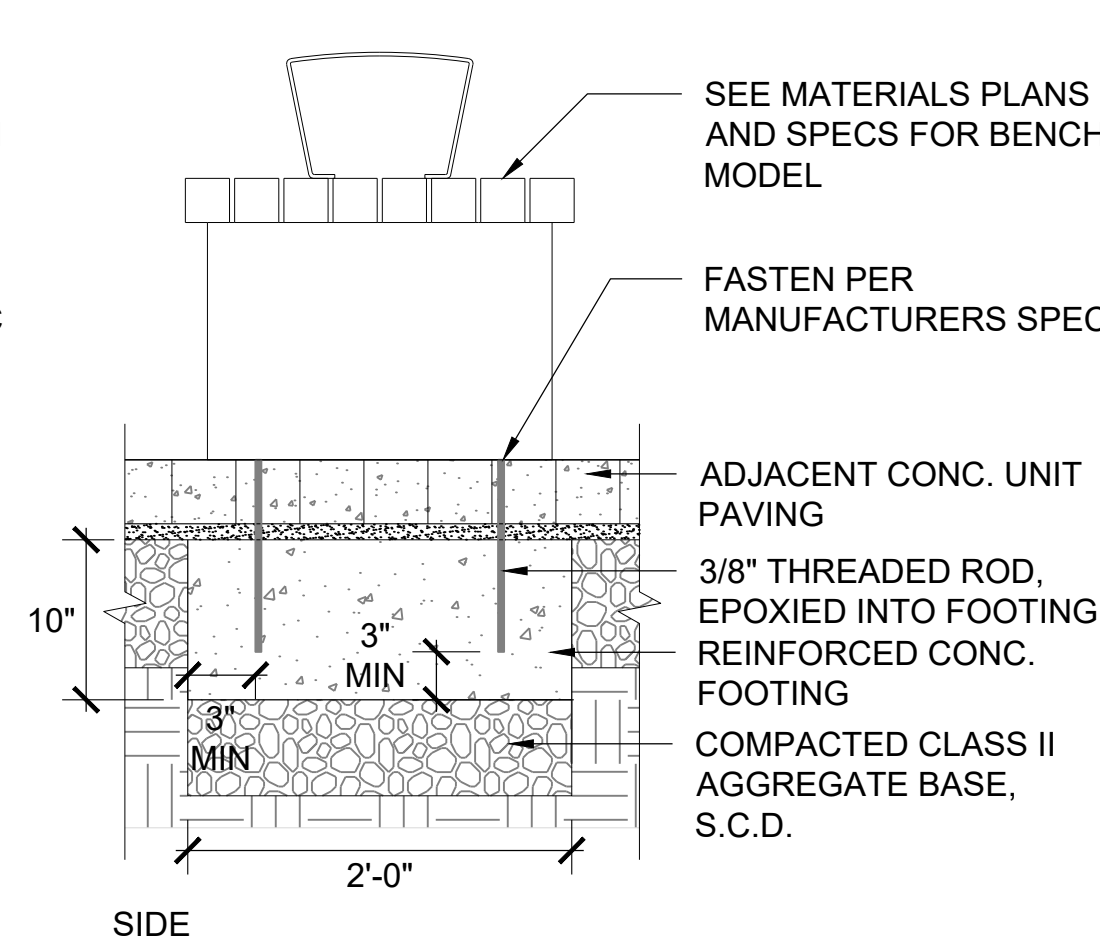

3 WOOD BENCH TYPE II
SCALE: 1"=1'-0"
TYPICAL SECTION

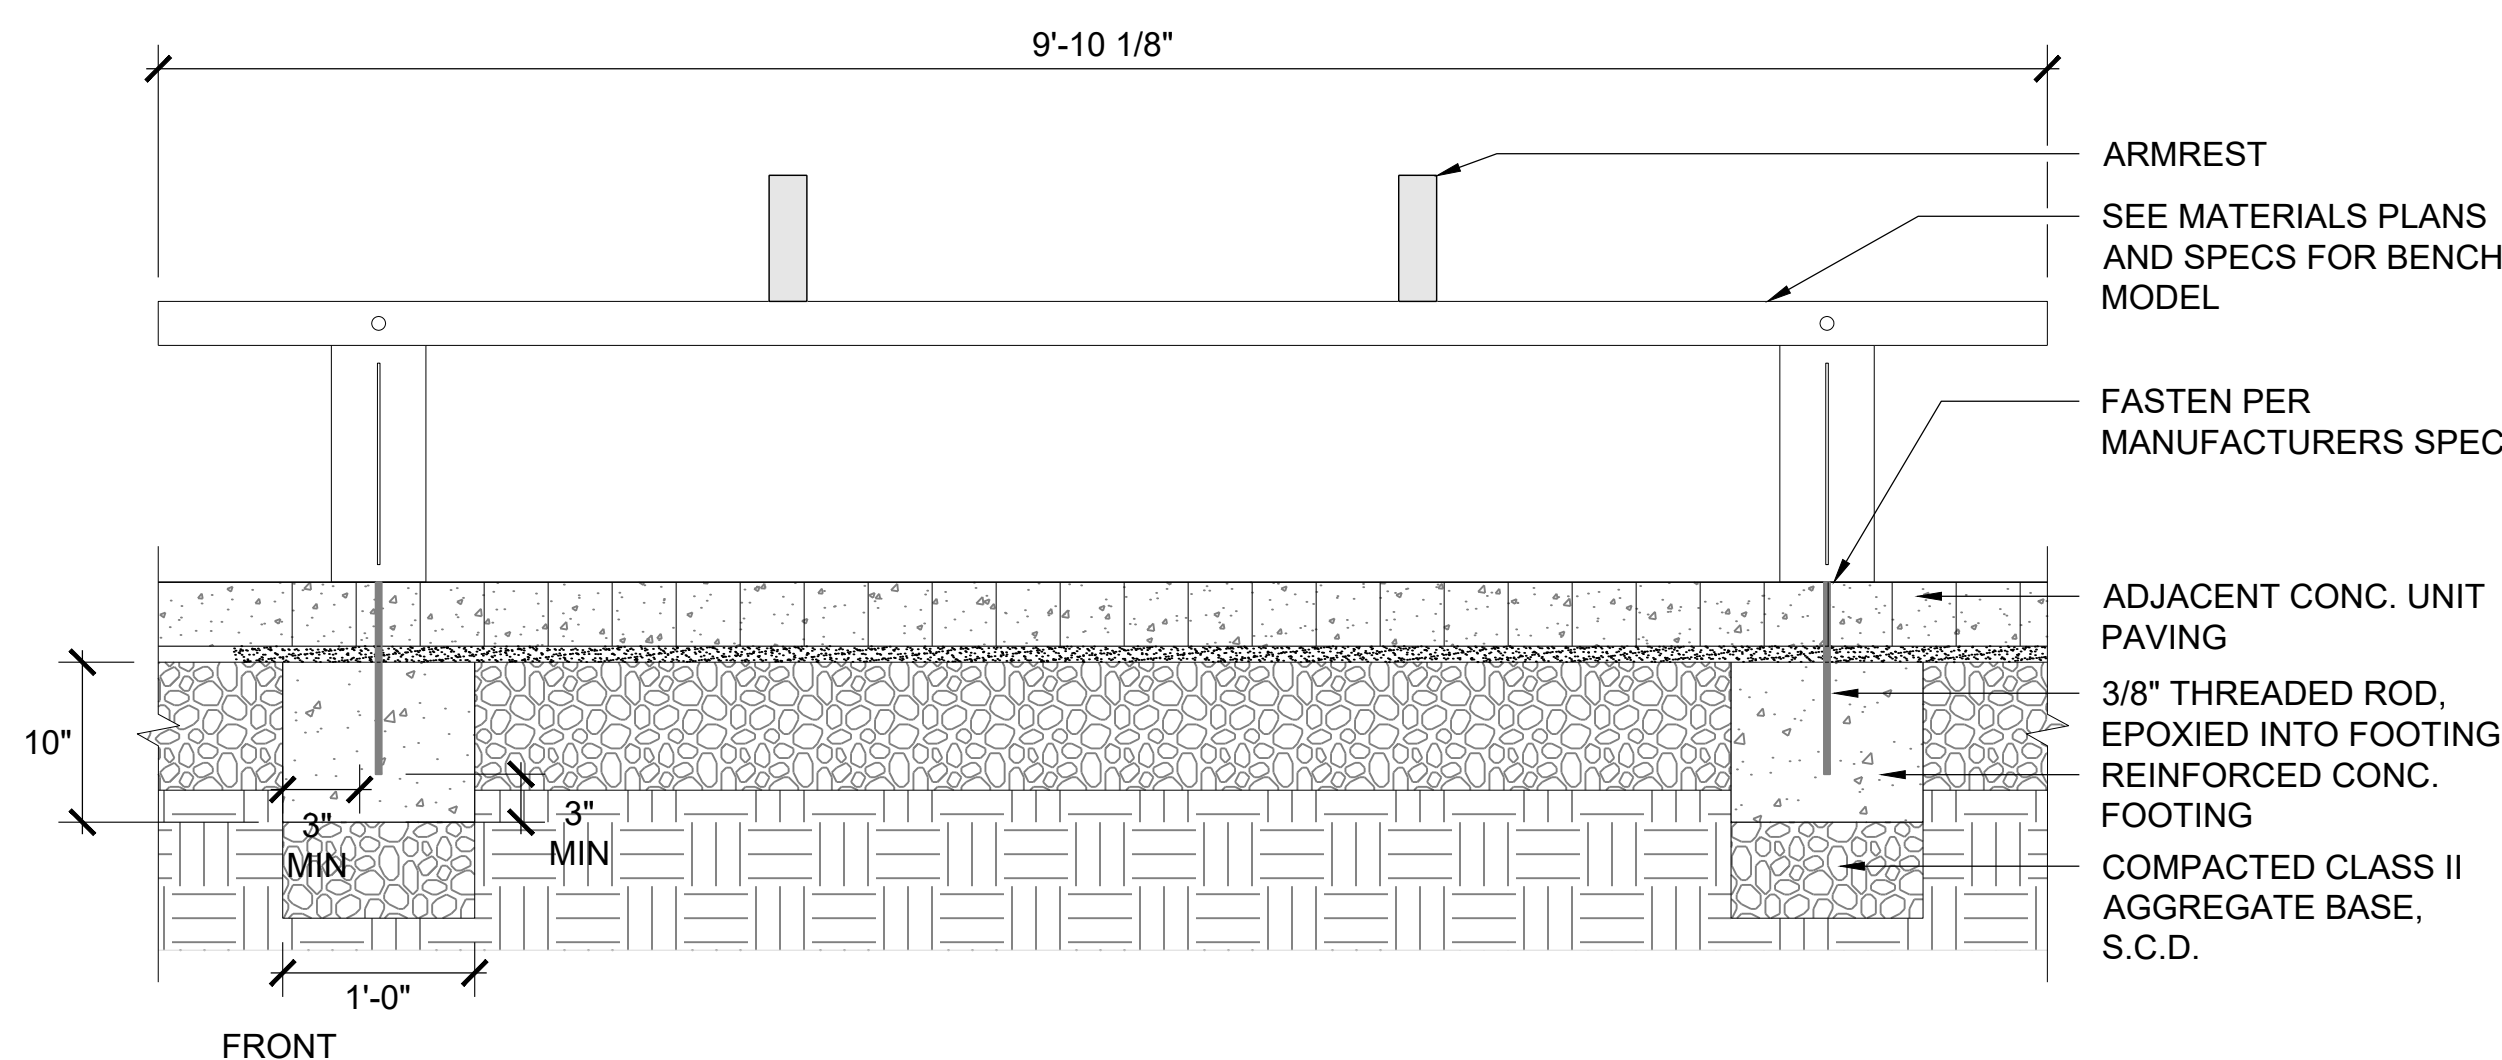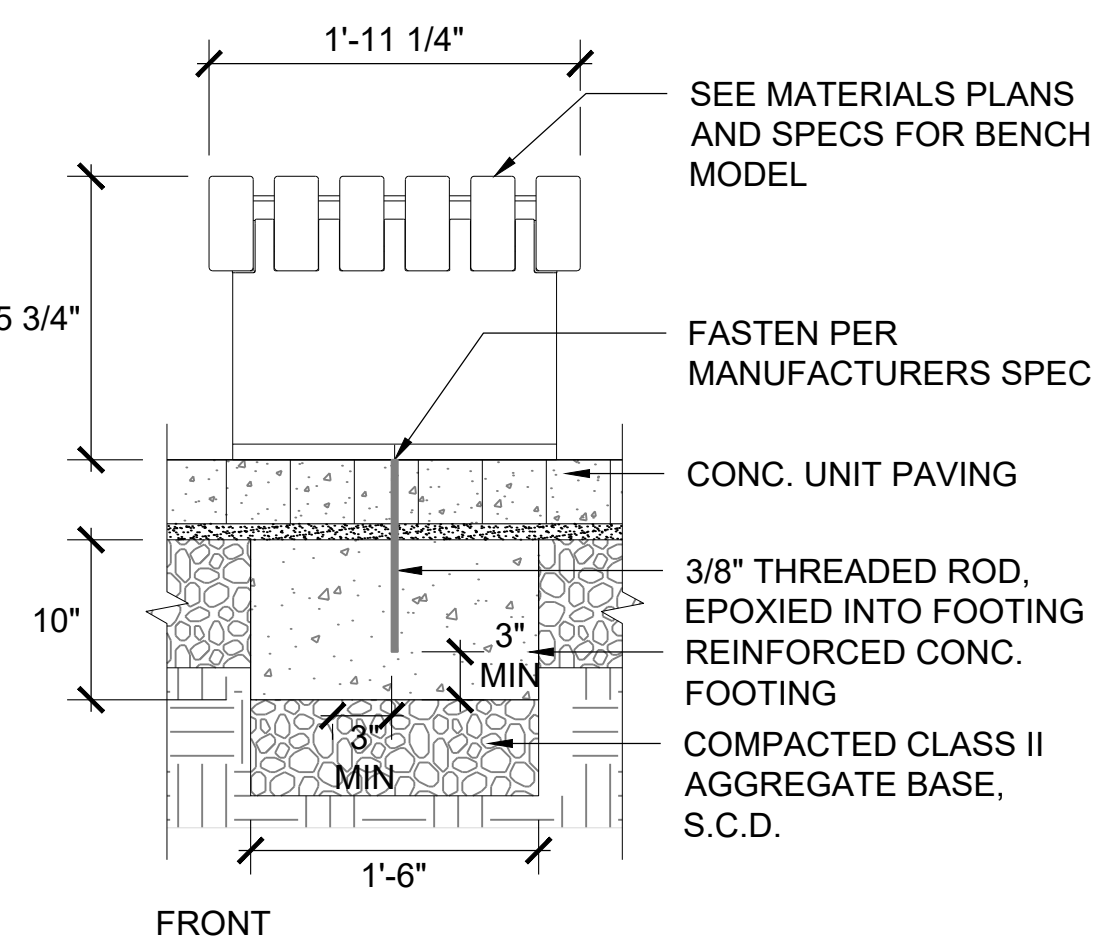


4 WOOD BENCH TYPE V
SCALE: 1"=1'-0"
TYPICAL SECTION

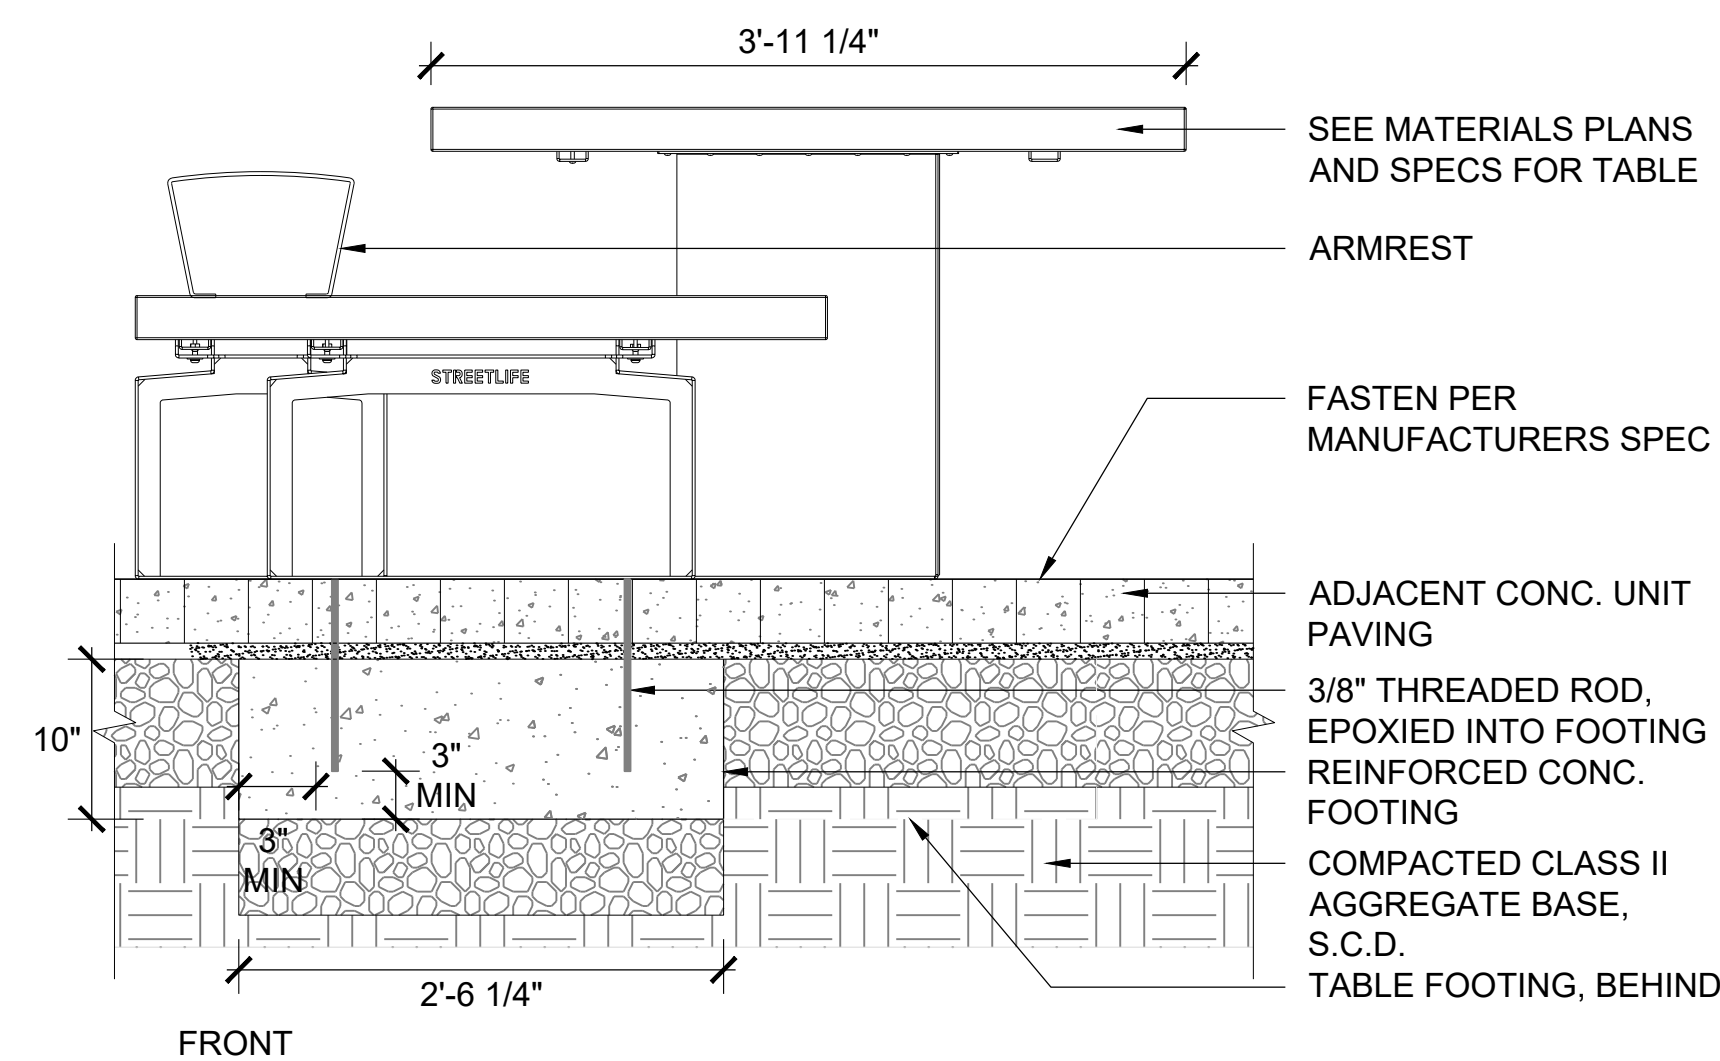

5 PICNIC TABLE AND BENCH
SCALE: 1"=1'-0"
TYPICAL SECTION

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CONSULTANT

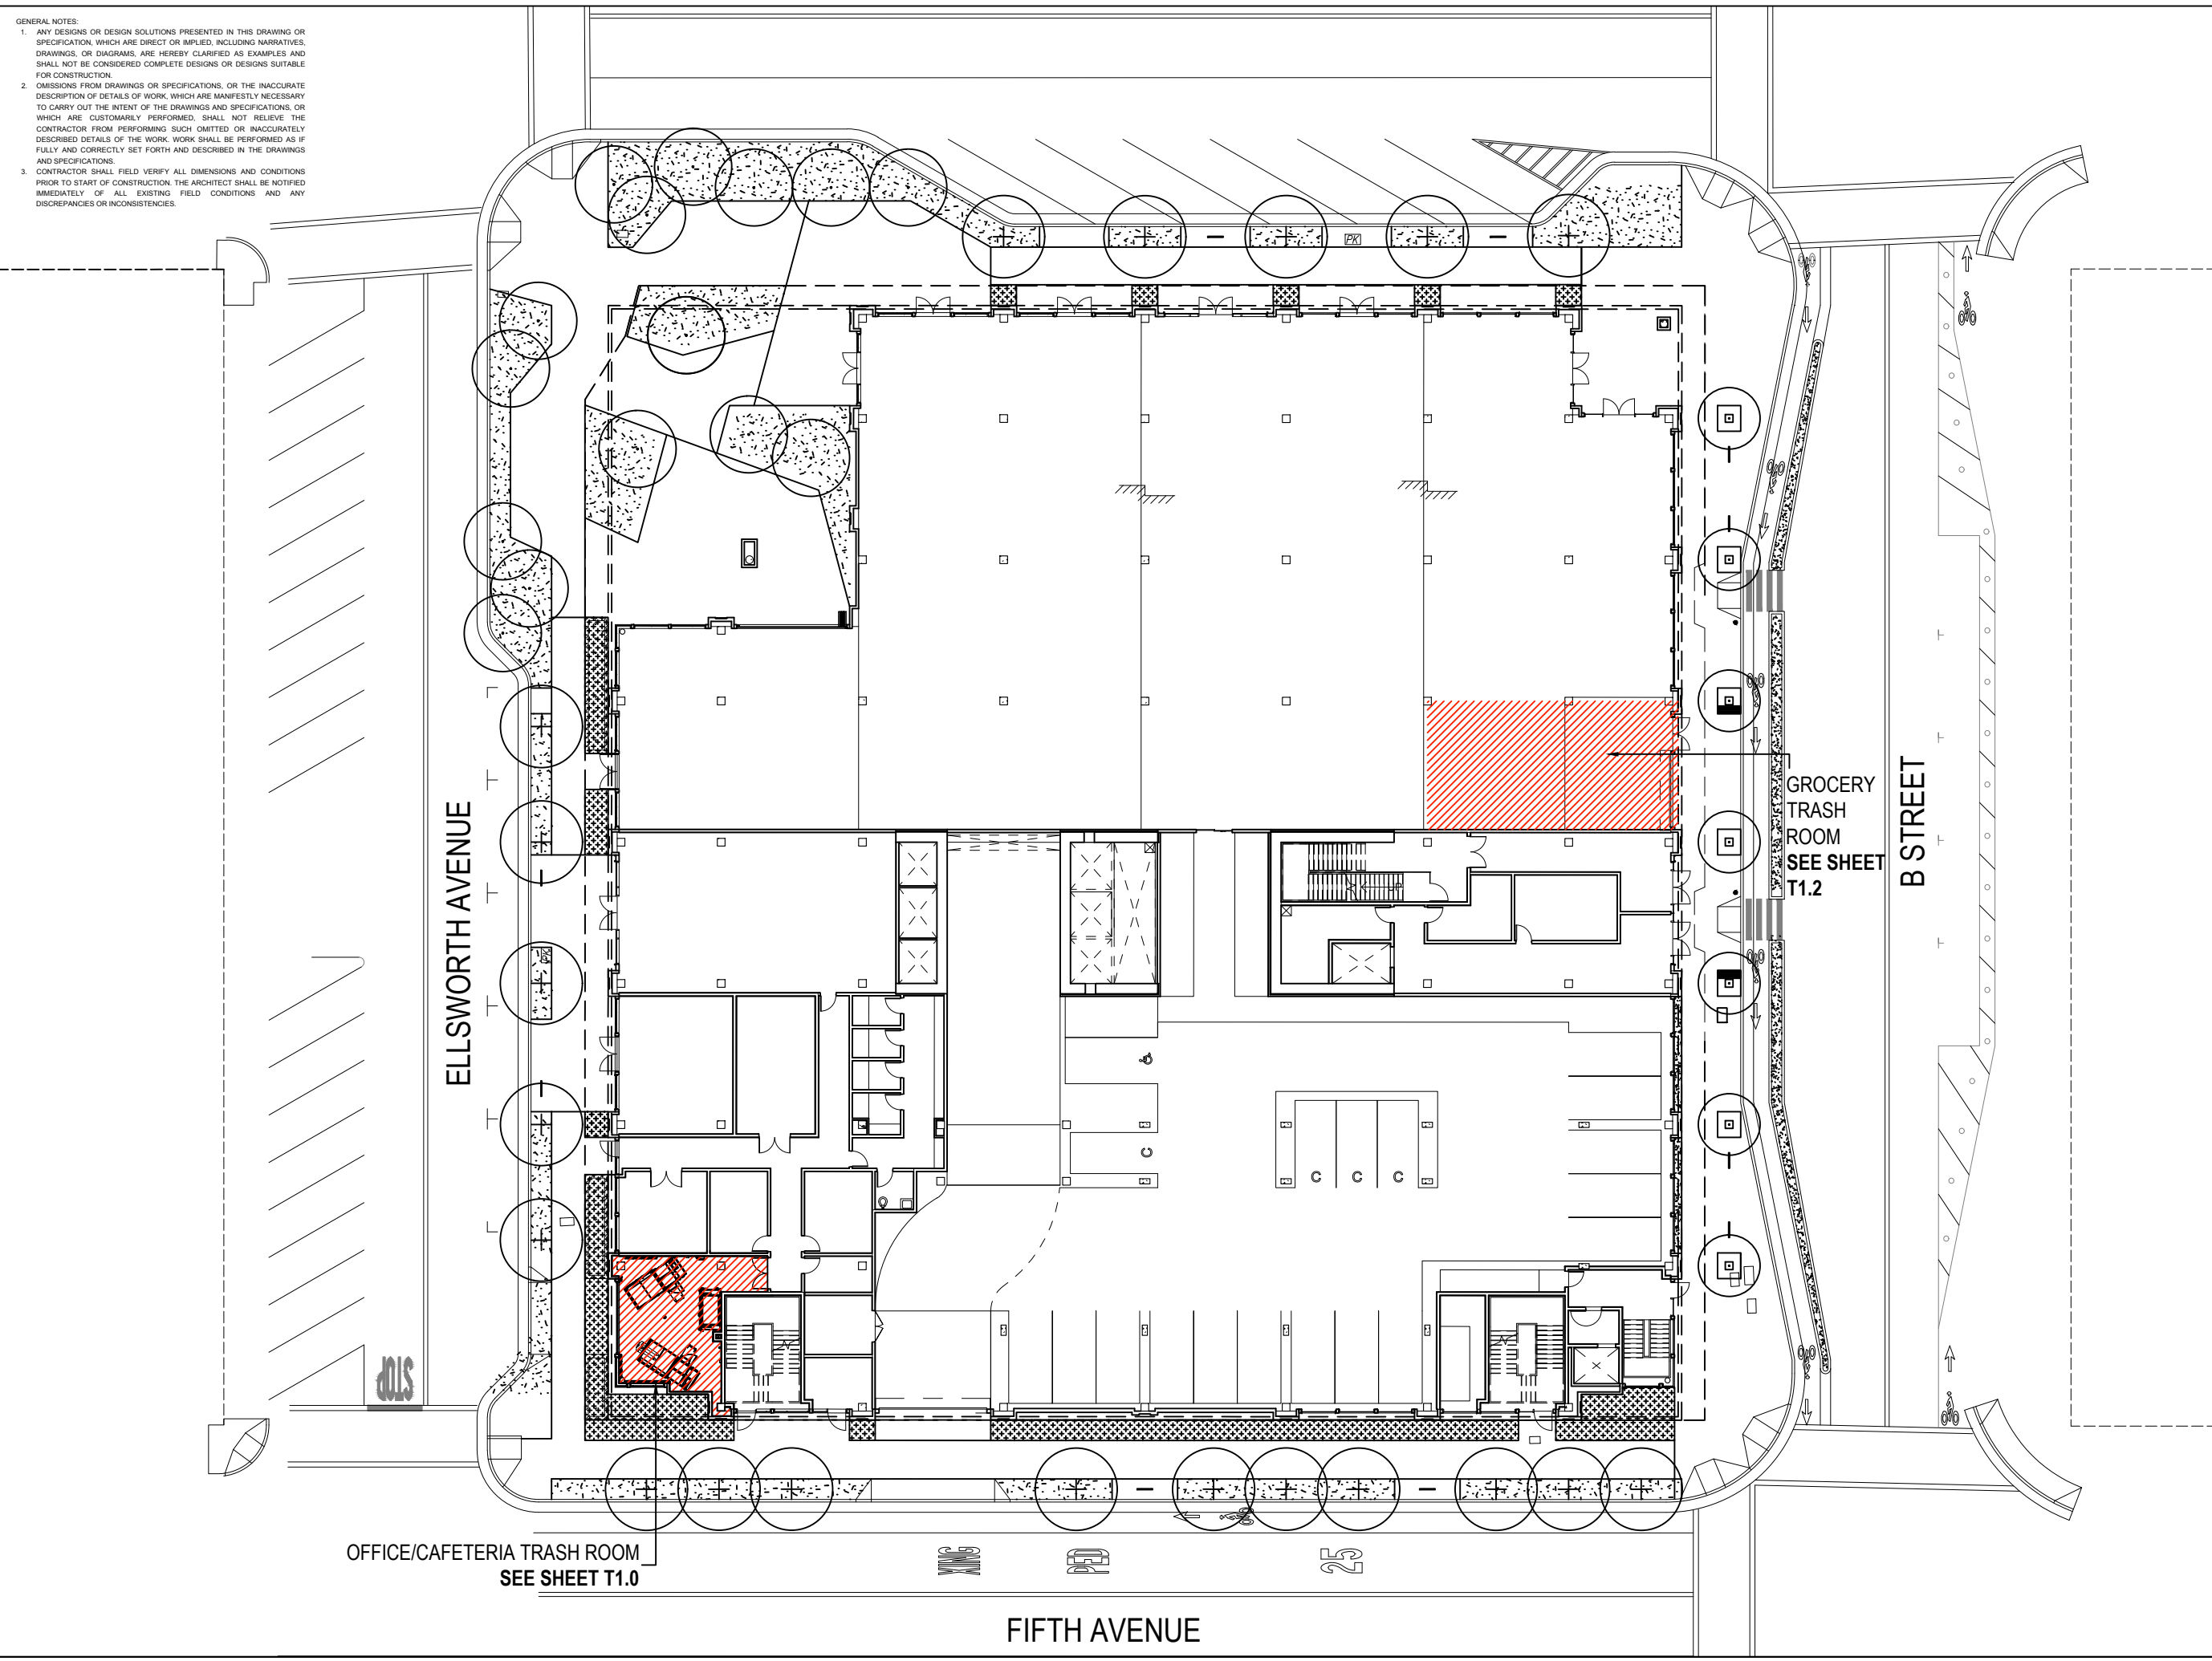KSH

ARCHITECT

LANE PARTNERS

OWNER / DEVELOPER

NO.	DATE	ISSUE / REVISION	ISSUED BY

KSH-222 E 4th-San Mateo

PROJECT

SITE PLAN
LEVEL 1

DRAWING TITLE

PROJECT NO.	DRAWING NO.
DRAWN PH	T0.1
APPROVED SB	
DATE 06/03/2022	
SCALE 1/30" = 1'-0"	

GENERAL NOTES:

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RESIDENTIAL TRASH ROOM
SEE SHEET TR1.1

ELLSWORTH AVENUE

B STREET



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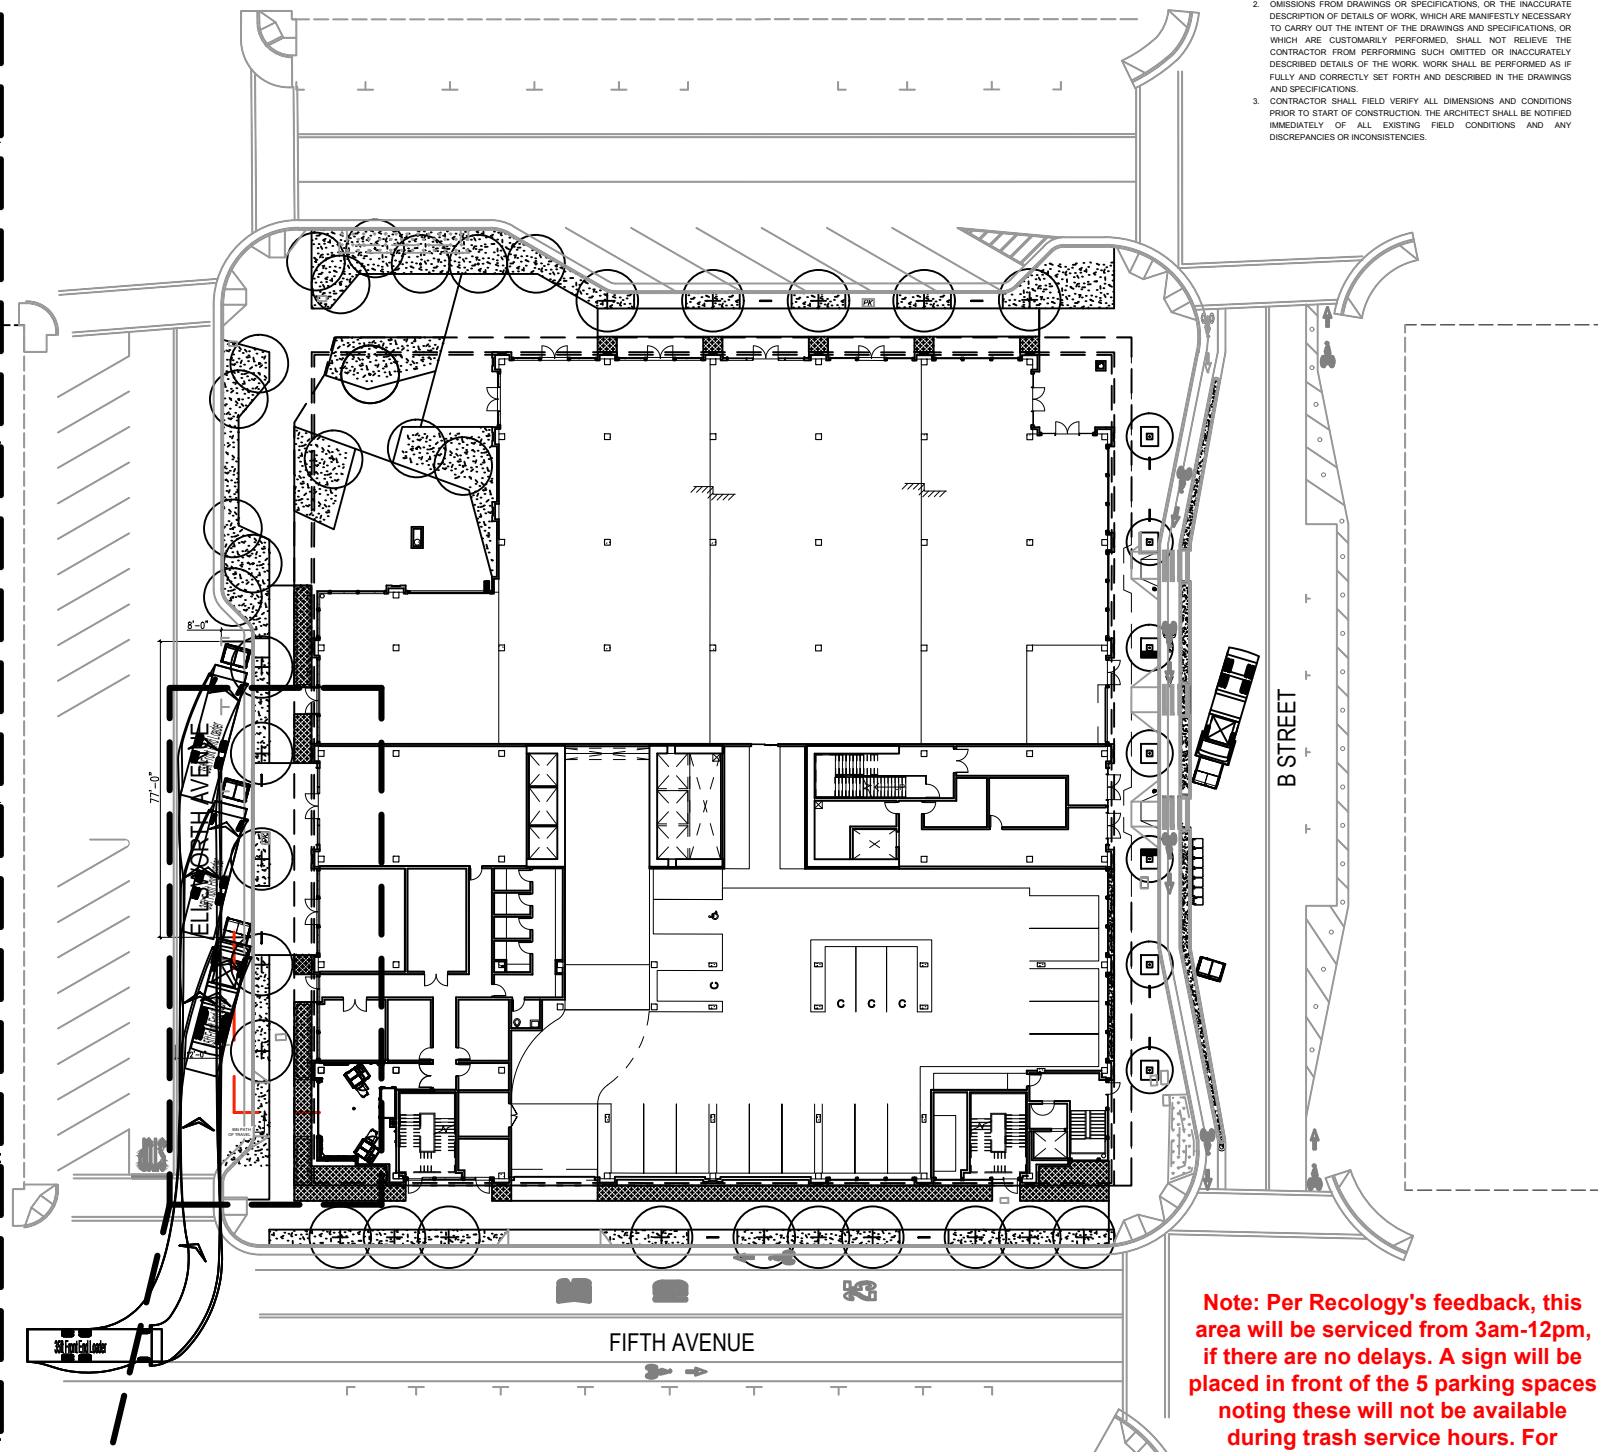
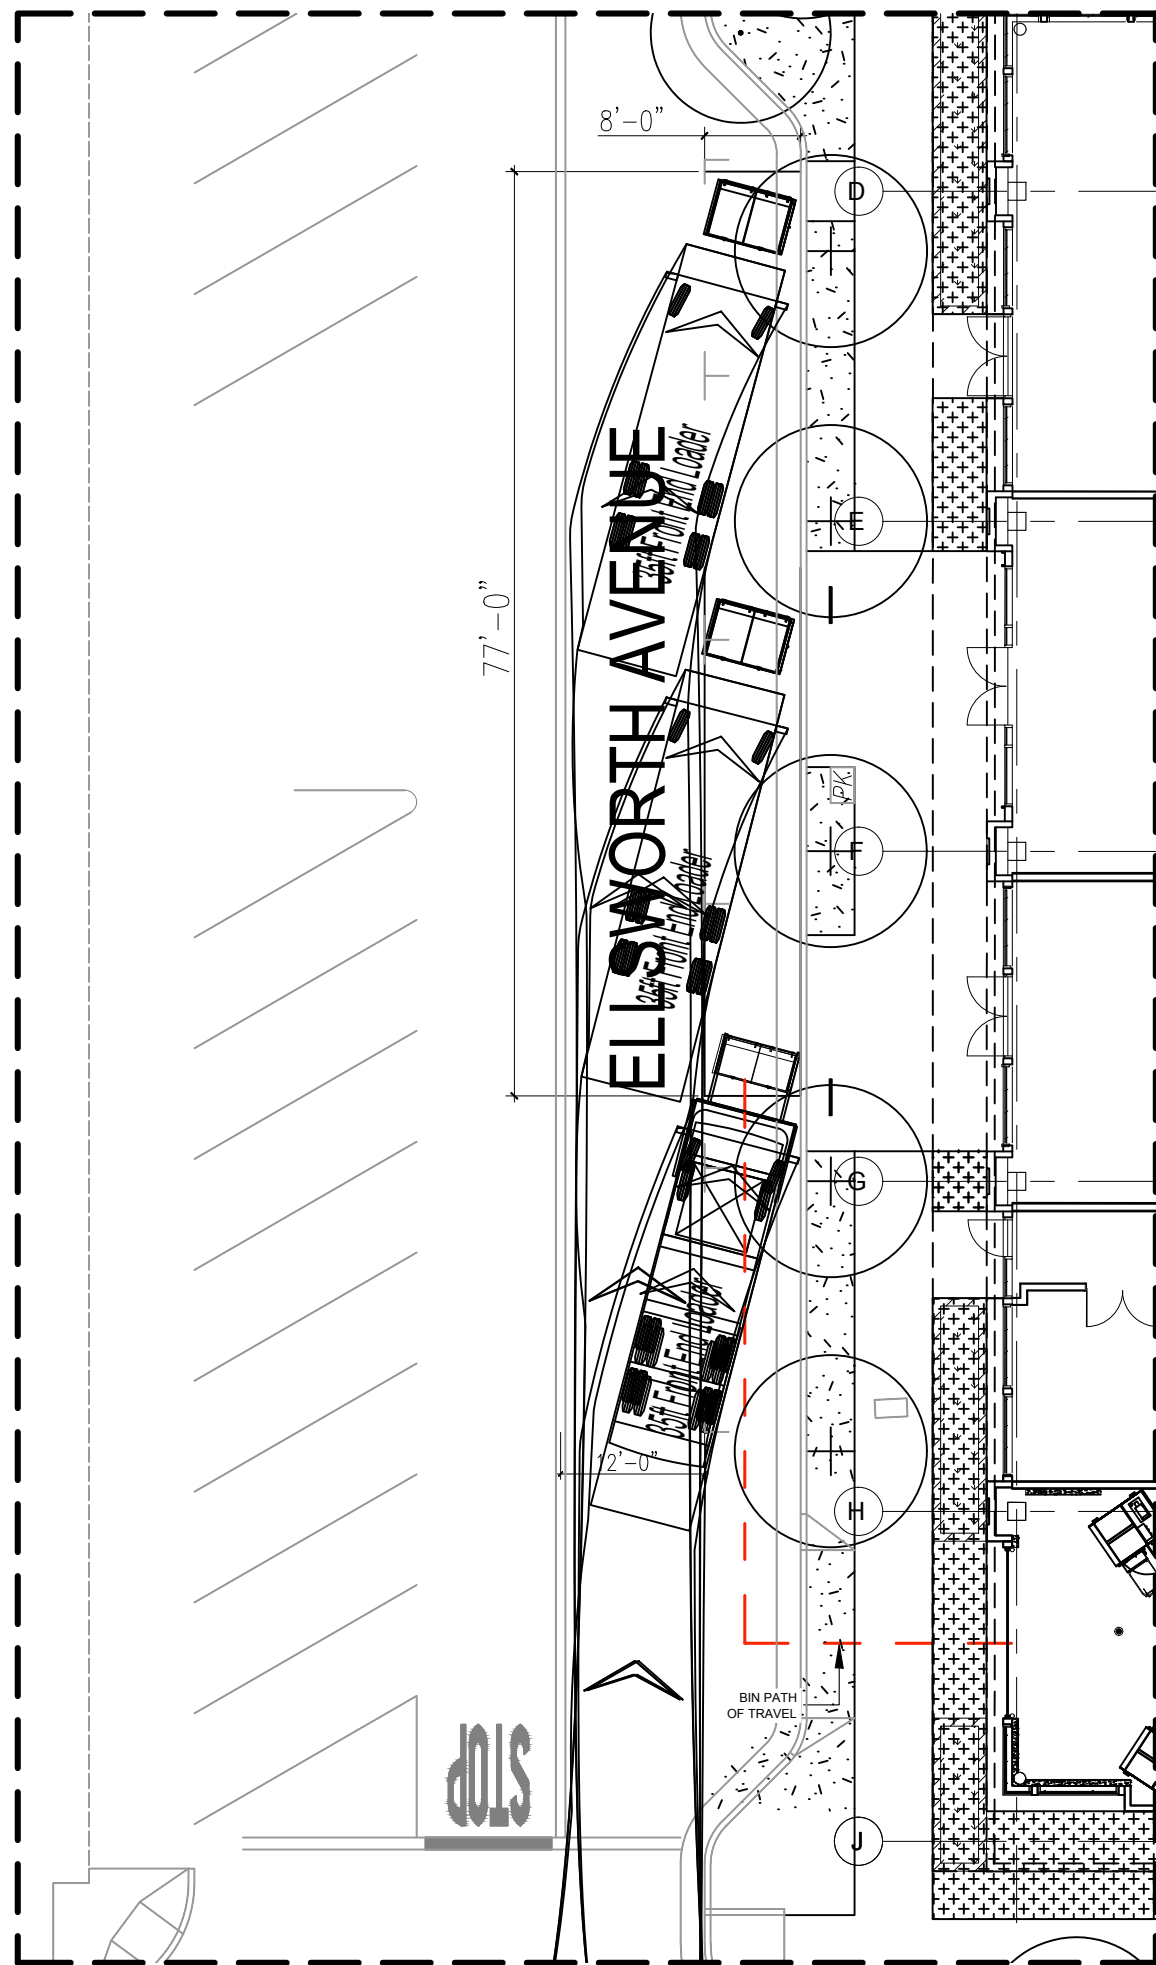
KSH-222 E 4th-San Mateo

PROJECT

KEY PLAN
TYPICAL UPPER LEVEL

DRAWING TITLE

PROJECT NO.	T0.2
DRAWN PH	
APPROVED SB	
DATE 06/03/2022	
SCALE 1/20" = 1'-0"	




PROJECTED OFFICE/CAFETERIA COLLECTION SCHEDULE/WK		
SERVICE:	CONTAINER VOL / TYPE:	FREQUENCY:
WASTE	1 x 4CY FL COMPACTOR CONTAINER	2x/wk
RECYCLING	1 x 4CY FL COMPACTOR CONTAINER	3x/wk
COMPOST	1 X 2CY FL COMPACTOR CONTAINER	2x/wk

Note: Per Recology's feedback, this area will be serviced from 3am-12pm, if there are no delays. A sign will be placed in front of the 5 parking spaces noting these will not be available during trash service hours. For example, the sign will state "No Parking on Mondays-Fridays from 10pm-12pm. Garbage Pick-Up Zone". Once these bins are picked up by Recology, building staff will immediately bring back the containers to free up these parking spaces for public use.




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RESIDENTIAL & GROCERY STAGING

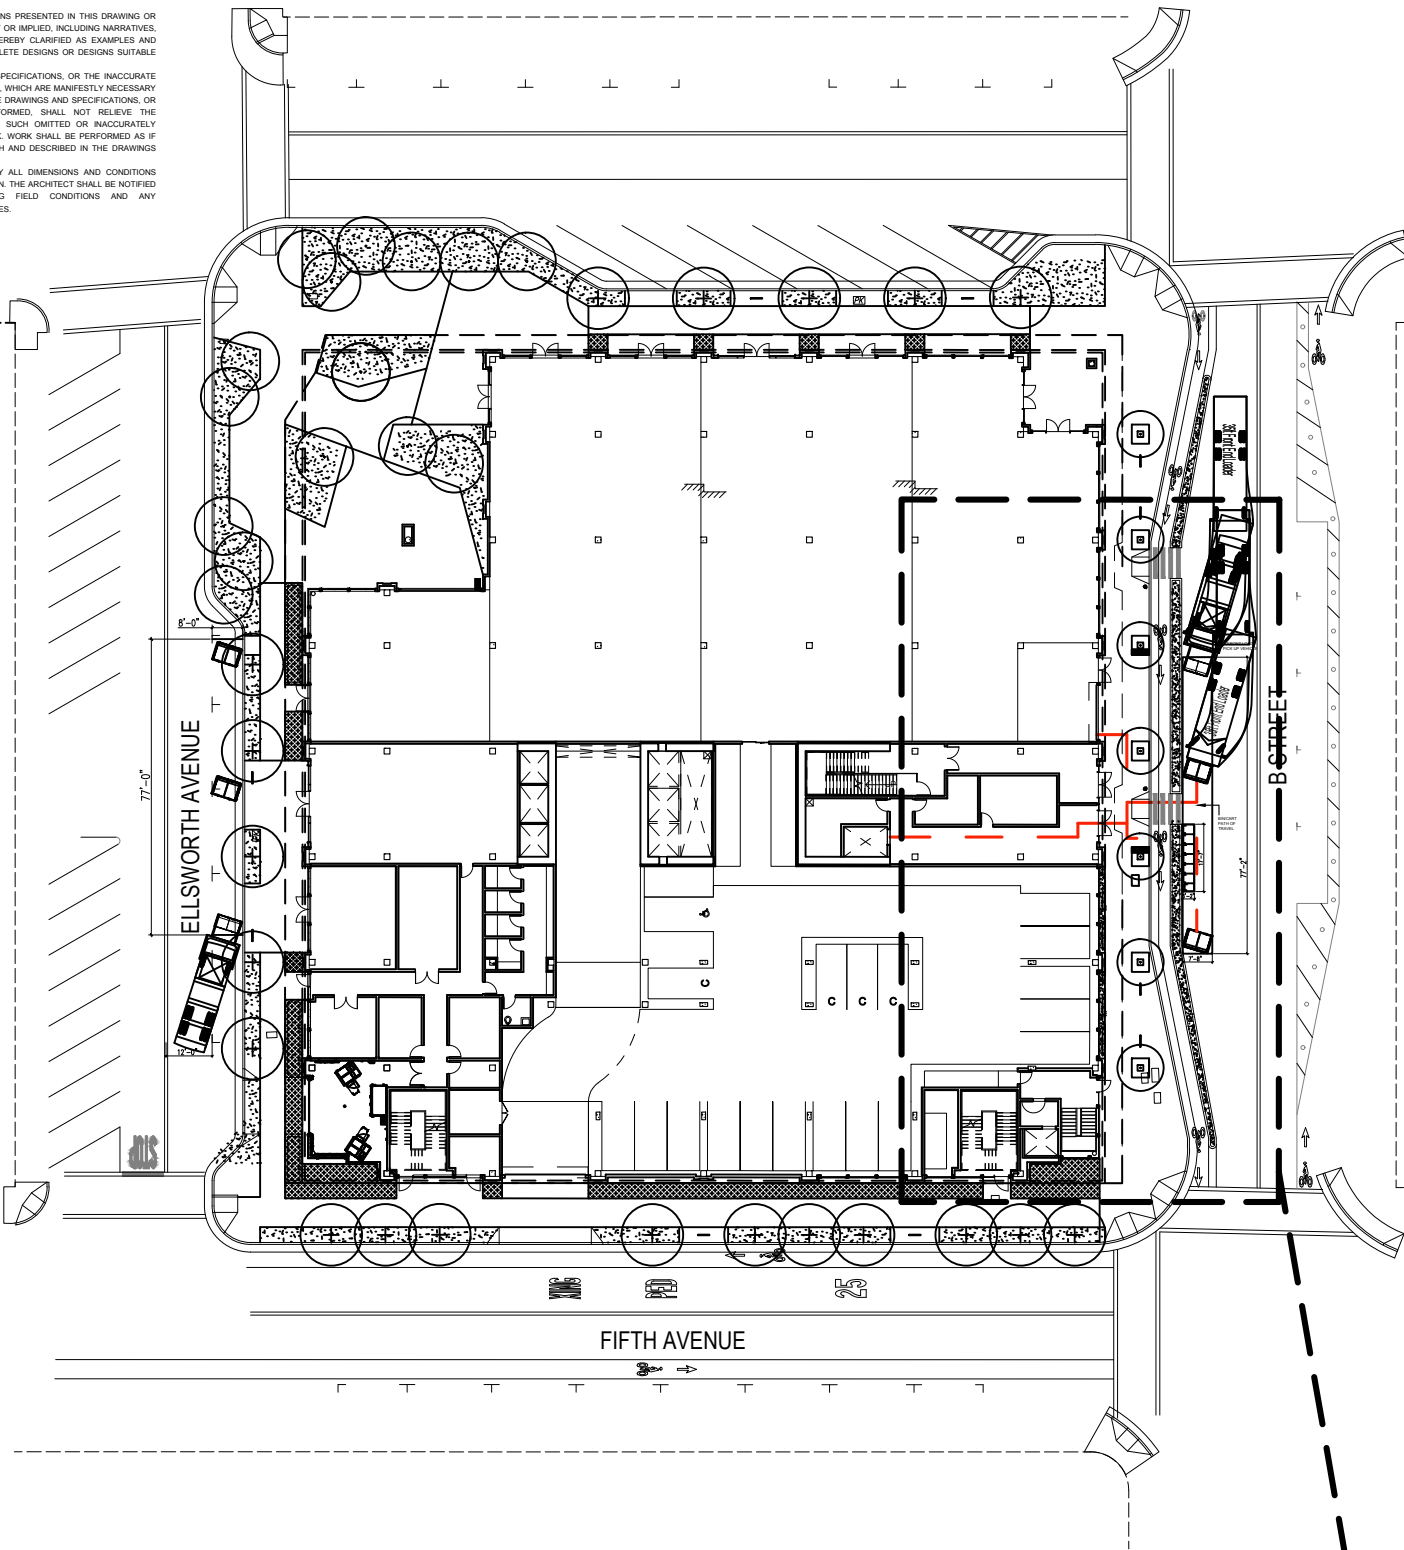PROJECTED RESIDENTIAL COLLECTION SCHEDULE/WK		
SERVICE:	CONTAINER VOL / TYPE:	FREQUENCY:
WASTE	3 x 96G LOOSE TOTER CARTS	1x/wk
RECYCLING	3 x 96G LOOSE TOTER CARTS	1x/wk
COMPOST	1 X 64G LOOSE TOTER CARTS	1x/wk

PROJECTED GROCERY COLLECTION SCHEDULE/WK		
SERVICE:	CONTAINER VOL / TYPE:	FREQUENCY:
WASTE	1 x 4CY FL COMPACTOR CONTAINER	3x/wk
RECYCLING	1 x 4CY FL COMPACTOR CONTAINER	3x/wk
COMPOST	1 X 2CY FL COMPACTOR CONTAINER	2x/wk



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CONSULTANT

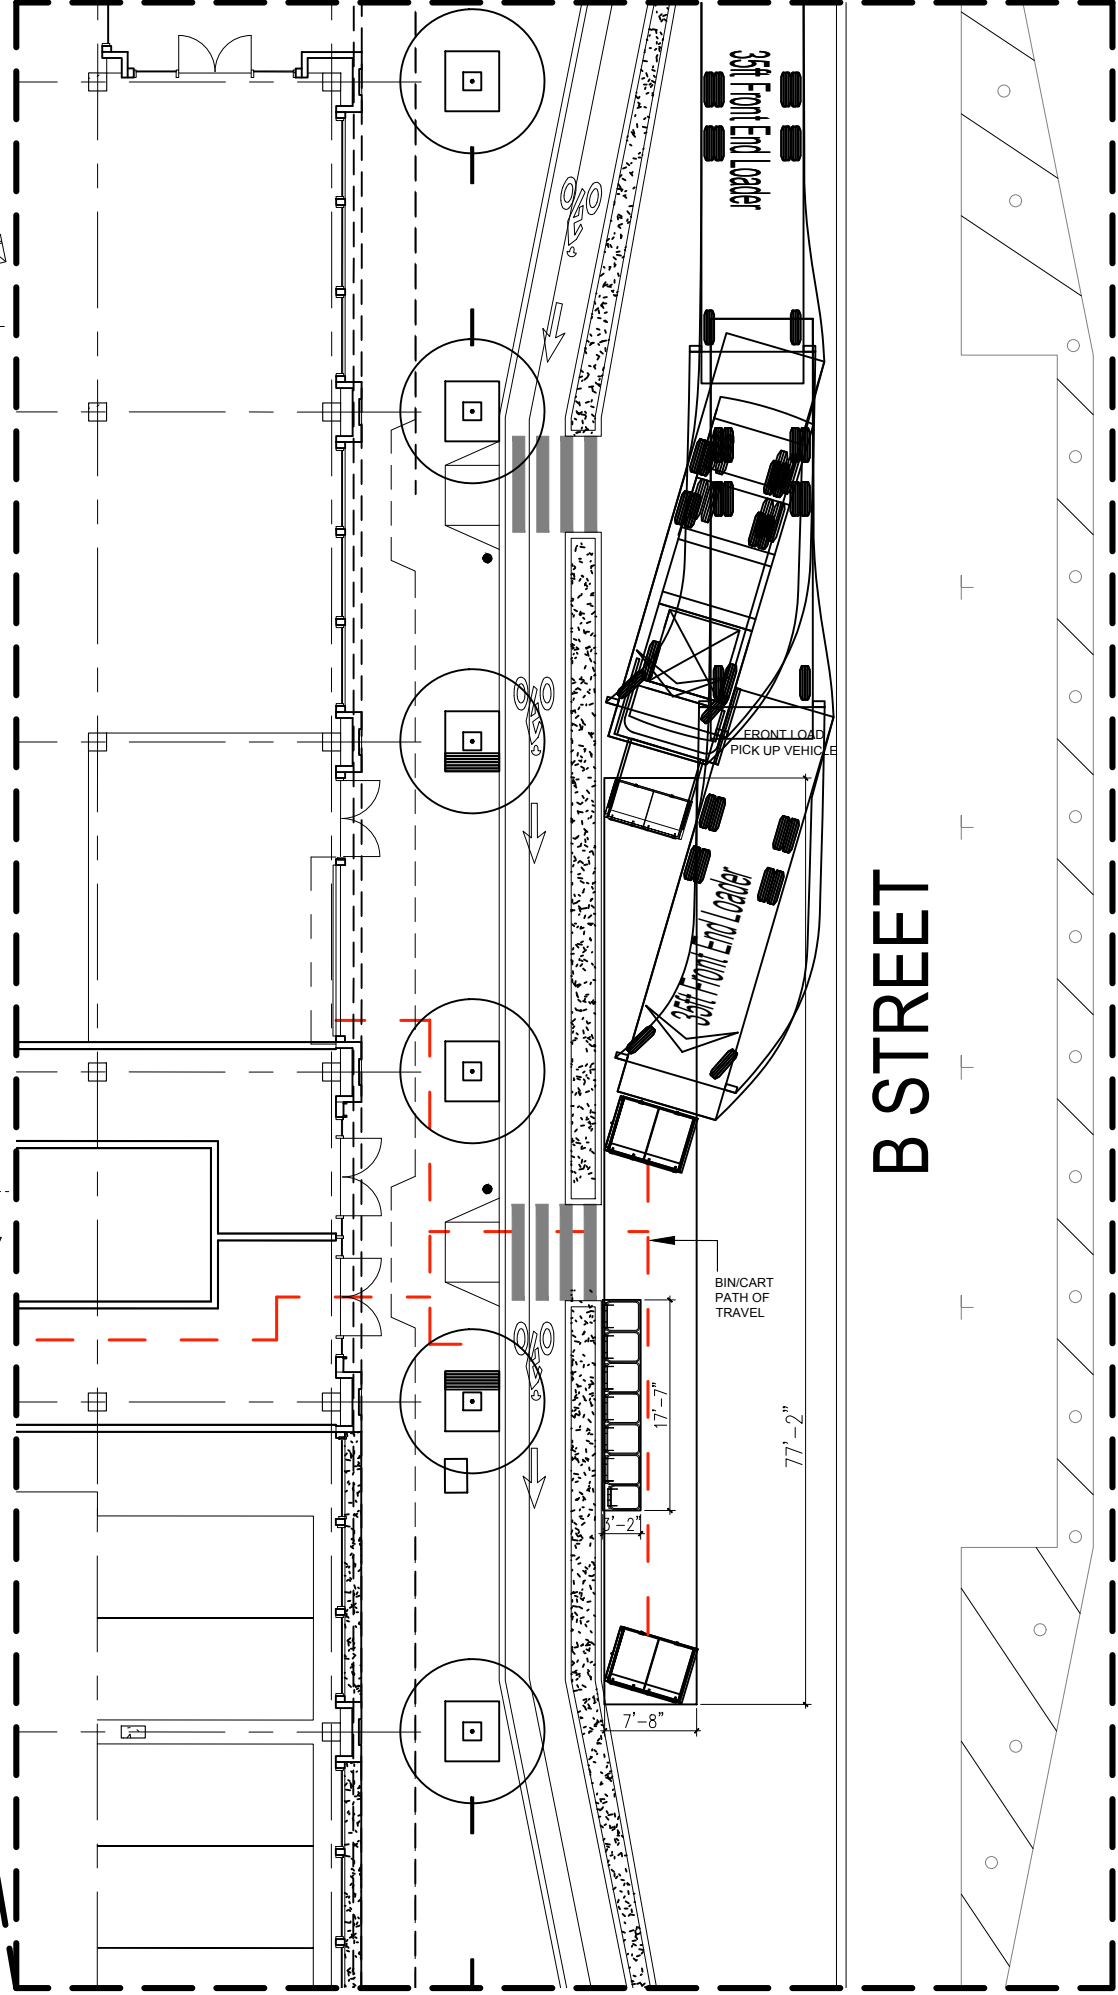KSH

ARCHITECT

LANE PARTNERS

OWNER / DEVELOPER

NO.	DATE	ISSUE / REVISION	ISSUED BY
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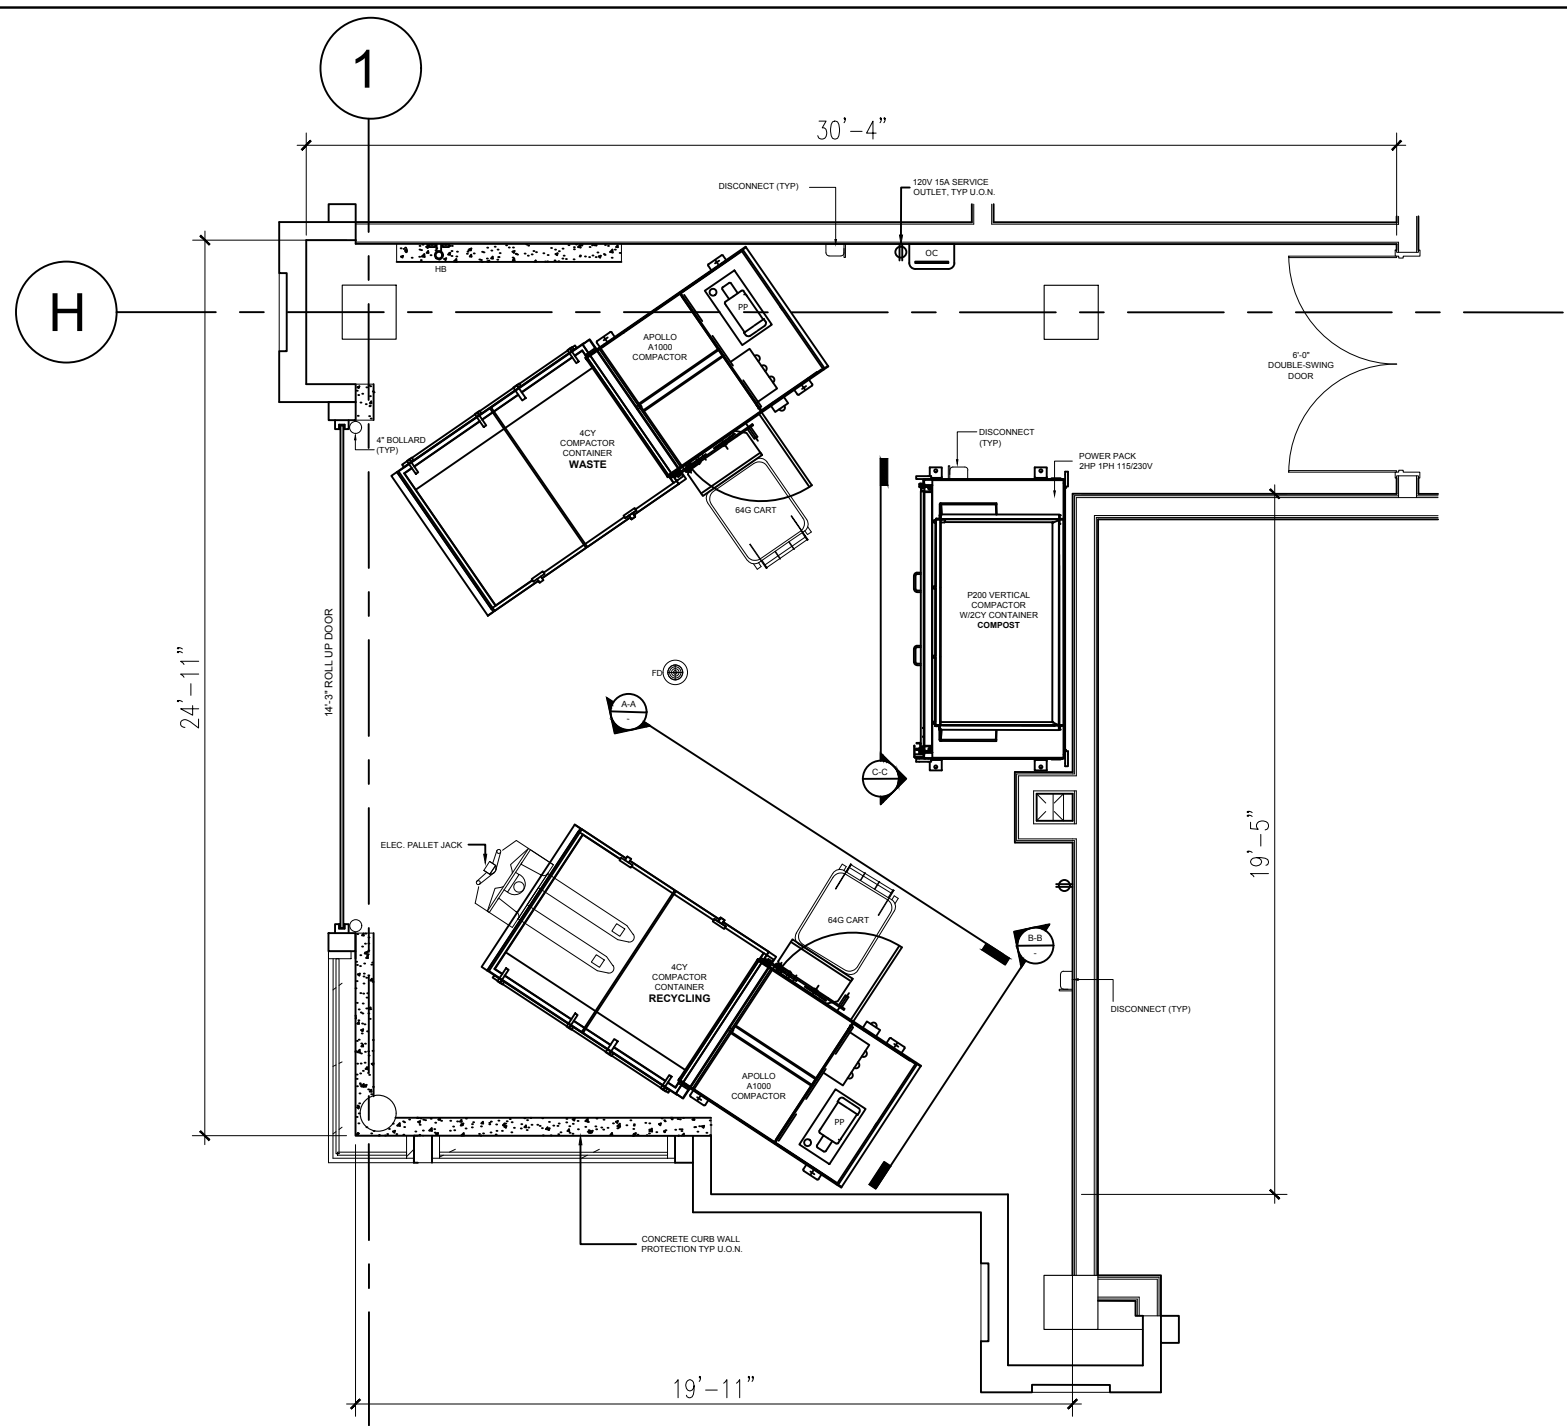
KSH-222 E 4th-San Mateo

PROJECT


STAGING DETAILS
RESIDENTIAL & GROCERY

DRAWING TITLE


PROJECT NO.	DRAWING NO.
DRAWN PH	T0.4
APPROVED SB	
DATE 06/03/2022	
SCALE 1/50" = 1'-0"	




OFFICE/CAFETERIA TRASH ROOM PLAN
LEVEL 1

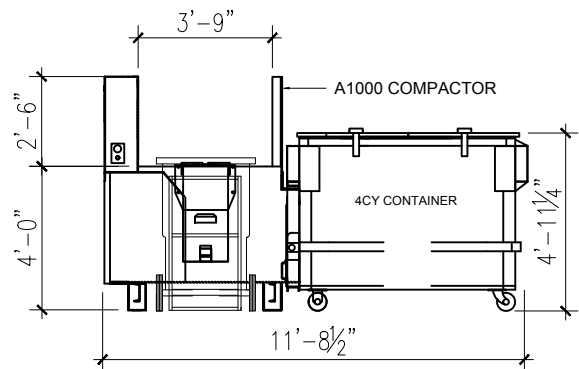

APOLLO A 1000 COMPACTOR
W/ 64 GAL CART AND
BAYNE TASKMASTER HI-LIFT DUMPER

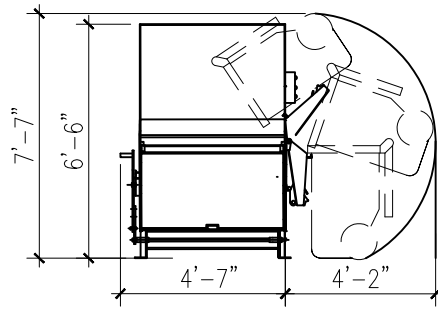

APOLLO A 1000 COMPACTOR
W/ 64 GAL CART AND
BAYNE TASKMASTER HI-LIFT DUMPER

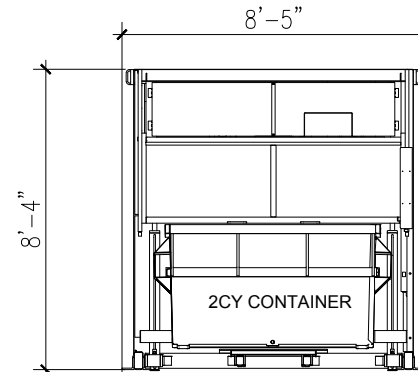

P200 COMPACTOR
W/ 2CY CONTAINER

SHEET NOTES:

COMMERCIAL TRASH COLLECTION ROOM - LEVEL 1

- CENTRAL TRASH COLLECTION AREA IS 1HR FIRE-RATED - RESTRICTED ACCESS.
- FLOOR SHALL BE FINISHED WITH WATERPROOF DECK COATING. FLOOR TO HAVE MINIMAL SLOPE (1° MAX) AND FLOOR DRAIN. FLOOR LEVEL UNDER COMPACTOR.
- WALLS SHALL BE FINISHED WITH WASHABLE WATERPROOF SURFACE SUCH AS FRP OR HIGH-GLOSS ENAMEL PAINT, 8'-0" AFF.
- INSTALL WALL PROTECTION: 12"Hx6"W CONCRETE CURB AT BASE OF ALL NON-CONCRETE WALLS.
- 14'-3" ROLL-UP DOOR, 6'-0" DOUBLE-SWING DOOR, AND 3'-0" EXIT DOOR.
- (2) A1000 SELF CONTAINED COMPACTORS FOR WASTEAND RECYCLING. PROVIDE 4CY COMPACTOR CONTAINERS.
- (1) P200 COMPACTOR WITH INTERNAL POWER PACK AND 2CY BIN FOR COMPOST. 2HP, 115/230V, 1 PHASE SERVICE REQUIRED. DISCONNECT MOUNTED 60" AFF.
- PP: COMPACTOR POWER PACKS AND LIFT POWER PACKS SHALL BE STACKED & FLOOR-MOUNTED. SEE DETAIL FOR HP PER POWER PACK. EACH PACK IS 3-PHASE, 208/230/460V. EACH PP NEEDS 30A DISCONNECT, 60" AFF.
- OC: ODOR CONTROL UNIT SHALL BE WALL-MOUNTED 60" AFF. REQUIRES 120V 15A SERVICE OUTLET.
- HB: HOT AND COLD HOSE BIB SHALL BE WALL-MOUNTED 60" AFF.
- (1) UNDEDICATED 120V 15A SERVICE OUTLET REQUIRED FOR STAFF MAINTENANCE PURPOSE.

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PROJECTED OFFICE/CAFETERIA COLLECTION SCHEDULE/WK		
SERVICE:	CONTAINER VOL / TYPE:	FREQUENCY:
WASTE	1 x 4CY FL COMPACTOR CONTAINER	2x/wk
RECYCLING	1 x 4CY FL COMPACTOR CONTAINER	3x/wk
COMPOST	1 X 2CY FL COMPACTOR CONTAINER	2x/wk



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CONSULTANT

KSH

ARCHITECT

LANE PARTNERS

OWNER / DEVELOPER

NO.	DATE	ISSUE / REVISION	ISSUED BY

KSH-222 E 4th-San Mateo

PROJECT


Office/Cafeteria Trash Collection Room Layout

DRAWING TITLE

PROJECT NO.	DRAWING NO.
DRAWN PH	T1.0
APPROVED SB	
DATE 06/03/2022	
SCALE 3/16" = 1'-0"	

3

G

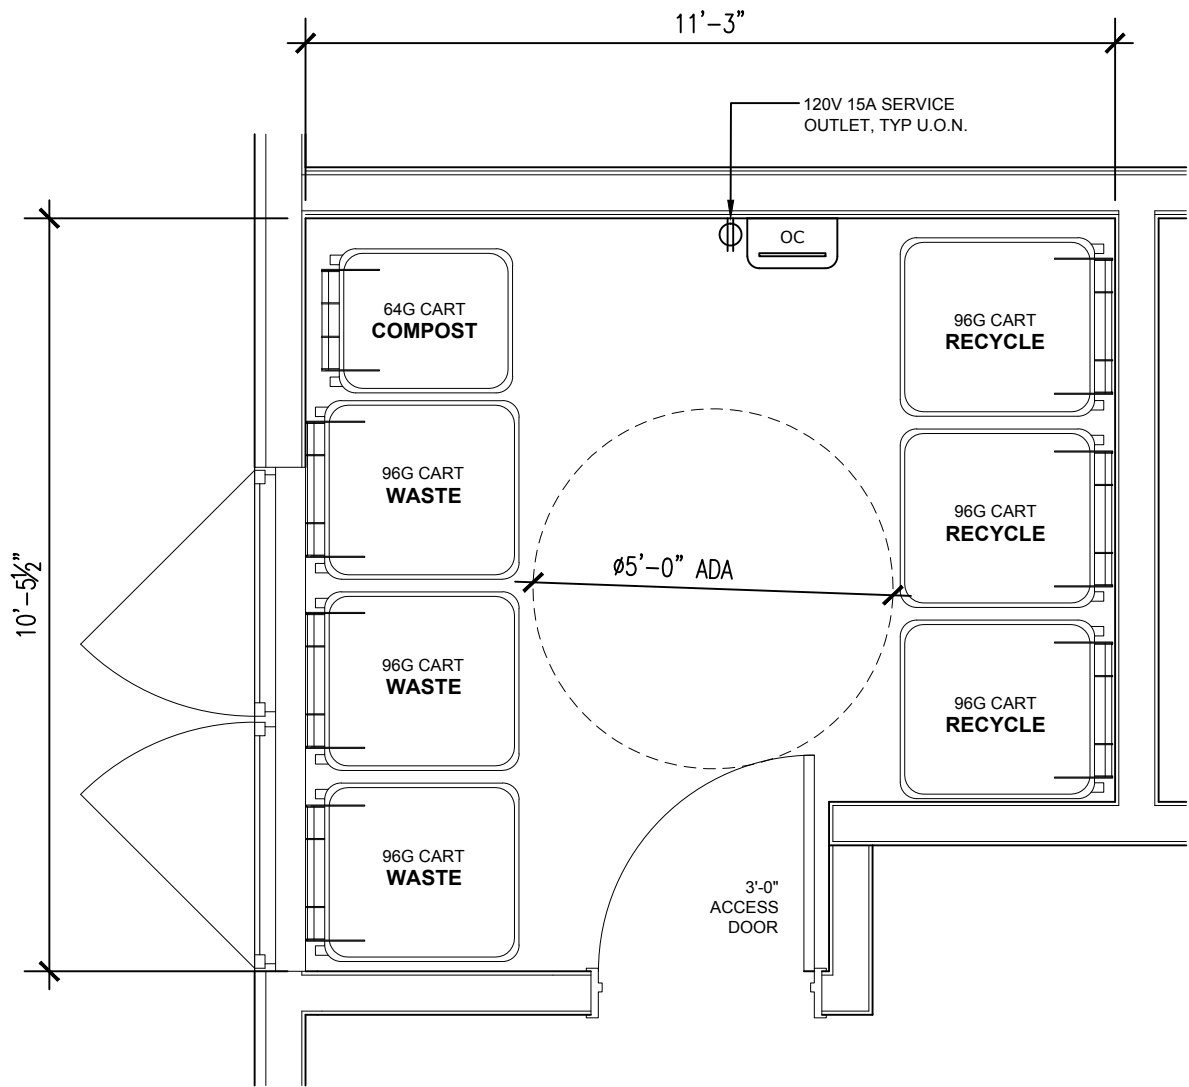

- SHEET NOTES:
- RESIDENTIAL TRASH CLOSET - LEVEL 1:
- FLOOR SHALL BE FINISHED WITH WATERPROOF DECK COATING.
 - WALLS SHALL BE FINISHED WITH WASHABLE WATERPROOF SURFACE SUCH AS FRP OR HIGH GLOSS ENAMEL PAINT, 8'-0" AFF.
 - OC: ODOR CONTROL UNIT SHALL BE WALL-MOUNTED 60" AFF. REQUIRES 120V 15A SERVICE OUTLET.
 - PROVIDE 3' ACCESS DOOR.

- GENERAL NOTES:
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PROJECTED RESIDENTIAL COLLECTION SCHEDULE/WK		
SERVICE:	CONTAINER VOL / TYPE:	FREQUENCY:
WASTE	3 x 96G LOOSE Toter Carts	1x/wk
RECYCLING	3 x 96G LOOSE Toter Carts	1x/wk
COMPOST	1 X 64G LOOSE Toter Carts	1x/wk

RESIDENTIAL TRASH CLOSET PLAN

LEVEL 5



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CONSULTANT

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ARCHITECT

LANE PARTNERS

OWNER / DEVELOPER

NO.	DATE	ISSUE / REVISION	ISSUED BY
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KSH-222 E 4th-San Mateo


PROJECT

Residential Trash Closet Layout

DRAWING TITLE

PROJECT NO.		DRAWING NO.
DRAWN	PH	
APPROVED	SB	
DATE	06/03/2022	
SCALE	3/8" = 1'-0"	

T1.1

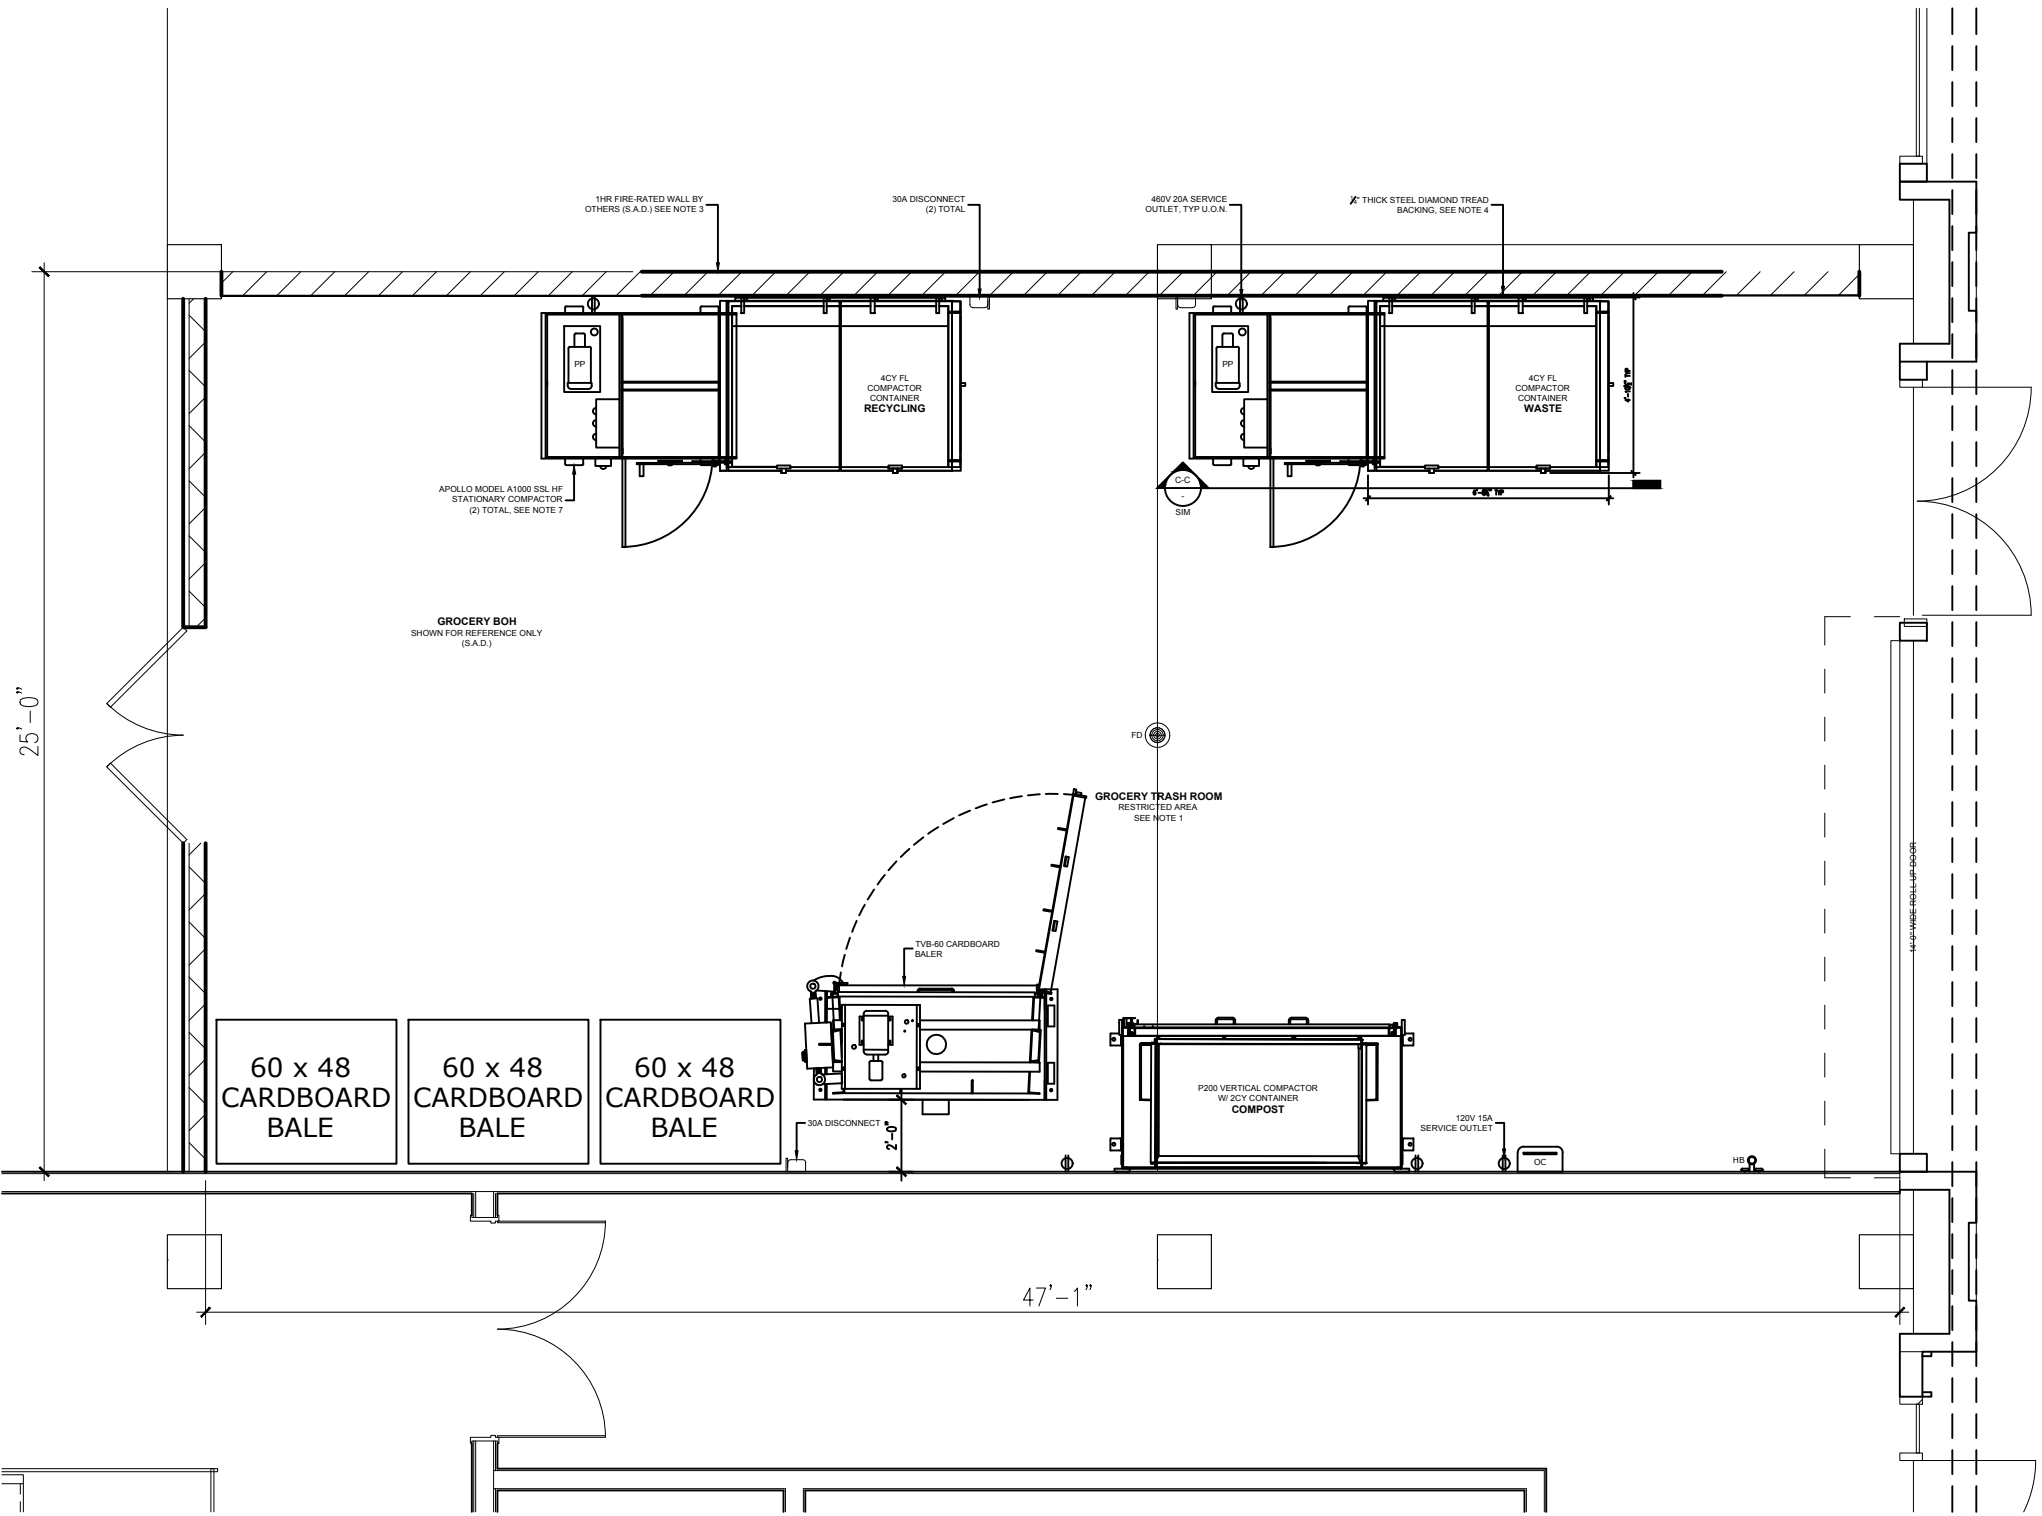

COMMERCIAL TRASH ROOM PLAN
PROTOTYPE ONLY

PROJECTED GROCERY COLLECTION SCHEDULE/WK		
SERVICE:	CONTAINER VOL / TYPE:	FREQUENCY:
WASTE	1 x 4CY FL COMPACTOR CONTAINER	3x/wk
RECYCLING	1 x 4CY FL COMPACTOR CONTAINER	3x/wk
COMPOST	1 X 2CY FL COMPACTOR CONTAINER	2x/wk

- SHEET NOTES:**
BUILDING 1. COMMERCIAL TRASH ROOM. LEVEL 1
- TRASH COLLECTION ROOM IS 1HR FIRE-RATED - RESTRICTED ACCESS.
 - FLOORS SHALL BE FINISHED WITH WATERPROOF DECK COATING WITH MINIMAL SLOPE AND FLOOR DRAIN. LEVEL FLOOR UNDER COMPACTORS.
 - WALLS SHALL BE FINISHED WITH WASHABLE WATERPROOF SURFACE SUCH AS FRP OR HIGH-GLOSS ENAMEL PAINT 8'-0" AFF.
 - WALL PROTECTION: 1/4" THICK STEEL DIAMOND TREAD BACKING ALONG WALL BEHIND COMPACTORS 6'-0" AFF.
 - (2) 10'-0" WIDE ROLL-UP DOORS FOR TRANSFERRING CONTAINERS.
 - ROOM SHALL BE MECHANICALLY VENTILATED WITH (1) CFM/SF PER 2019 CBC.
 - APOLLO MODEL A1000 SINGLE-SIDE LATCH HAND-FED STATIONARY COMPACTORS FOR WASTE AND RECYCLING.
 - PP: POWER PACKS SHALL BE COMPACTOR- MOUNTED. (2) 5HP 3-PHASE, 208/230/460V. 30A DISCONNECTS 60" AFF. PROVIDE 4CY FL COMPACTOR CONTAINERS FOR DISPOSAL.
 - AC: 2HP CHUTE AIR COMPRESSOR SHALL BE FLOOR-MOUNTED.
 - OC: ODOR CONTROL UNIT SHALL BE WALL-MOUNTED 60" AFF.
 - HB: HOT AND COLD HOSE BIBB SHALL BE WALL-MOUNTED 60" AFF.
 - PROVIDE ELECTRIC PALLET TRUCK FOR TRANSFERRING CONTAINERS. 4000LB CAPACITY WITH 45.5" TURNING RADIUS. STORE IN BUILDING 1 RESIDENTIAL TRASH ROOM.
 - 120V 15A SERVICE OUTLETS REQUIRED FOR ALL EQUIPMENT (U.O.N.).
 - STORE CARDBOARD BALES ELSEWHERE.

- GENERAL NOTES.**
- ANY DESIGNS OR SOLUTIONS SHOWN IN DRAWING, EITHER DIRECT OR IMPLIED, ARE HEREBY CLARIFIED AS EXAMPLES AND SHALL NOT BE CONSIDERED COMPLETE DESIGNS FOR CONSTRUCTION. THESE DRAWINGS ARE INTENDED TO SUPPLEMENT THE SUBMITTAL PACKAGE FROM ARCHITECT.
 - ANY PARTIAL INFORMATION, OMISSIONS, OR INACCURATE DESCRIPTIONS OF WORK SHOWN IN DRAWINGS, WHICH ARE NECESSARY TO PERFORM THE SCOPE OF WORK, SHALL NOT RELIEVE THE CONTRACTOR FROM COMPLETION OF WORK. ALL WORK SHALL BE PERFORMED TO SATISFY THE MINIMUM REQUIREMENTS OF THE CURRENT APPLICABLE BUILDING CODES. CONTRACTOR SHALL FIELD VERIFY ALL DIMENSIONS AND CONDITIONS PRIOR TO START OF CONSTRUCTION. THE ARCHITECT SHALL BE PROMPTLY NOTIFIED OF ANY INCONSISTENCIES AND/OR DISCREPANCIES.



**AMERICAN
TRASH MANAGEMENT**

AMERICAN TRASH MANAGEMENT
1900 POWELL STREET, SUITE 220
EMERYVILLE, CALIFORNIA 94608
P: 415.292.5400
F: 415.292.5410
SBROWN@TRASHMANAGE.COM

CONSULTANT

KSH

ARCHITECT

LANE PARTNERS

OWNER / DEVELOPER

NO.	DATE	ISSUE / REVISION	ISSUED BY

KSH-222 E 4th-San Mateo

PROJECT

Grocery Trash Room Prototype

DRAWING TITLE

PROJECT NO.	DRAWING NO.
DRAWN PH	T1.2
APPROVED SB	
DATE 06/03/2022	
SCALE 3/16" = 1'-0"	

ISSUES AND REVISIONS		
No.	Date	Description
A	5/5/20	Pre-Application Set
B	10/21/20	Pre-App Resubmittal
C	03/19/21	Pre-App Resubmittal


PROJECT NUMBER
16010.00

SHEET TITLE
SITE PLAN

SCALE
1/16" = 1'-0"

SHEET NUMBER

DEV-101




















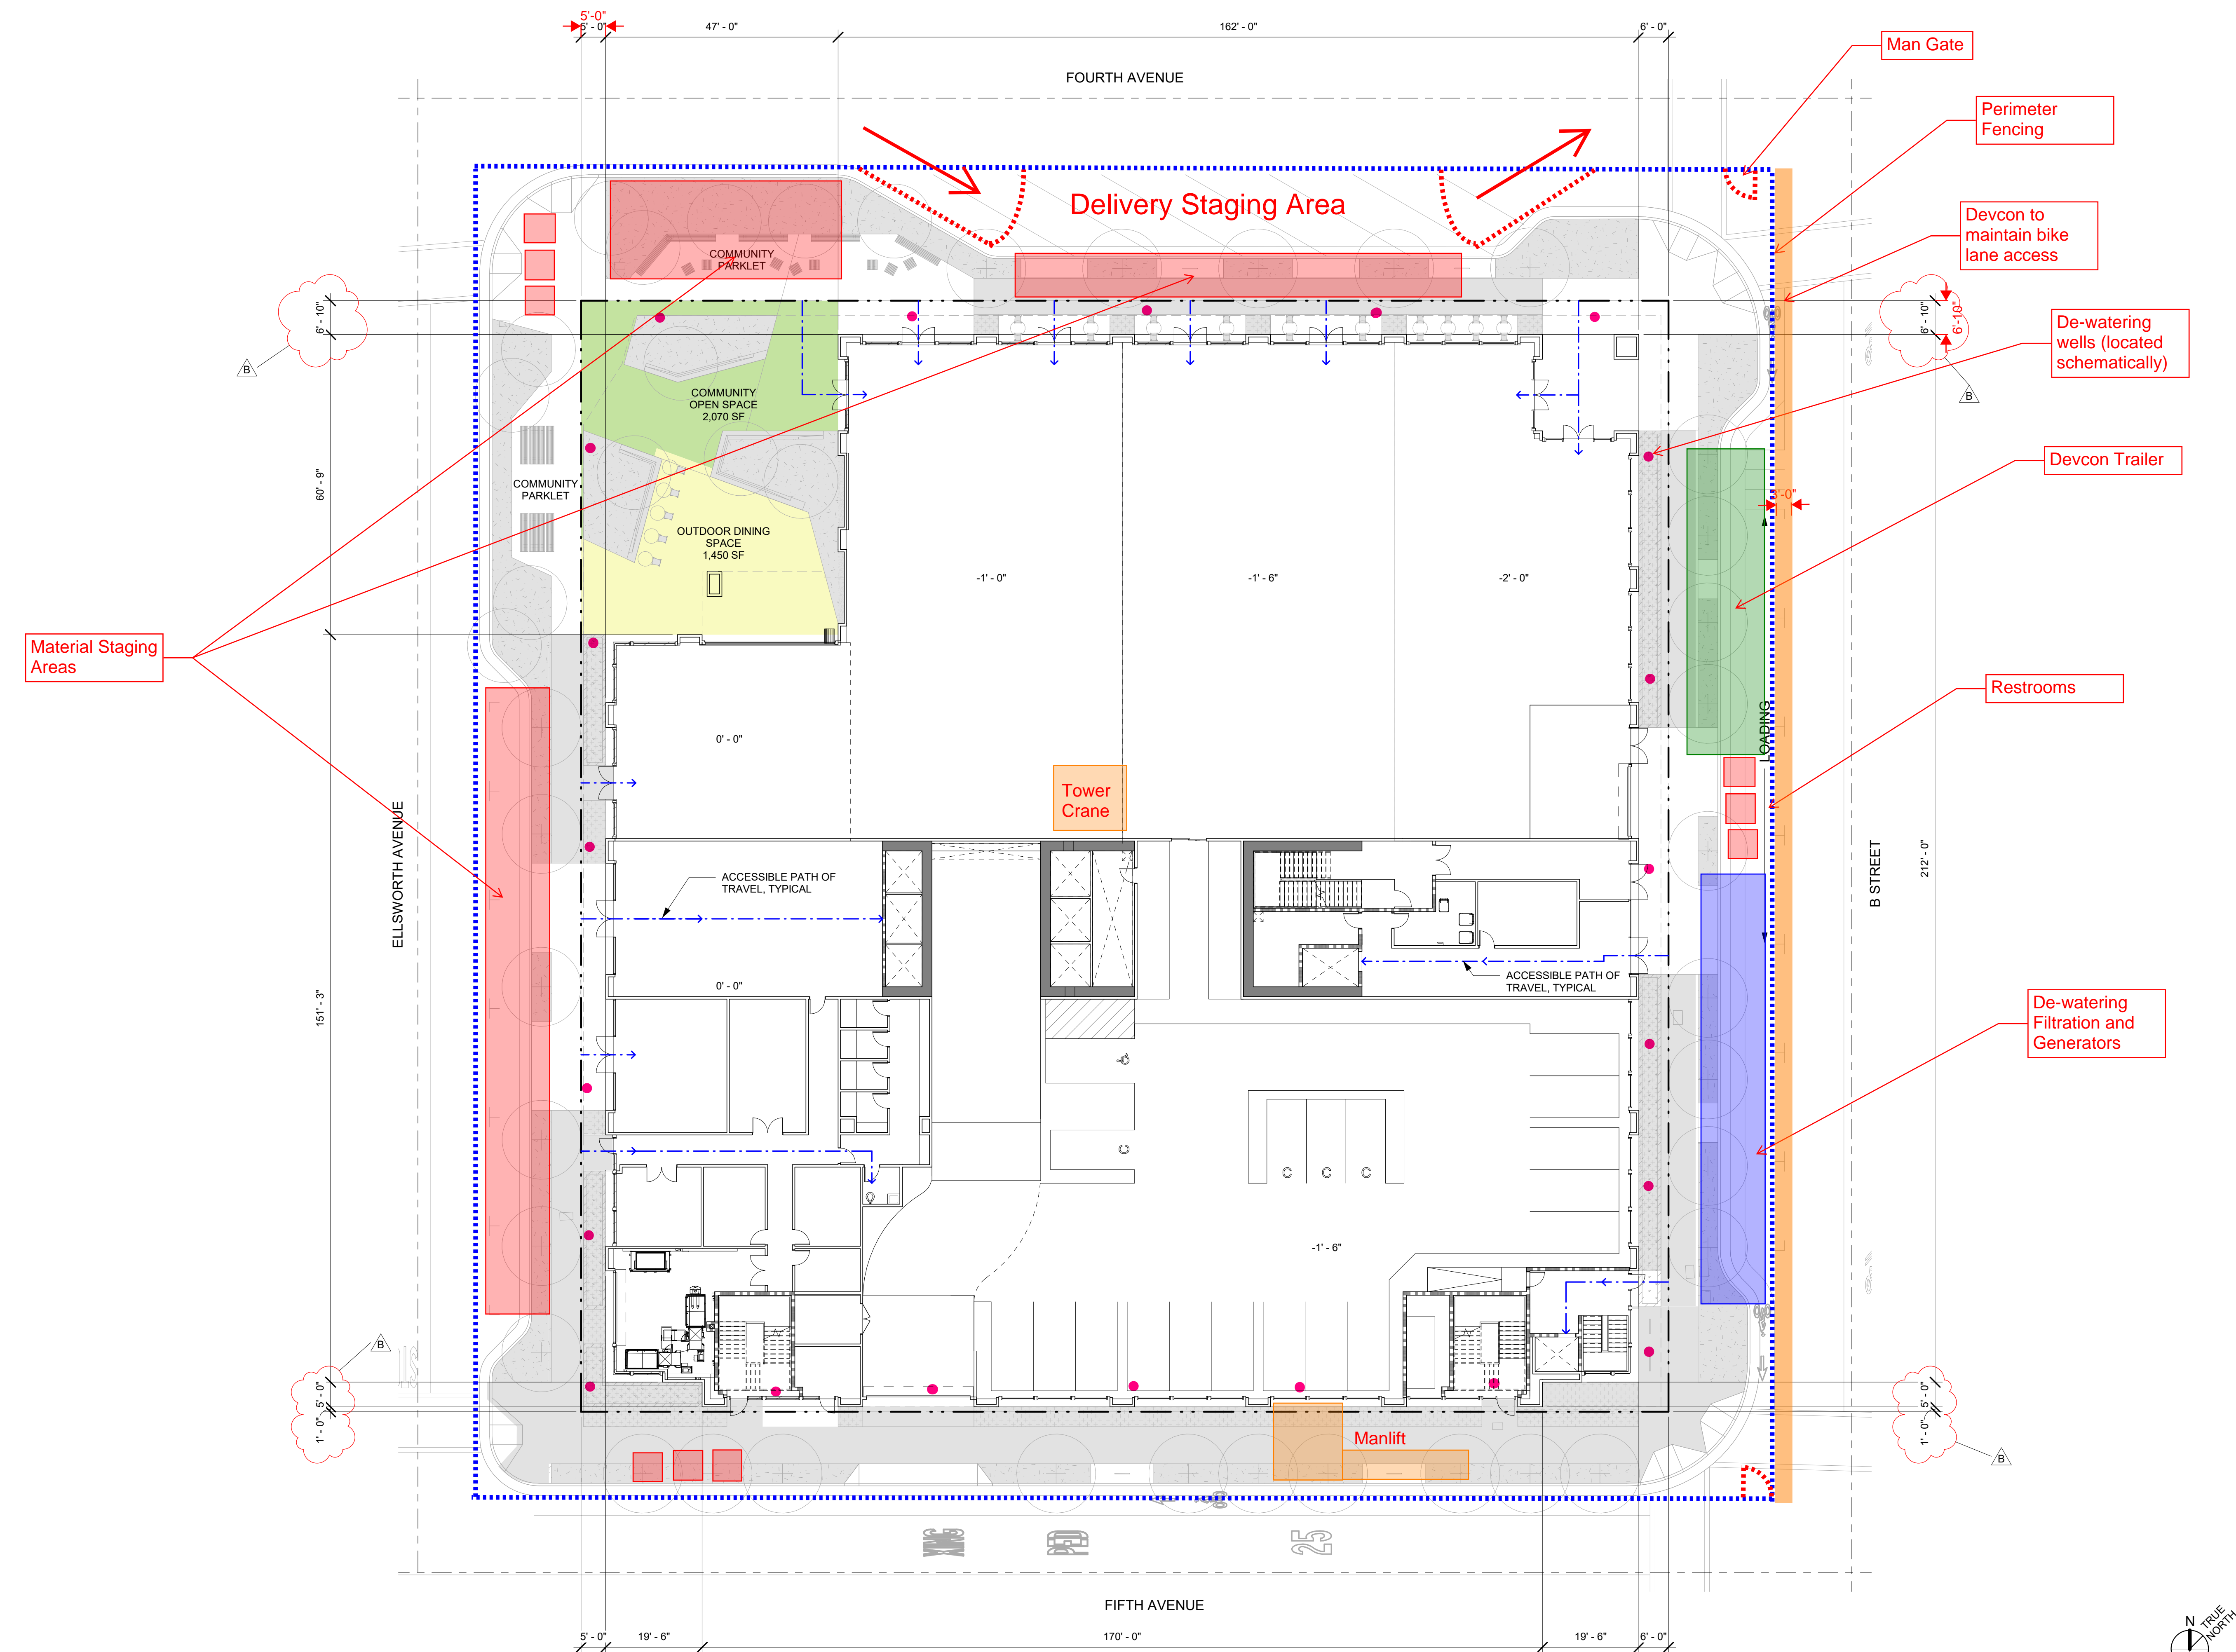





① LEVEL 1 SITE PLAN
1/16" = 1'-0"



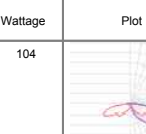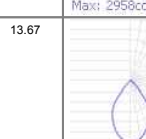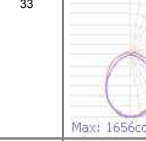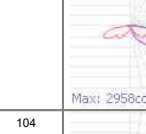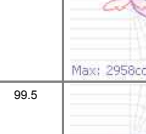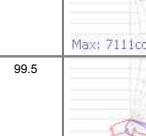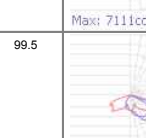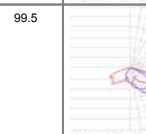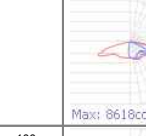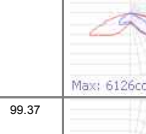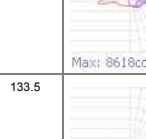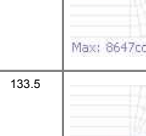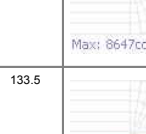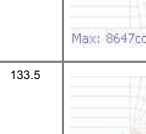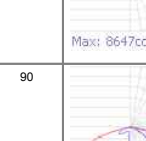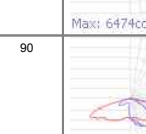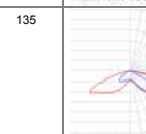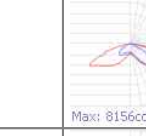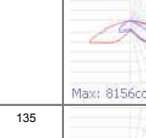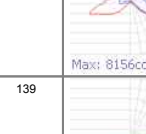

Analysis Zone	Pavement Average Horizontal Illuminance (fc) L_{avg}	Average Uniformity Ratio L_{min}/L_{max}	Maximum Uniformity Ratio L_{max}/L_{min}
4 th Ave - Road	1.7	3.0	5.0
5 th Ave - Road	1.7	3.0	5.0
B St - Road	1.1	3.0	5.0
Ellsworth Ave - Road	1.1	3.0	5.0
4 th Ave - Sidewalk	0.9	4.0	NA
5 th Ave - Sidewalk	0.9	4.0	NA
B St - Sidewalk	0.9	4.0	NA
Ellsworth Ave - Sidewalk	0.9	4.0	NA
4 th Ave / Ellsworth Ave	2.7	3.0	NA
4 th Ave / B St	2.7	3.0	NA
5 th Ave / Ellsworth Ave	2.7	3.0	NA
5 th Ave / B St	2.7	3.0	NA

Item	Quantity	Manufacturer	Catalog Number	Description	Number Lamps	Lumens Per Lamp	Light Loss Factor	Wattage	Put
	17	King Luminaire	K100WR-BAM-U 1003077-1004		1	5376	1	104	
	47	LEDRA BRANDS		NUR-CD-18M-18-35-35-D70-120- DM61-RE1-060-010	1	1045	1	13.87	
	3	WILLIAMS INDOOR	7654-L8-839 DM- UVV	4 LED T8SP LUMINAIRE WHITE RETRACTABLE SPRING-ROD SQUARE LENS	1	4862	0.2	33	
	0	King Luminaire	K100WR-BAM-U 1003077-1004		1	5376	1	104	
	1	King Luminaire	K100WR-BAM-U 1003077-1004		1	5376	1	104	
	1	CREE, INC.	XBPASHAU or BQBPASHAU	DOUBLE LED MODULE TYPE II 4000K XSP2	10	960	1	96.5	
	1	CREE, INC.	XBPASHAU or BQBPASHAU	DOUBLE LED MODULE TYPE II 4000K XSP2	10	960	1	96.5	
	1	CREE, INC.	XBPASHAU or BQBPASHAU	DOUBLE LED MODULE TYPE II 4000K XSP2	10	960	1	96.5	
	1	CREE, INC.	XBPASHAU or BQBPASHAU	DOUBLE LED MODULE TYPE II 4000K XSP2	10	960	1	96.5	
	1	Cree Inc.	BQSP-3-6x3M-8-40K- L	XSP LED Streetlight, Double Module, Version 8, Type II Medium, 4000K CCT	1	10073	1	99.37	
	1	Cree Inc.	STR-LW-3M-36-08- E-LS-SD-40K (2294W) CONF. SQUARE FROM STR- LW-3M-36-08-0E-LS- 700-40K or BQSL-029E- L07 (1094)	CONFIGURED FROM LED Type II Medium Core, T60A-4000K LEDway Streetlight	60	150	1	100	
	1	Cree Inc.	BQSP-3-6x3M-8-40K- L	XSP LED Streetlight, Double Module, Version 8, Type II Medium, 4000K CCT	1	10073	1	99.37	
	1	Litekce Electronics USA Corp., San Jose CA 95131	GC1-80F-MW-AW3-3-0Y- 535 Street from CCT, 80F-AW-AW3-3-0Y-700 141-646-1	Litekce Saged-mounted 80 LED Street light, Cat No. GC1-80F-MW-AW3-3-0Y-650 Day power control and aluminum housing with vertical cooling fin above LED. Removable, flange, gear housing size: 80 Lumen T LED's in total arrangement, Lumens approx 8.5" x 7.5", Two Lx- On Power LED Drivers, Model No. FA-101- 185, 100-277Vw 50/60Hz, Tested at 120V 60Hz with lumens opening horizontal. Dimming set to 529mA	80	177	1	133.5	
	1	Litekce Electronics USA Corp., San Jose CA 95131	GC1-80F-MW-AW3-3-0Y- 535 Street from CCT, 80F-AW-AW3-3-0Y-700 141-646-1	Litekce Saged-mounted 80 LED Street light, Cat No. GC1-80F-MW-AW3-3-0Y-650 Day power control and aluminum housing with vertical cooling fin above LED. Removable, flange, gear housing size: 80 Lumen T LED's in total arrangement, Lumens approx 8.5" x 7.5", Two Lx- On Power LED Drivers, Model No. FA-101- 185, 100-277Vw 50/60Hz, Tested at 120V 60Hz with lumens opening horizontal. Dimming set to 529mA	80	177	0.75	133.5	
	1	Litekce Electronics USA Corp., San Jose CA 95131	GC1-80F-MW-AW3-3-0Y- 535 Street from CCT, 80F-AW-AW3-3-0Y-700 141-646-1	Litekce Saged-mounted 80 LED Street light, Cat No. GC1-80F-MW-AW3-3-0Y-650 Day power control and aluminum housing with vertical cooling fin above LED. Removable, flange, gear housing size: 80 Lumen T LED's in total arrangement, Lumens approx 8.5" x 7.5", Two Lx- On Power LED Drivers, Model No. FA-101- 185, 100-277Vw 50/60Hz, Tested at 120V 60Hz with lumens opening horizontal. Dimming set to 529mA	80	177	1	133.5	
	1	King Luminaire	M83-PR4D-B- 1003531-8000	M83-PR4D-LED LED STREET LIGHT NOT BE USED IN THE CLIENT TO CLAIM THE PRODUCT CERTIFICATION, APPROVAL, OR DISCREPANCY BY NAL or NEST, OR ANY GOVERNMENT AGENCY	1	11996	0.75	90	
	1	King Luminaire	M83-PR4D-B- 1003531-8000	M83-PR4D-LED LED STREET LIGHT NOT BE USED IN THE CLIENT TO CLAIM THE PRODUCT CERTIFICATION, APPROVAL, OR DISCREPANCY BY NAL or NEST, OR ANY GOVERNMENT AGENCY	1	11996	1	90	
	1	CREE, INC.	STR-LW-3M-36-08- E-LS-SD-40K (2294W) CONF. SQUARE FROM STR- LW-3M-36-08-0E-LS- 700-40K or BQSL-029E- L07 (1094)	CONFIGURED FROM LED Type II Medium Core, T60A-4000K LEDway Streetlight	60	150	1	100	
	1	CREE, INC.	STR-LW-3M-36-08- E-LS-SD-40K (2294W) CONF. SQUARE FROM STR- LW-3M-36-08-0E-LS- 700-40K or BQSL-029E- L07 (1094)	CONFIGURED FROM LED Type II Medium Core, T60A-4000K LEDway Streetlight	60	150	1	100	
	1	CREE, INC.	STR-LW-3M-36-08- E-LS-SD-40K (2294W) CONF. SQUARE FROM STR- LW-3M-36-08-0E-LS- 700-40K or BQSL-029E- L07 (1094)	CONFIGURED FROM LED Type II Medium Core, T60A-4000K LEDway Streetlight	60	150	1	100	

LIGHTING FIXTURE SCHEDULE							
TYPE	SYMBOL	TYPE / LOCATION	MANUFACTURER / CATALOG NO.	LAMPS	WATTS	VOLTAGE	NOTES
P1		LED POLE LIGHT	King Luminaire: K118-B3AR-IV-100(SSL)	LED	92W	120/277	DIMMABLE, WET LISTED
A		LED DOWNLIGHT	ALPHABET: NU6-QD-XTM19-13LM-30K-83-D70-120-DIM10-RET-WH-WH	LED	14W	120/277	DIMMABLE, WET LISTED
B		4' LED STRIP	WILLIAMS: 75S-4-L50-835-DIM-UNV	LED	33W	120/277	DIMMABLE, WET LISTED



KSH
ARCHITECTS
KORTH SUNSERI HAGEY

No.	Date	Description
A	2/14/20	Pre-Application Set

PROJECT NUMBER
16010.00

SHEET TITLE
**SITE LIGHTING
PHOTOMETRIC
CALKS**

SCALE

SHEET NUMBER

EP-1

K118 WASHINGTON - LED

The King Luminaire K118 Washington is a beautiful depiction of this street light classic. This historical acorn shape teamed with King Luminaire's high performance LED engines make for a perfect solution for city streets, parks, schools and commercial areas.

PRODUCT SPECIFICATIONS

R1/B3/B2 LED ENGINE

Light engine shall be an array of 36, 42, 54 or 63 solid state Cree X-Series high power LEDs (light emitting diodes) mounted to a multi-sided, vertical heat sink of highly conductive aluminum. The LED emitters are arranged in various patterns on each face of the vertical heat sink to provide the required light distribution.

The LED arrays include optical baffles constructed of optical grade ABS plastic with a vacuum metallized reflective surface or clear acrylic precision reflectors over each diode. Optical options are designed to efficiently control light distribution in IESNA Type IV & V for the R1/B3/B2 and Type III & V for the R1.

PA LED ENGINE

Light engine shall include an array of Cree X-Series high power LEDs (light emitting diodes). The emitters shall be mounted to a metal core circuit board using SMT technology. The LEDs and circuit boards shall then be mounted to a high performance heat sink.

External light control shall consist of high precision refractive lenses mounted above the LED emitter arrays in such a way to achieve optimum uplight control. The lenses shall also control horizontal light distribution to that other Type II, III, IV or V IESNA distribution patterns are achieved.

LUMINAIRE CONSTRUCTION

All K118 Washington cast components shall consist of a heavy cast aluminum. The main body or capital acts as an enclosure for the driver assembly and is of adequate thickness to give sufficient structural rigidity. The capital shall have an opening at the base of the main body to allow the luminaire to be mounted to a tenon of 3/4"2" maximum diameter. The

luminaire shall be locked in place by means of heavy duty, stainless steel set-screws.

GLOBE ASSEMBLY

The protective globe shall be molded of either, rippled polycarbonate Miles Makrolon GP/OP Thermoplastic Polymer or equivalent, or rippled acrylic Acrylicite Plus Acrylic Polymer, or equivalent, having a minimum thickness of 0.125".

The globe assembly is a self-contained unit consisting of the globe, rugged cast locking ring, and the LED light engine and optical control. The LED light engine is of a modular design, and is able to be quickly removed from the globe assembly. The globe assembly is secured to a spring-tensioned, twist-locking Rotolock™ unit to allow tool-less removal of the globe, while maintaining a secure seal between the globe assembly and the main body of the luminaire, making the K118 Washington suitable for an outdoor environment.

DRIVER

The LED universal dimmable driver will be class 2 and capable of 120V - 277V or 347V - 480V input voltage, greater than 0.9 power factor, less than 20% total harmonic distortion. The case temperature of the driver can range from -40°C up to 70°C. Each LED system comes with a standard surge protection designed to withstand up to 20kV/10kA of transient line surge as per IEEE C62.41.2 C High. An in-line ferrite choke is utilized to provide protection against EFTs. The driver assembly will be mounted on a heavy duty fabricated galvanized steel bracket to allow complete tool-less maintenance. Dimming capable using 1-10vdc (0% to 100%), 0-10V PWM, or resistance.

PHOTOMETRICS

Fixtures are tested to IESNA LM79 specifications. These reports are available upon request.

CHROMATICITY

High output LEDs come standard

at 3000K & 4000K (+/- 300K with a minimum nominal 70 CRI. Additional CCT emitters are available upon request.

LUMEN MAINTENANCE
Reported (TM21) and Calculated (L70) reports are available upon request with a minimum calculated value of 100,000 hrs.

WIRING

All internal wiring and connections shall be completed so that it will be necessary only to attach the incoming supply connectors to Mate-N-Lok connectors or to a terminal block. Mate-N-Lok shall be certified for 600V operation. Internal wire connectors shall be crimp connector only and rated at 1000V and 150°C. All wiring to be CSA certified and/or UL listed, type SFF-2, SEVF-2, or SEW-2 No. 14 gauge, 150°C, 600V, and color coded for the required voltage.

THERMALS
Fixtures tested by a DOE sanctioned test facility to determine the maximum in-situ solder-point or junction-point temperatures of the LED emitters. This report is available upon request.

FINISH

Housing is finished with a 13 step KingCoat™ SuperDurable polyester TGIC powder coat. Standard colors include strobe white, brown metal, marine blue, gale gray, Chicago bronze, standard gold, standard black, federal green and rain forest. Please see our website for a complete list of colors. RAL and custom color matches are available.


MISCELLANEOUS
All external hardware and fasteners, wholly or partly exposed, shall be stainless steel alloy. All internal fasteners are stainless steel or zinc coated steel. All remaining internal hardware is stainless steel, aluminum alloy, or zinc coated steel.

WARRANTY

The K118 Washington LED luminaire comes with a 7 year limited warranty.

King Luminaire

TYPE-P1

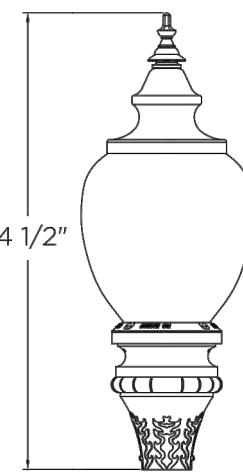

CERTIFICATION:
CSA US Listed
Suitable for wet locations
UL9001
IMPS
ARRA Compliant
LM79 / LM80 Compliant

DRIVER INFO:
≥0.9 Power Factor
≤20% Total Harmonic Distortion
120V - 277V & 347V - 480V
-40°C Min. Case Temperature
70°C Max. Case Temperature
Surge Protection: ANSI C136.2
extreme level 20kV/10kA
Dimming Capable: 1-10vdc

EPA:

1.53 sq. ft.

FIXTURE WEIGHT:

38 lbs

CSA US Listed
Suitable for wet locations
UL9001
IMPS
ARRA Compliant
LM79 / LM80 Compliant

CSA US Listed
Suitable for wet locations
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ALPHABET LEDMotors TYPE-A

Alphabet by Ledsra Brands, Inc. 88 Maxwell Irvine, CA 92618 PH: 714.259.9959 FAX: 714.259.9959 AlphabetLighting.com

NU6" Square Downlight Xicato



DESCRIPTION
The NU600 6" recessed downlight by ALPHABET offers multiple cutting edge LED technologies, premium performance, thoughtful construction and pleasing aesthetics. Offered standard with premium dimming using EddLED 1% flicker free drivers 120V-277V universal voltage. Also offered 347V. A minimalist look is achieved with an ultra-thin 1/16" trim that is only 5/16" wide. Color choices of both trim and bezel are offered for a customized look. Several beam angles and LITEOPTICS available, plus an optional high-efficiency BrightView diffused lens for smooth light distribution and obscured LED image.

HOUSING
Electrocoated 16-gauge cold-rolled steel provides enhanced structural reinforcement and rust prevention. Superior, UL-certified, injection-molded commercial grade Lexan™ (PC) is used for the frame and recessed bezel trim. Lexan provides unmatched durability and impact resistance and is tested for UV resistance and water exposure in outdoor applications. The thermally-advanced, anodized heat sink uses 6063 aluminum alloy. Wet location rated is offered standard. A 90-minute constant-power IOTA emergency battery backup is available.

MOUNTING

An advanced mounting system allows for quick and secure installation with LED and driver serviceability from below the ceiling. The LED assembly uses die-cast aluminum mounting clamp prisms (MCP) that swing out to tighten onto variable ceiling thicknesses. Integrated rubber feet on each MCP provide a non-slip vibration-resistant installation. The hidden MCP system is accessible from below ceiling by removing the snap-in lens/bezel assembly with either the included suction cup or a screwdriver blade. Integrated bar hangers feature integral locked nails. T-bar mounting kits with locking tabs for joint positioning. Recessed mounting option allows for installation from below ceiling by use of compact driver box. No risk damaging LED or bezel assembly during installation; these are isolated during test. Fixture and driver are easily removed for servicing after install without damaging drywall.

MOUNTING DIMENSIONS	CEILING THICKNESS	CEILING CUTOUT	New Construction (bar hangers included)	Mounting Length 14.3" to 18"
Trim	1/8" to 1/4"	6-5/8" square	Extension Kit only: 102588 (ordered separately)	Extends to pair of bar hangers. Test mounting length: 12" to 14"

LISTINGS	ETL	UL	1598	dETL	Listed to CSA C22.2 #250.0
- IP65 with lens - Suitable for wet locations with lens - Suitable for damp locations without lens					
- Non-conductive, Lexan dead-front construction					
- Made in the USA - meets the requirements of the Buy American provision within the ARRA					

RATINGS / CERTIFICATIONS	NC	RET	IC	ICAT	CP
Type non-IC	✓	✓	✓	✓	✓
Type IC			✓	✓	✓
Chicago Pneumatic (CPSA)				✓	✓
Reduced surface (with lens) ASTM E883	✓	✓	✓	✓	✓

NOTES	1. ETL not available in UL or ULX or ULX4. 2. ETL not available for 3000K or 4000K. Available for 2700K, 3000K, 3500K, 4000K, 4500K, and 5000K. 3. ETL not available for 3000K or 4000K. Available for 2700K, 3000K, 3500K, 4000K, 4500K, and 5000K. 4. ETL not available for 3000K or 4000K. Available for 2700K, 3000K, 3500K, 4000K, 4500K, and 5000K. 5. ETL not available for 3000K or 4000K. Available for 2700K, 3000K, 3500K, 4000K, 4500K, and 5000K. 6. ETL not available for 3000K or 4000K. Available for 2700K, 3000K, 3500K, 4000K, 4500K, and 5000K. 7. ETL not available for 3000K or 4000K. Available for 2700K, 3000K, 3500K, 4000K, 4500K, and 5000K. 8. ETL not available for 3000K or 4000K. Available for 2700K, 3000K, 3500K, 4000K, 4500K, and 5000K. 9. ETL not available for 3000K or 4000K. Available for 2700K, 3000K, 3500K, 4000K, 4500K, and 5000K. 10. ETL not available for 3000K or 4000K. Available for 2700K, 3000K, 3500K, 4000K, 4500K, and 5000K. 11. ETL not available for 3000K or 4000K. Available for 2700K, 3000K, 3500K, 4000K, 4500K, and 5000K. 12. ETL not available for 3000K or 4000K. Available for 2700K, 3000K, 3500K, 4000K, 4500K, and 5000K. 13. ETL not available for 3000K or 4000K. Available for 2700K, 3000K, 3500K, 4000K, 4500K, and 5000K. 14. ETL not available for 3000K or 4000K. Available for 2700K, 3000K, 3500K, 4000K, 4500K, and 5000K. 15. ETL not available for 3000K or 4000K. Available for 2700K, 3000K, 3500K, 4000K, 4500K, and 5000K. 16. ETL not available for 3000K or 4000K. Available for 2700K, 3000K, 3500K, 4000K, 4500K, and 5000K. 17. ETL not available for 3000K or 4000K. Available for 2700K, 3000K, 3500K, 4000K, 4500K, and 5000K. 18. ETL not available for 3000K or 4000K. Available for 2700K, 3000K, 3500K, 4000K, 4500K, and 5000K. 19. ETL not available for 3000K or 4000K. Available for 2700K, 3000K, 3500K, 4000K, 4500K, and 5000K. 20. ETL not available for 3000K or 4000K. Available for 2700K, 3000K, 3500K, 4000K, 4500K, and 5000K.
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LED INFO	- SDCI = 1x2 MacAdam Ellipse, Day +/- 0.001, Lumen Maintenance: L ₇₀ ≥ 65,000 hrs
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In a continuing effort to offer the best product possible we reserve the right to change, without notice, specifications or materials that in our opinion will not alter the function of the product.

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75 LED Narrow Strip

FIXTURE PERFORMANCE DATA


75 (NO LENS)					75R & 75S					LUMEN MAINTENANCE					AMBIENT TEMPERATURE ¹				
LED PACKAGE	WATTAGE	DELIVERED LUMENS	EFFICACY (lm/W)	DELIVERED LUMENS	EFFICACY (lm/W)	L70	L80	L90	LM	L70	L80	L90	LM	LM	LM	LM	LM	LM	
L15	10.9	1592	147.5	911	140.1	>72000	>72000	>72000	50,000	40	40	40	40	40	40	40	40	40	
L25	18.2	2652	145.7	2470	135.5	>72000	>72000	>72000	50,000	40	40	40	40	40	40	40	40	40	
L32	21.3	3092	145.5	2936	138.1	>72000	>72000	>72000	58,000	36	36	36	36	36	36	36	36	36	
L42	31.4	4344	138.5	4124	131.5	>72000	>72000	>72000	58,000	36	36	36	36	36	36	36	36	36	
L60	43.6	6052	139.0	—	—	>72,000	53,000	38,000	24,000	—	—	—	—	—	—	—	—	—	
L40	28.2	4092	145.2	3885	137.9	>72000	>72000	>72000	58,000	36,000	35	40	—	—	—	—	—	—	
L64	48.2	6593	136.9	6259	130.0	>72,000	53,000	38,000	24,000	30	35	—	—	—	—	—	—	—	
L30	19.7	3071	155.8	2916	147.9	>72000	>72000	>72000	50,000	40	40	40	40	40	40	40	40	40	
L50	33.0	5126	155.5	4867	147.6	>72000	>72000	>72000	50,000	40	40	40	40	40	40	40	40	40	
L65	42.3	6313	149.3	5994	141.7	>72000	>72000	>72000	58,000	40	40	40	40	40	40	40	40	40	
L85	56.2	8530	151.7	8098	144.0	>72,000	53,000	38,000	24,000	35	40	—	—	—	—	—	—	—	
L100	68.3	10164	148.8	9640	141.2	>72000	>72000	>72000	58,000	36,000	30	30	—	—	—	—	—	—	
L120	85.9	12105	141.0	—	—	>72,000	53,000	38,000	24,000	—	—	—	—	—	—	—	—	—	
L80	35.3	5814	164.9	5520	156.6	>72000	>72000	>72000	50,000	40	40	40	40	40	40	40	40	40	
L100	65.9	10078	152.9	9568	145.1	>72000	>72000	>72000	50,000	35	35	—	—	—	—	—	—	—	
L130	87.9	13011	148.1	12353	140.6	>72000	>72000	>72000	58,000	35	35	—	—	—	—	—	—	—	
L170	112.4	17060	151.7	16197	144.0	>72,000	53,000	38,000	24,000	35	35	—	—	—	—	—	—	—	
L200	136.5	20309	148.8	19281	141.2	>72000	>72000	>72000	58,000	36,000	30	30	—	—	—	—	—	—	
L240	171.7	24209	141.0	—	—	>72,000	53,000	38,000	24,000	—	—	—	—	—	—	—	—	—	

MULTIPLIER TABLE

COLOR TEMPERATURE		CONVERSION FACTOR
2700K	0.97	
3000K	0.99	
3500K	1.00	
4000K	1.03	
5000K	1.06	
6000K	1.09	
7000K	1.12	
8000K	1.15	
9000K	1.18	
10000K	1.21	

PHOTOMETRY

75-4-L85/R35-DIM Total Luminaire Output: 8530 lumens; 56.2 Watts | Efficacy: 152 lm/W | 80 CRI; 3500K CCT

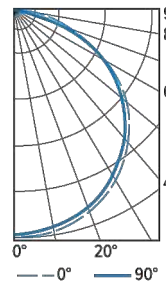


VERTICAL ANGLE					HORIZONTAL ANGLE					ZONAL LUMENS				
0°	5°	10°	15°	20°	0°	5°	10°	15°	20°	0°	5°	10°	15°	20°
0	2866	2866	2866	2866	0	2866	2866	2866	2866	0	2866	2866	2866	2866
5	2917	2887	2876	2876	5	2917	2887	2876	2876	5	2917	2887	2876	2876
10	2837	2799	2791	2791	10	2837	2799	2791	2791	10	2837	2799	2791	2791
15	2663	2624	2610	2610	15	2663	2624	2610	2610	15	2663	2624	2610	2610
20	2415	2366	2338	2338	20	2415	2366	2338	2338	20	2415	2366	2338	2338
25	2066	2006	1990	1990	25	2066	2006	1990	1990	25	2066	2006	1990	1990
30	1634	1580	1560	1560	30	1634	1580	1560	1560	30	1634	1580	1560	1560
35	1124	1069	1048	1048	35	1124	1069	1048	1048	35	1124	1069	1048	1048
40	75	581	543	531	40	75	581	543	531	40	75	581	543	531
45	104	116	101	144	45	104	116	101	144	45	104	116	101	144
50	9	14	9	9	50	9	14	9	9	50	9	14	9	9

TYPE-B


LV-OSFHU-TW-120-347

SPECIFICATIONS	
TYPE	PIR Motion
MOUNTING HEIGHT	8" - 40"
LENS	Interchangeable high bay, low bay or mask
DETECTION ANGLE	360°
TEMPERATURE RANGE	-30° to 70°C
RELATIVE HUMIDITY	20% to 90% non-condensing
MANUFACTURER	Leviton

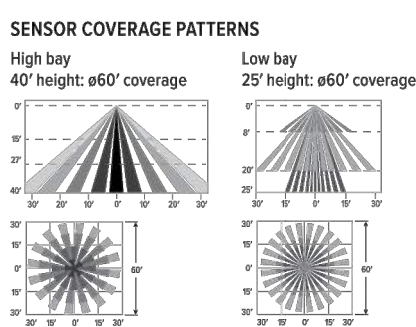


LV-ZL505-ILW

SPECIFICATIONS	
TYPE	PIR Motion + Daylight
MOUNTING HEIGHT	8" - 10"
DETECTION ANGLE	120°
TEMPERATURE RANGE	-20° to 70°C
COMMISSIONING	DIP switches or optional remote: ZL508-RA1
MANUFACTURER	Leviton

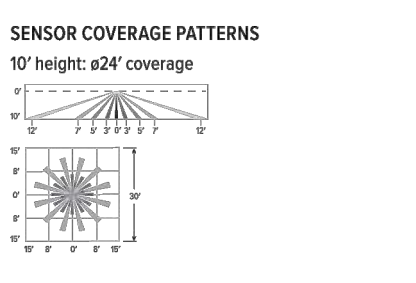

WS-FSP-311-L2-120/277

SPECIFICATIONS	
TYPE	PIR Motion + Daylight
MOUNTING HEIGHT	8" - 20"
DETECTION ANGLE	360°
TEMPERATURE RANGE	-20° to 75°C
COMMISSIONING	App (iOS or Android)
MANUFACTURER	Wattsstopper

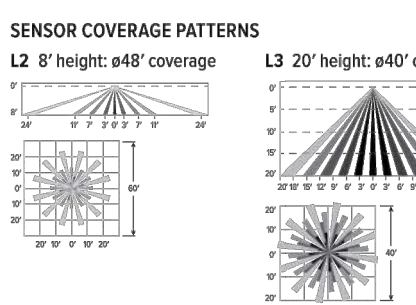

ADDITIONAL DRIVER OPTIONS


Note: Lumen restrictions apply, consult product builder at hew.com/product-builder.

CATALOG NUMBER	DESCRIPTION
DRV	Driver prewired for non-dimming applications
DIM	Dimming driver prewired for 0-10V low voltage applications
DIM1	1% dimming driver prewired for 0-10V low voltage applications
DIM LINE	Line voltage dimming driver (TRAC and DALI compatible, 120V only)
DIM TRC	Line voltage dimming driver (TRAC compatible, 120V only)
DA	Dimming driver with 12V auxiliary
DSR	Scene-ready driver
SD40	40% step-dimming driver
SD50	50% step-dimming driver
DALI	DALI dimming driver
LYE LINE	Lutron H-Lume 1% 2-wire dimming driver forward phase line voltage controls (120V only)
LYE	Lutron H-Lume 1% EcoSystem dimming LED driver
ELDO SOLDB	EldoLED Solobrite, 0.1% dimming driver for 0-10V controls
ELDO SOLDB DALI	EldoLED Solobrite, 0.1% dimming driver for DALI controls
ELDO ECO1	EldoLED EcoDrive, 1% dimming driver for 0-10V controls
ELDO ECO1 DALI	EldoLED EcoDrive, 1% dimming driver for DALI controls

75 LED Narrow Strip


TYPE-B

75R-4-L85/R35 Total Luminaire Output: 8098 lumens; 56.2 Watts | Efficacy: 144 lm/W | 80 CRI; 3500K CCT

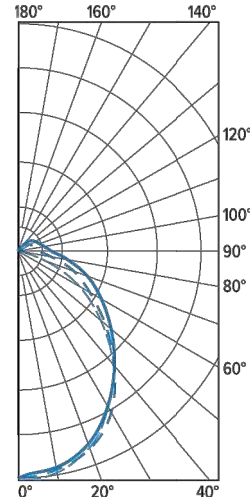

VERTICAL ANGLE					HORIZONTAL ANGLE					ZONAL LUMENS				
0°	5°	10°	15°	20°	0°	5°	10°	15°	20°	0°	5°	10°	15°	20°
0	2732	2732	2732	2732	0	2732	2732	2732	2732	0	2732	2732	2732	2732
5	2736	2720	2682	258	5	2736	2720	2682	258	5	2736	2720	2682	258
10	2633	2611	2579	734	10	2633	2611	2579	734	10	2633	2611	2579	734
15	2331	2262	2233	1083	15	2331	2262	2233	1083	15	2331	2262	2233	1083
20	1969	2000	1965	1447	20	1969	2000	1965	1447	20	1969	2000	1965	1447
25	1536	1554	1583	1009	25	1536	1554	1583	1009	25	1536	1554	1583	1009
30	1023	1050	1091	651	30	1023	1050	1091	651	30	1023	1050	1091	651
35	618	640	672	332	35	618	640	672	332	35	618	640	672	332
40	270	242	245	163	40	270	242	245	163	40	270	242	245	163
45	41	323	491	332	45	41	323	491	332	45	41	323	491	332
50	0	246	390	223	50	0	246	390	223	50	0	246	390	223
55	0	129	244	110	55	0	129	244	110	55	0	129	244	110
60	0	96	166	71	60	0	96	166	71	60	0	96	166	71
65	0	58	110	38	65	0	58	110	38	65	0	58	110	38
70	0	36	63	16	70	0	36	63	16	70	0	36	63	16
75	0	17	31	4	75	0	17	31	4	75	0	17	31	4
80	0	0	0	0	80	0	0	0	0	80	0	0	0	0
85	0	0	0	0	85	0	0	0	0	85	0	0	0	0
90	0	0	0	0	90	0	0	0	0	90	0	0	0	0

75S-4-L85/R35 Total Luminaire Output: 8098 lumens; 56.2 Watts | Efficacy: 144 lm/W | 80 CRI; 3500K CCT

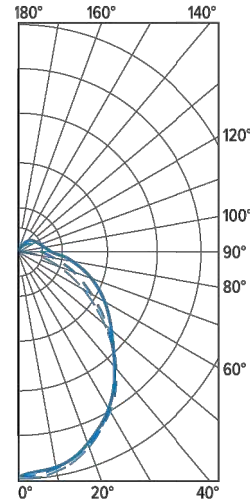

VERTICAL ANGLE	HORIZONTAL ANGLE				ZONAL LUMENS
	45°	90°	135°	180°	
0	2732	2732	2732	2732	
5	2736	2720	2682	258	
15	2633	2611	2579	734	
25	2331	2262	2233	1083	
35	1969	2000	1965	1247	
45	1536	1554	1583	1009	
55	1053	1160	1291	651	
65	618	840	1072	332	
75	270	542	745	163	
85	47	323	491	332	
95	0	245	390	270	
105	0	230	344	232	
115	0	200	291	185	
125	0	177	256	149	
135	0	159	216	110	
145	0	136	166	71	
155	0	58	113	28	
165	0	36	63	11	
175	0	17	31	4	
180	0	0	0	0	